2024 Green Infrastructure Upgrades

Forest Home Avenue School, Site #173

1516 W Forest Home Avenue Milwaukee, WI 53204

JANUARY 25, 2024 100% CONSTRUCTION DOCUMENTS

MPS Project Number: 8317 SmithGroup Project Number:14895

Table of Contents

Sheet Number	Sheet Title
G001	COVER SHEET
G002	GENERAL NOTES AND LEGEND
CV100	EXISTING CONDITIONS
CV101	EXISTING CONDITIONS
CE100	SITE PREPARATION AND EROSION CONTRO
CS100	SITE LAYOUT
CG100	GRADING PLAN
CU100	UTILITIES PLAN
CP100	PAVEMENT MARKINGS PLAN
CE500	EROSION CONTROL DETAILS
CS500	SITE DETAILS
CS501	SITE DETAILS
CS502	SITE DETAILS
CS503	SITE DETAILS
CS504	SITE DETAILS
CU500	UTILITY DETAILS
CU501	UTILITY DETAILS
CU502	UTILITY DETAILS
CP500	PAVEMENT MARKING DETAILS
CP501	PAVEMENT MARKINGS DETAILS
L300	PLANTING PLAN
L301	PLANTING PLAN ENLARGEMENTS
L500	PLANTING NOTES AND DETAILS
L501	PLANTING DETAILS
L502	PLANTING SCHEDULE
L503	PLANTING SCHEDULE

Prepared for:



Milwaukee Public Schools 5225 W. Vliet Street Milwaukee, WI 53208 Switchboard: (414) 475-8393

Prepared by:

SMITHGROUP

MILWAUKEE, WI 53202 www.smithgroup.com



1836 W. FOND DU LAC AVE. MILWAUKEE, WI 53205 414.622.0103

DEDUCT ALTERNATES

BASE BID INCLUDES THE PREPARATION, INSTALLATION, AND LANDSCAPING OF THE WAUSAU CIRCULAR PLANTER AND THE RETAINING WALL BENCHES AS SHOWN ON THE PLANS. DEDUCT ALTERNATE INCLUDES: NO CIRCULAR CONCRETE PLANTER, TREES, AND VEGETATION. THE AREA IS MILLED AND OVERLAY MATCHING SURROUNDING SURFACE AND

- PAINTED WITH MPS ALPHABET GAME AS INDICATED ON THE PLAN. NO CONCRETE RETAINING WALL BENCH OR FOUNDATION. THE AREA IS GRADED AT A 5H:1V MAXIMUM AND SODDED TO THE PERMEABLE PAVERS.
- DEDUCT ALT<u>ERNATE 2 OUTDOOR CLASSROOM C</u>
- BASE BID INCLUDES THE PREPARATION, INSTALLATION, AND LANDSCAPING OF THE OUTDOOR CLASSROOM C. DEDUCT ALTERNATE INCLUDES: NO REMOVAL OF ASPHALT, NO NEW TOPSOIL AND LANDSCAPING OR TREES, AND NO CHAIN LINK FENCE. THE SALVAGED PICNIC TABLES TO BE PLACED ADJACENT TO THE STORAGE SHED UNDER THE DIRECTION OF MPS.

DEDUCT ALTERNATE 3 - FRONT ENTRANCE IMPROVEMENTS

BASE BID INCLUDES THE PREPARATION, INSTALLATION, AND LANDSCAPING OF THE FRONT ENTRANCE IMPROVEMENTS. DEDUCT ALTERNATE


NO REMOVAL OF ASPHALT WITHIN THE TOT-LOT FENCE OR OUTSIDE OF THE TOT-LOT FENCE, NO MILLING OF ASPHALT, NO NEW TOPSOIL AND LANDSCAPING OR TREES, NO CONCRETE PADS FOR BENCHES, NO NEW BENCHES, NO NEW ASPHALT OVERLAY, AND NO PAINTED PLAY.




PROJECT VICINITY MAP





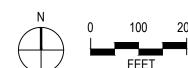

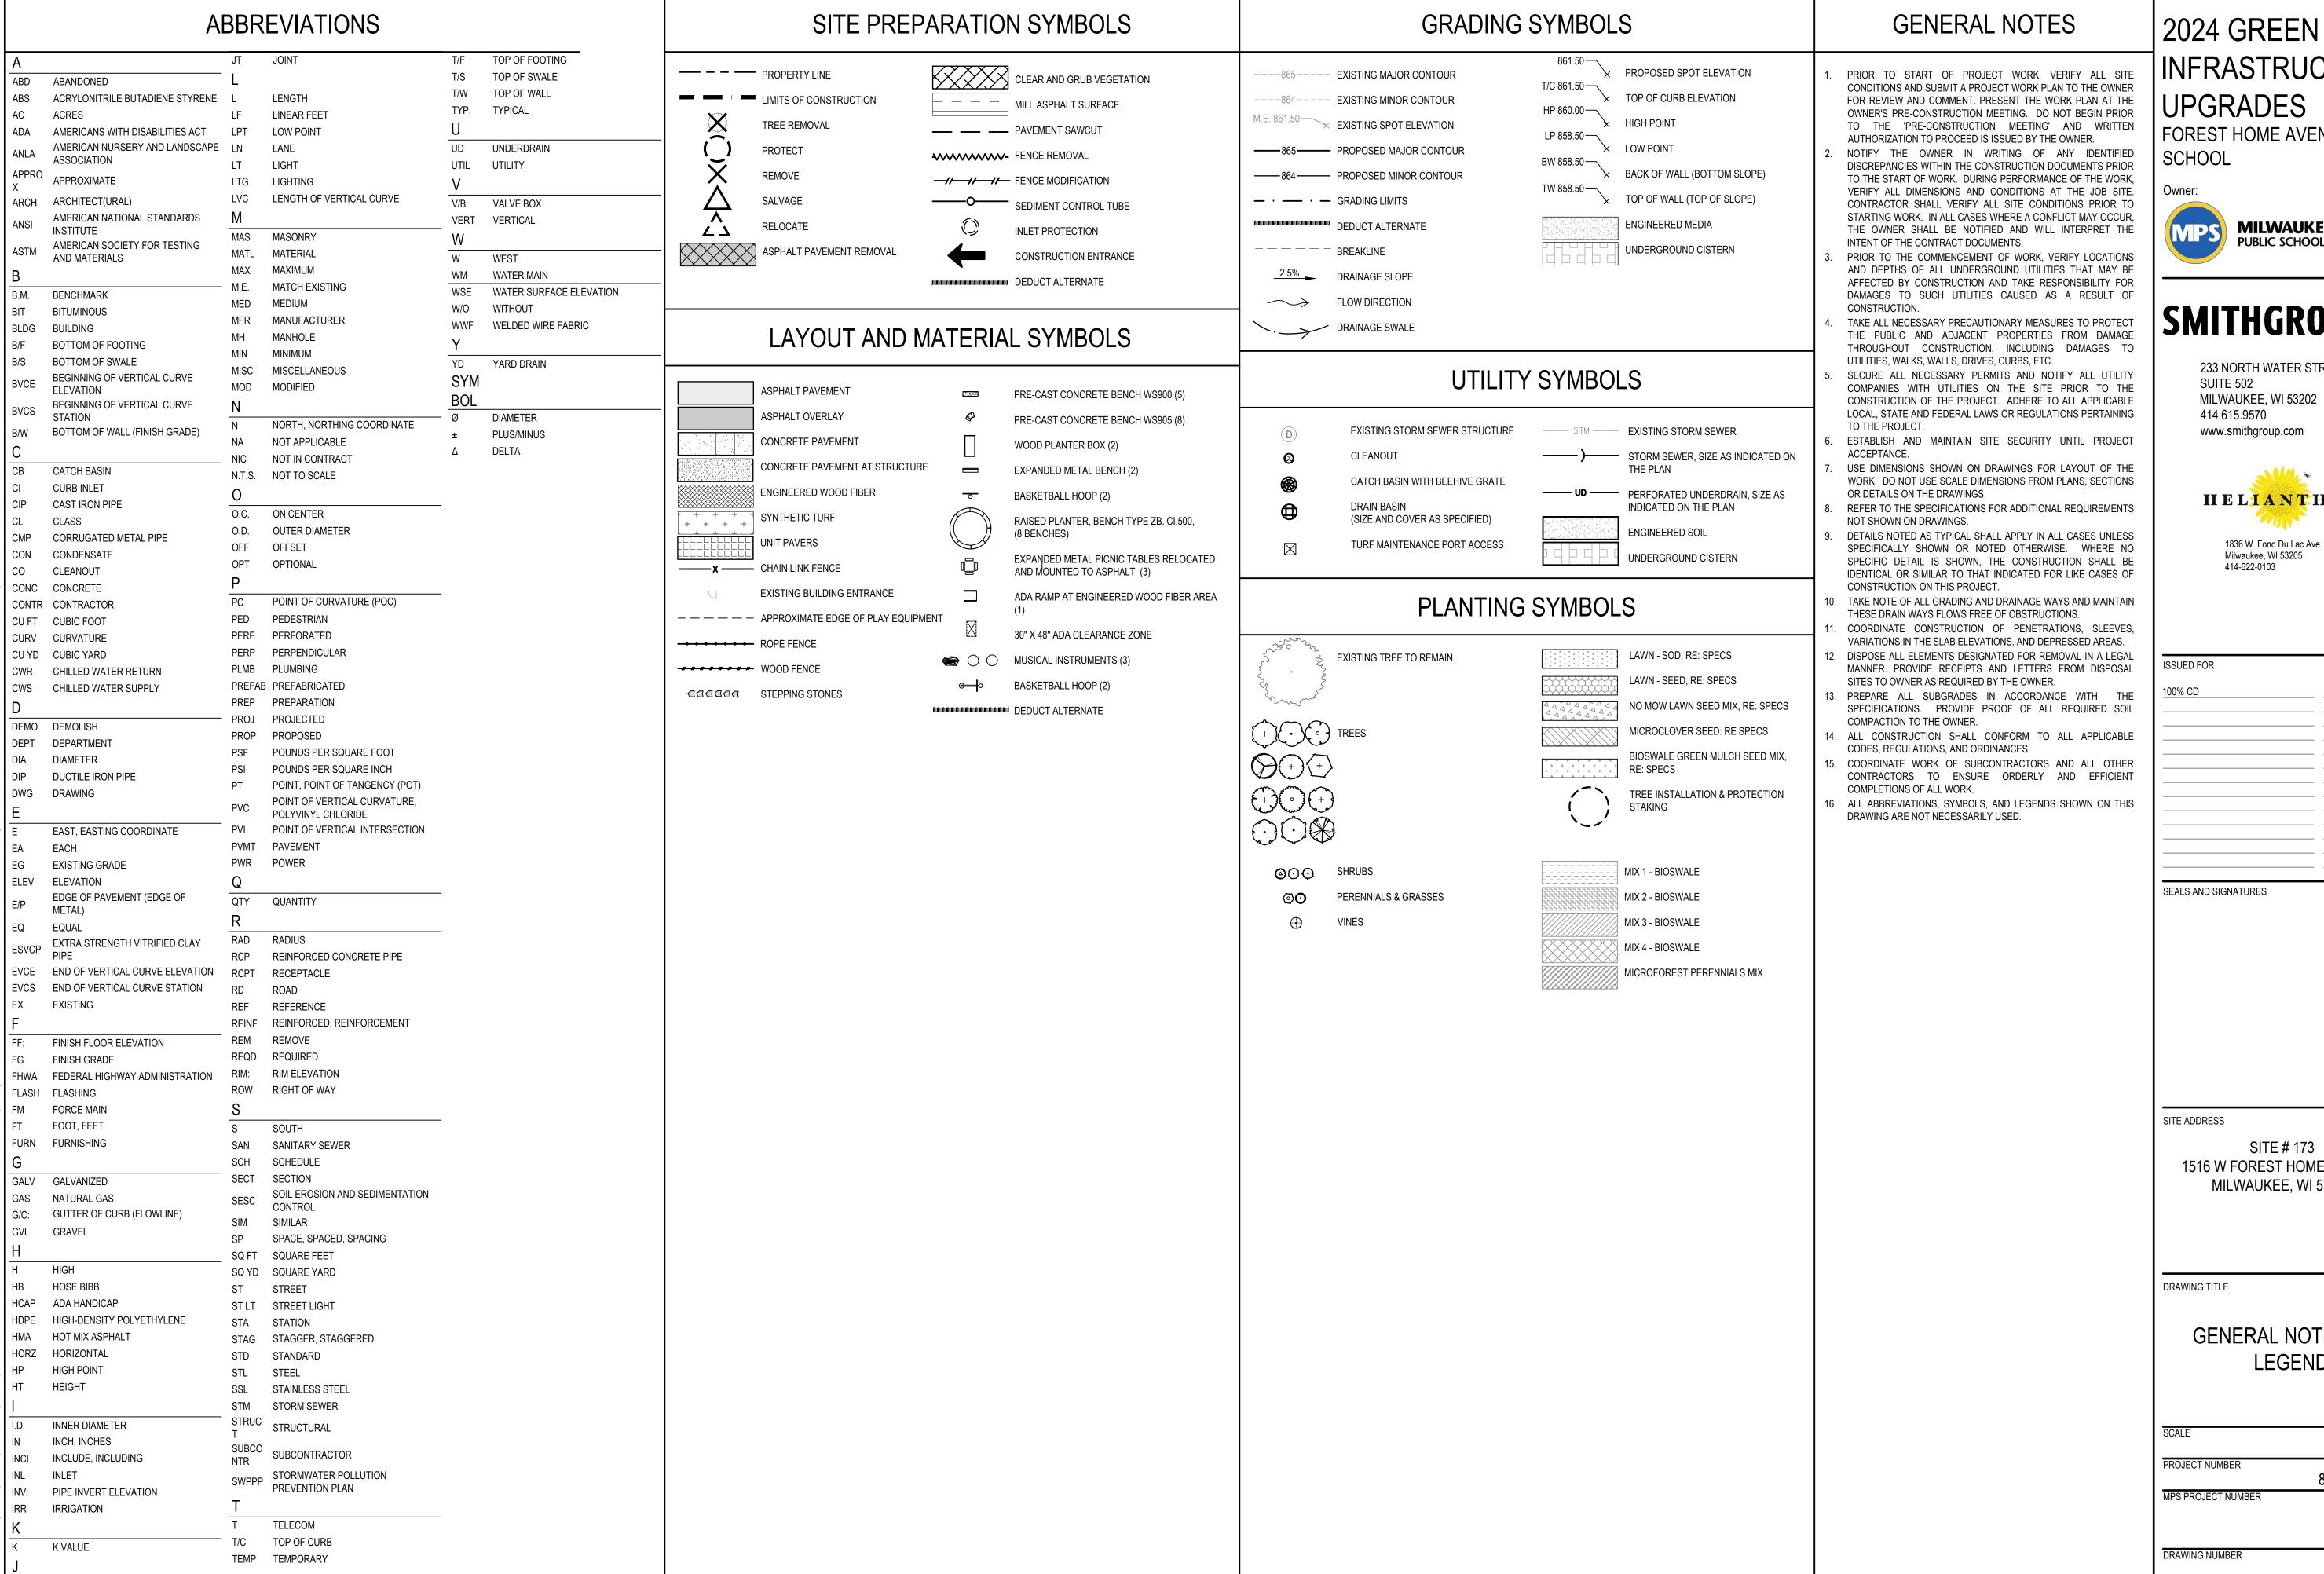

INFRASTRUCTURE **UPGRADES** FOREST HOME AVENUE



SMITHGROUP

233 NORTH WATER STREET SUITE 502 MILWAUKEE. WI 53202 414.615.9570 www.smithgroup.com



1836 W. Fond Du Lac Ave. Milwaukee, WI 53205 414-622-0103


ISSUED FOR	REV	DATE
100% CD		01/25/2024
	_	

SITE # 173 1516 W FOREST HOME AVENUE MILWAUKEE, WI 53204

GENERAL NOTES AND LEGEND

SOALE	1489
PROJECT NUMBER	8317, DIVISION
MPS PROJECT NUMBER	_

G002

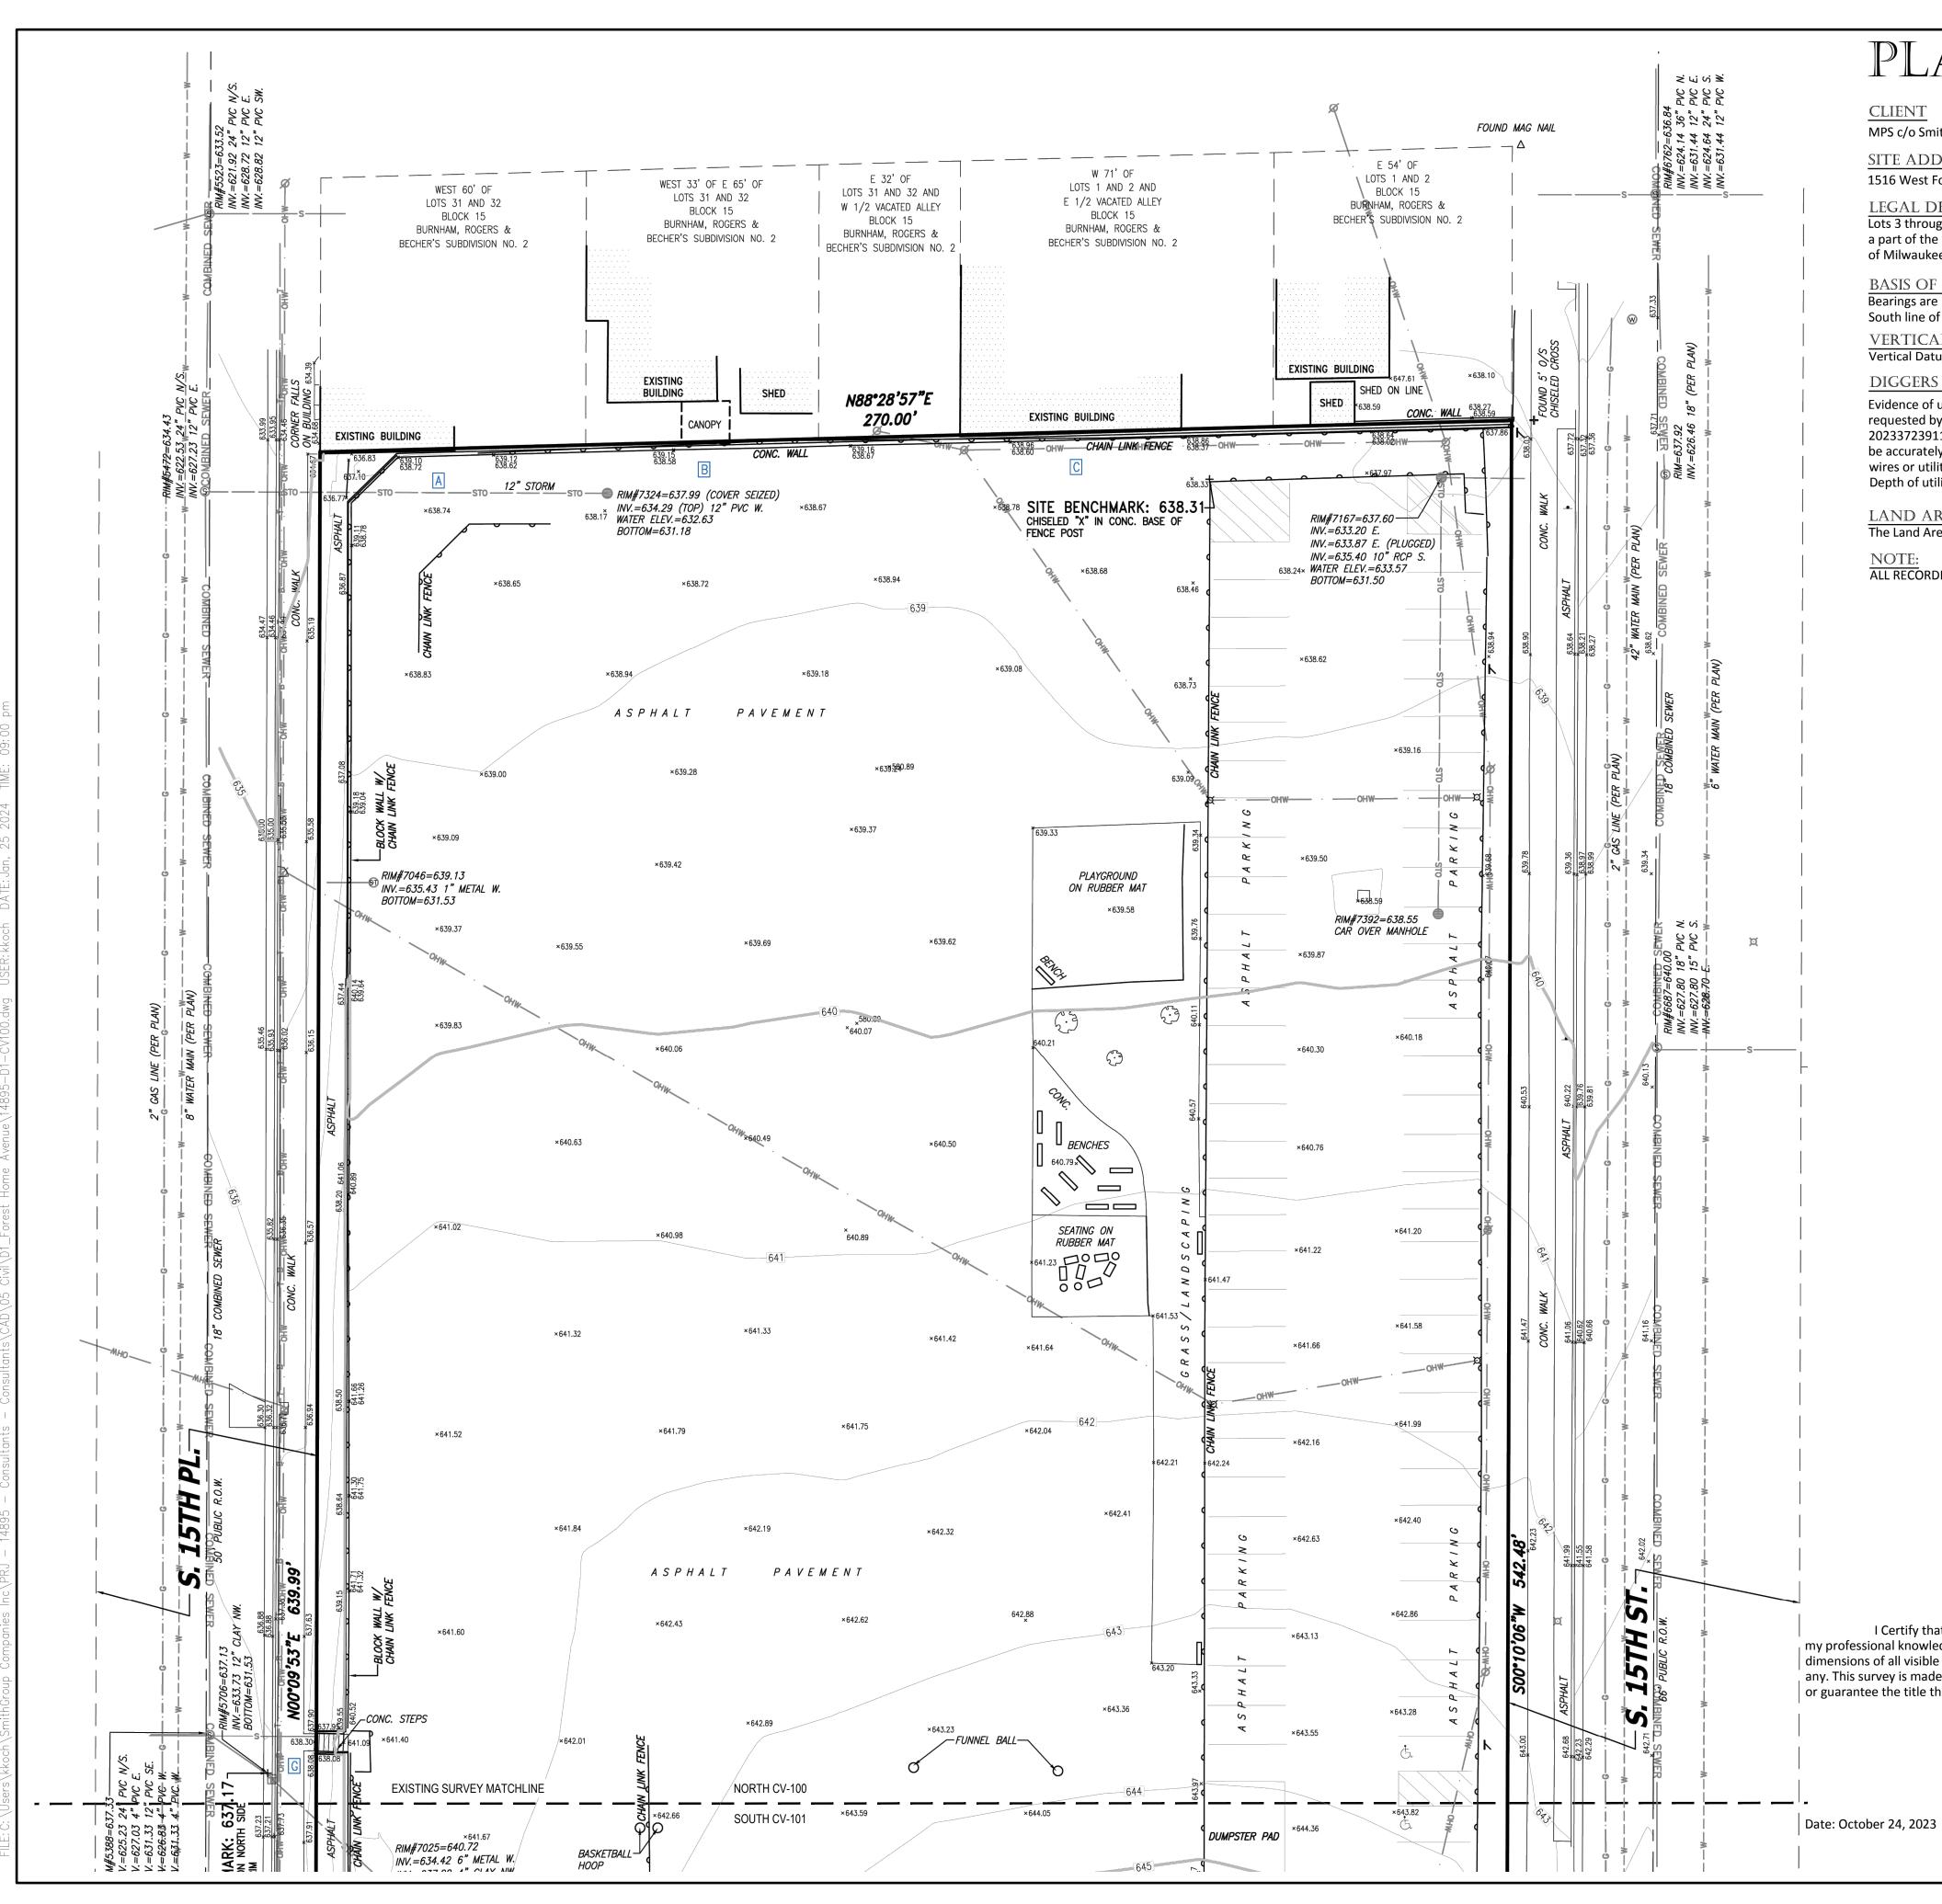

PLAT OF SURVEY

MPS c/o Smith Group

SITE ADDRESS

1516 West Forest Home Avenue, City of Milwaukee, County of Milwaukee, Wisconsin

LEGAL DESCRIPTION

Lots 3 through 30 in Block 15 and the vacated alley, inclusive, all in Burnham, Rogers & Becher's Subdivision being a part of the Southeast 1/4 of the Northeast 1/4 of Section 6, Township 6 North, Range 22 East, located in the City of Milwaukee, Milwaukee County, Wisconsin.

BASIS OF BEARINGS

Bearings are referenced to the Wisconsin State Plane Coordinate System (South Zone) NAD83, in which the South line of the NE 1/4 bears N89°54'40"E.

VERTICAL DATUM

Vertical Datum is based on National Geodetic Vertical Datum of 1988

DIGGERS HOTLINE

Evidence of underground utilities existing on or serving the surveyed property as determined by markings requested by the surveyor pursuant to a Diggers Hotline One-call center utility locate. Ticket Number 20233723911 and 20233723924. However, lacking excavation, the exact location of underground features cannot be accurately, completely, and reliably depicted. Client understands only utility lines with imbedded electric tracer wires or utilities made of materials capable of electric connectivity can be marked at the surface and located. Depth of utilities may prohibit their location even with electric connectivity.

The Land Area of the subject property is 166,589 square feet or 3.8244 acres.


ALL RECORDED EASEMENTS MAY NOT BE SHOWN.

VICINITY MAP



	ENCROACHMENT TABLE
Α	BUILDING 0.4' SOUTH OF PROPERTY LINE
В	CANOPY 0.5' SOUTH OF PROPERTY LINE
C	BUILDING 0.3' SOUTH OF PROPERTY LINE
D	FENCE 0.3' EAST OF PROPERTY LINE
Е	WALL 0.3' SOUTH OF PROPERTY LINE
F	WALL 0.9' WEST OF PROPERTY LINE

WALL 0.3' WEST OF PROPERTY LINE

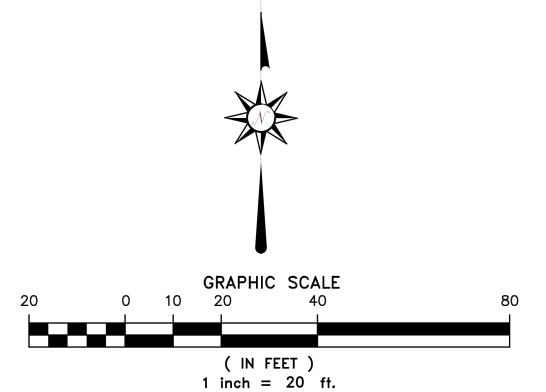

I Certify that I have surveyed the above described property (Property), and the above map is correct to the best of my professional knowledge and belief and shows the size and location of the Property, its exterior boundaries, the location and dimensions of all visible structures thereon, boundary fences, apparent easements and roadways and visible encroachments, if any. This survey is made for the exclusive use of the present owners of the Property, and also those who purchase, mortgage, or guarantee the title thereto, within one (1) year from date hereof.

GERMANTOWN •

🕶 🗘 Daniel E. Bednar Rrofessional Land Surveyor Registration Number S-2812

2024 GREEN INFRASTRUCTURE UPGRADES

FOREST HOME AVENUE SCHOOL

Owner:



SMITHGROUP

233 NORTH WATER STREET SUITE 502 MILWAUKEE, WI 53202 414.615.9570 www.smithgroup.com



1836 W. Fond Du Lac Ave. Milwaukee, WI 53205 414-622-0103

SSUED FOR	REV	DATE
00% CD		01/25/2024

SITE ADDRESS

SEALS AND SIGNATURES


SITE # 173 1516 W FOREST HOME AVENUE MILWAUKEE, WI 53204

DRAWING TITLE

EXISTING CONDITIONS

	CV100
MPS PROJECT NUMBER	
	8317, DIVISION
PROJECT NUMBER	
SCALE	1489
20415	

DRAWING NUMBER

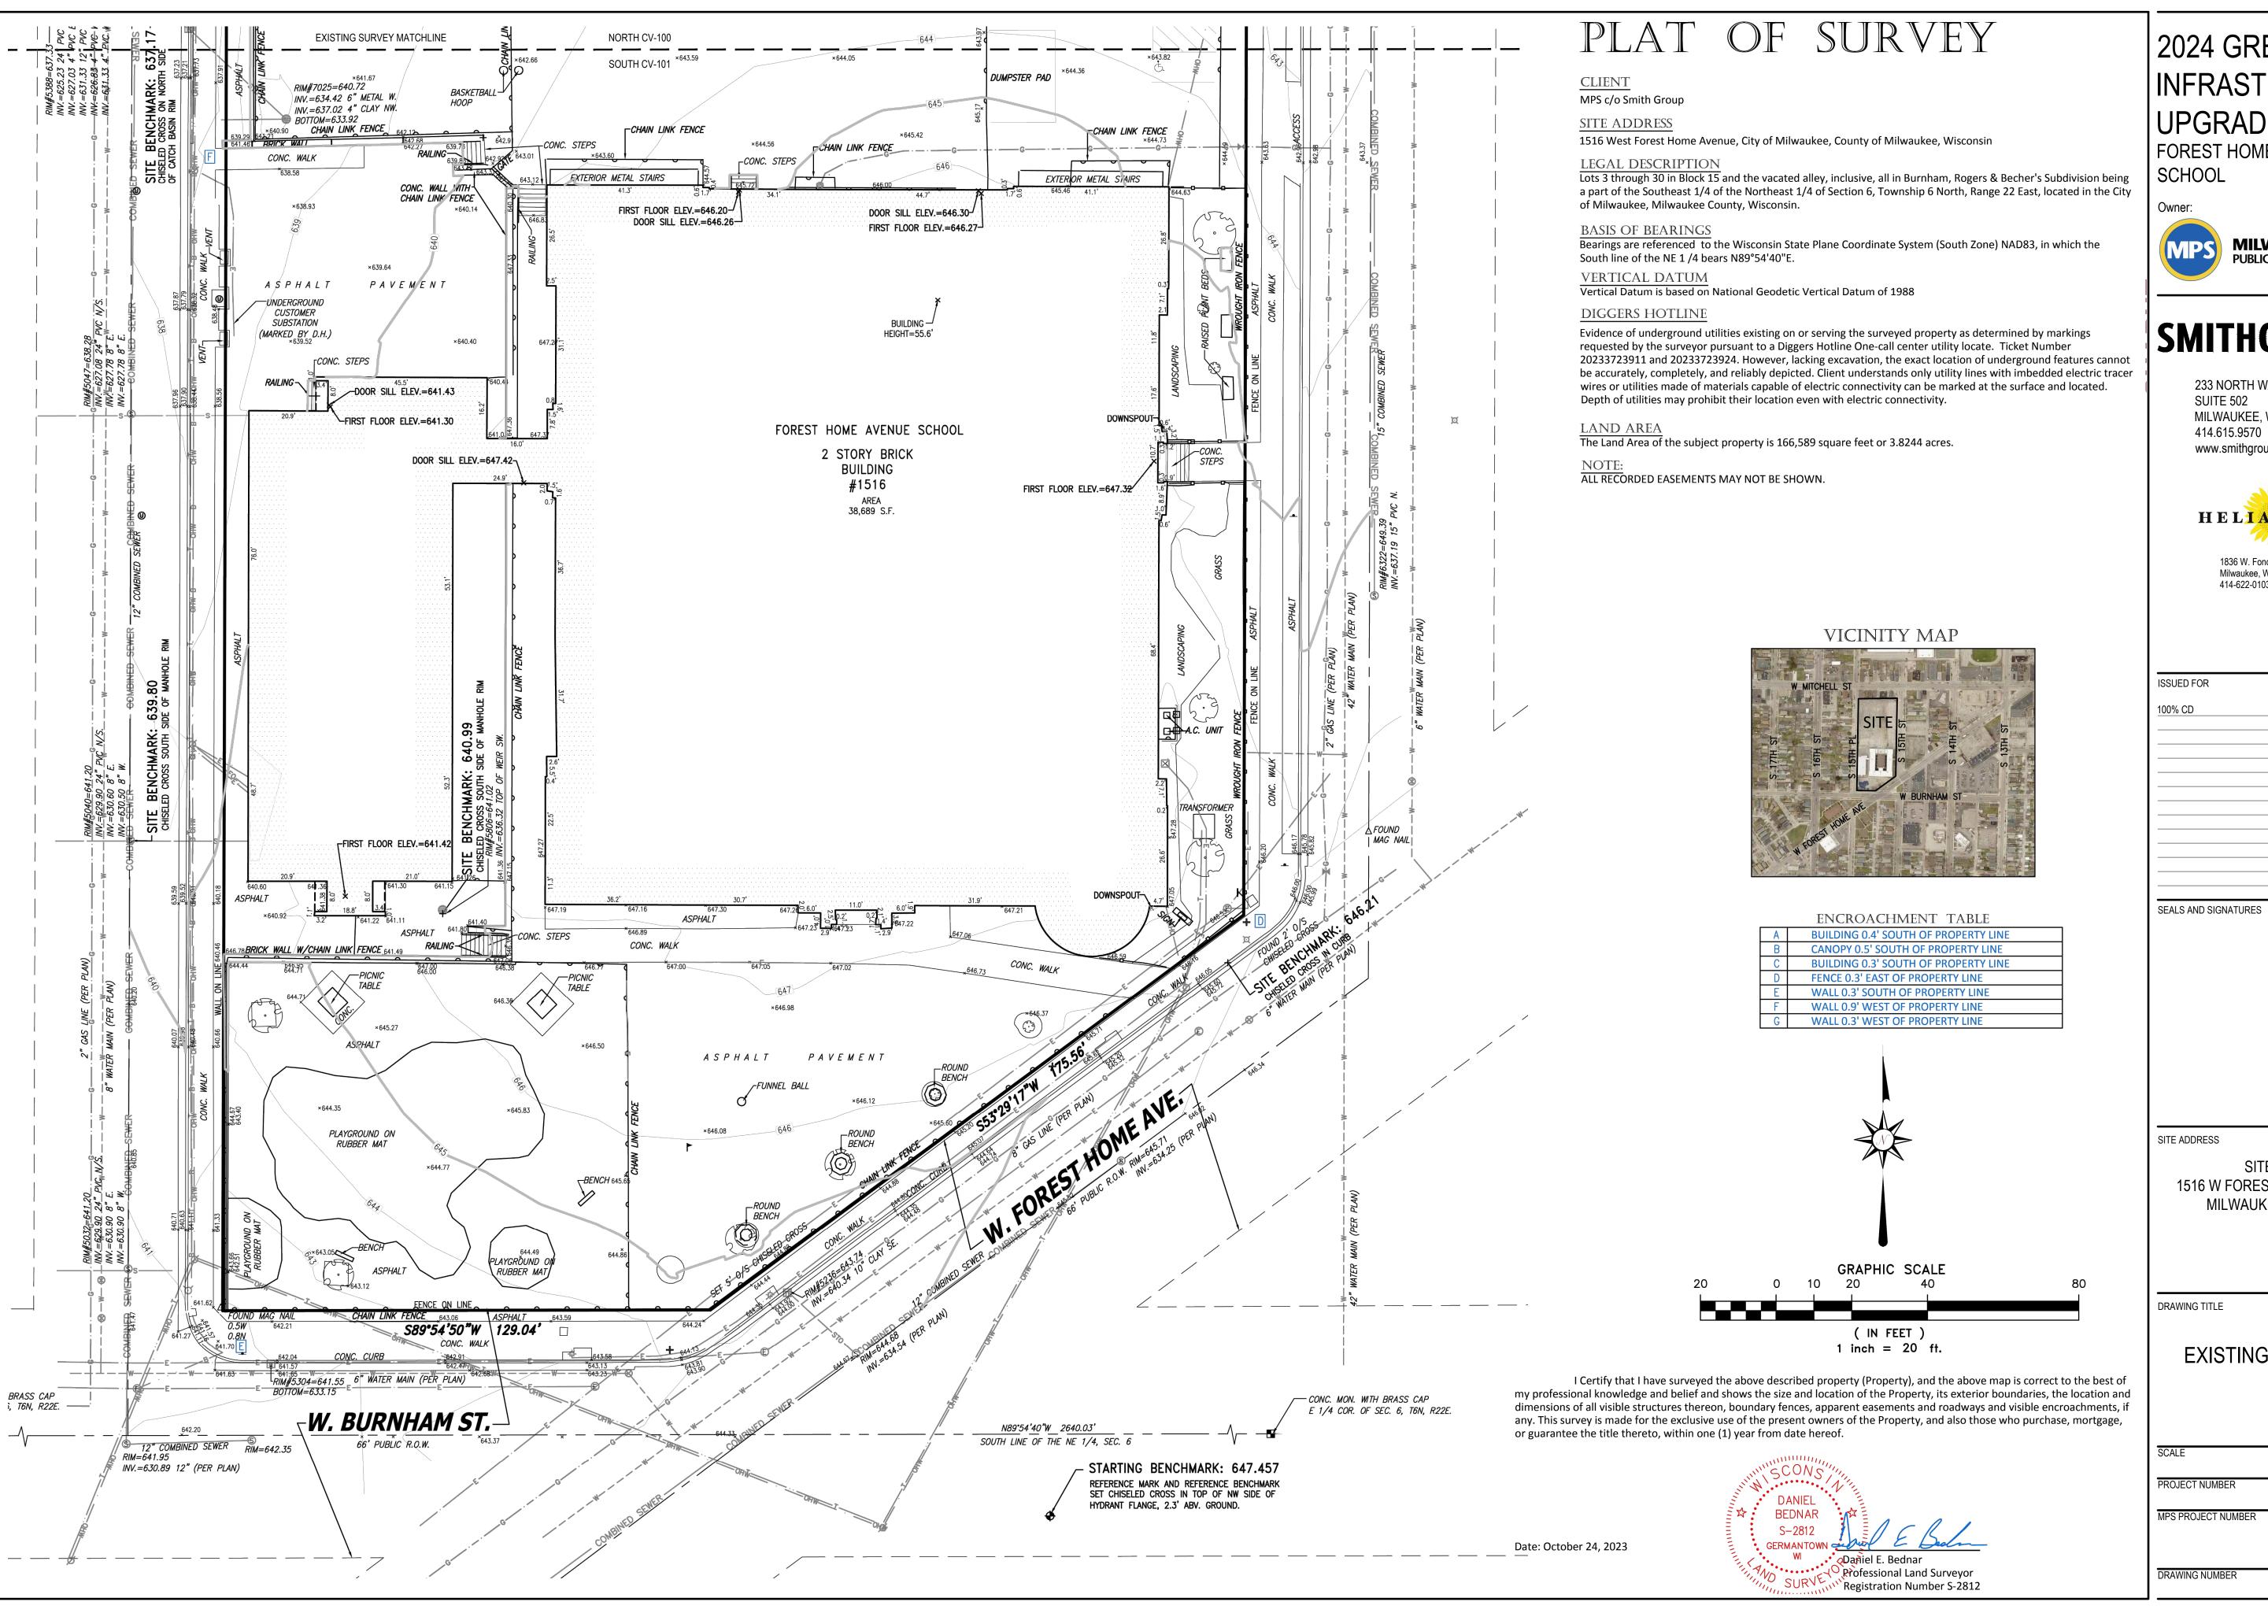

2024 GREEN INFRASTRUCTURE UPGRADES

FOREST HOME AVENUE SCHOOL

Owner:



SMITHGROUP

233 NORTH WATER STREET SUITE 502 MILWAUKEE, WI 53202 414.615.9570 www.smithgroup.com



1836 W. Fond Du Lac Ave. Milwaukee, WI 53205 414-622-0103


ISSUED FOR	REV	DATE
100% CD		01/25/2024
	_	
	_	
	_	

SITE # 173 1516 W FOREST HOME AVENUE MILWAUKEE, WI 53204

DRAWING TITLE

EXISTING CONDITIONS

	CV10
MPS PROJECT NUMBER	
	8317, DIVISIOA
PROJECT NUMBER	
SCALE	1489

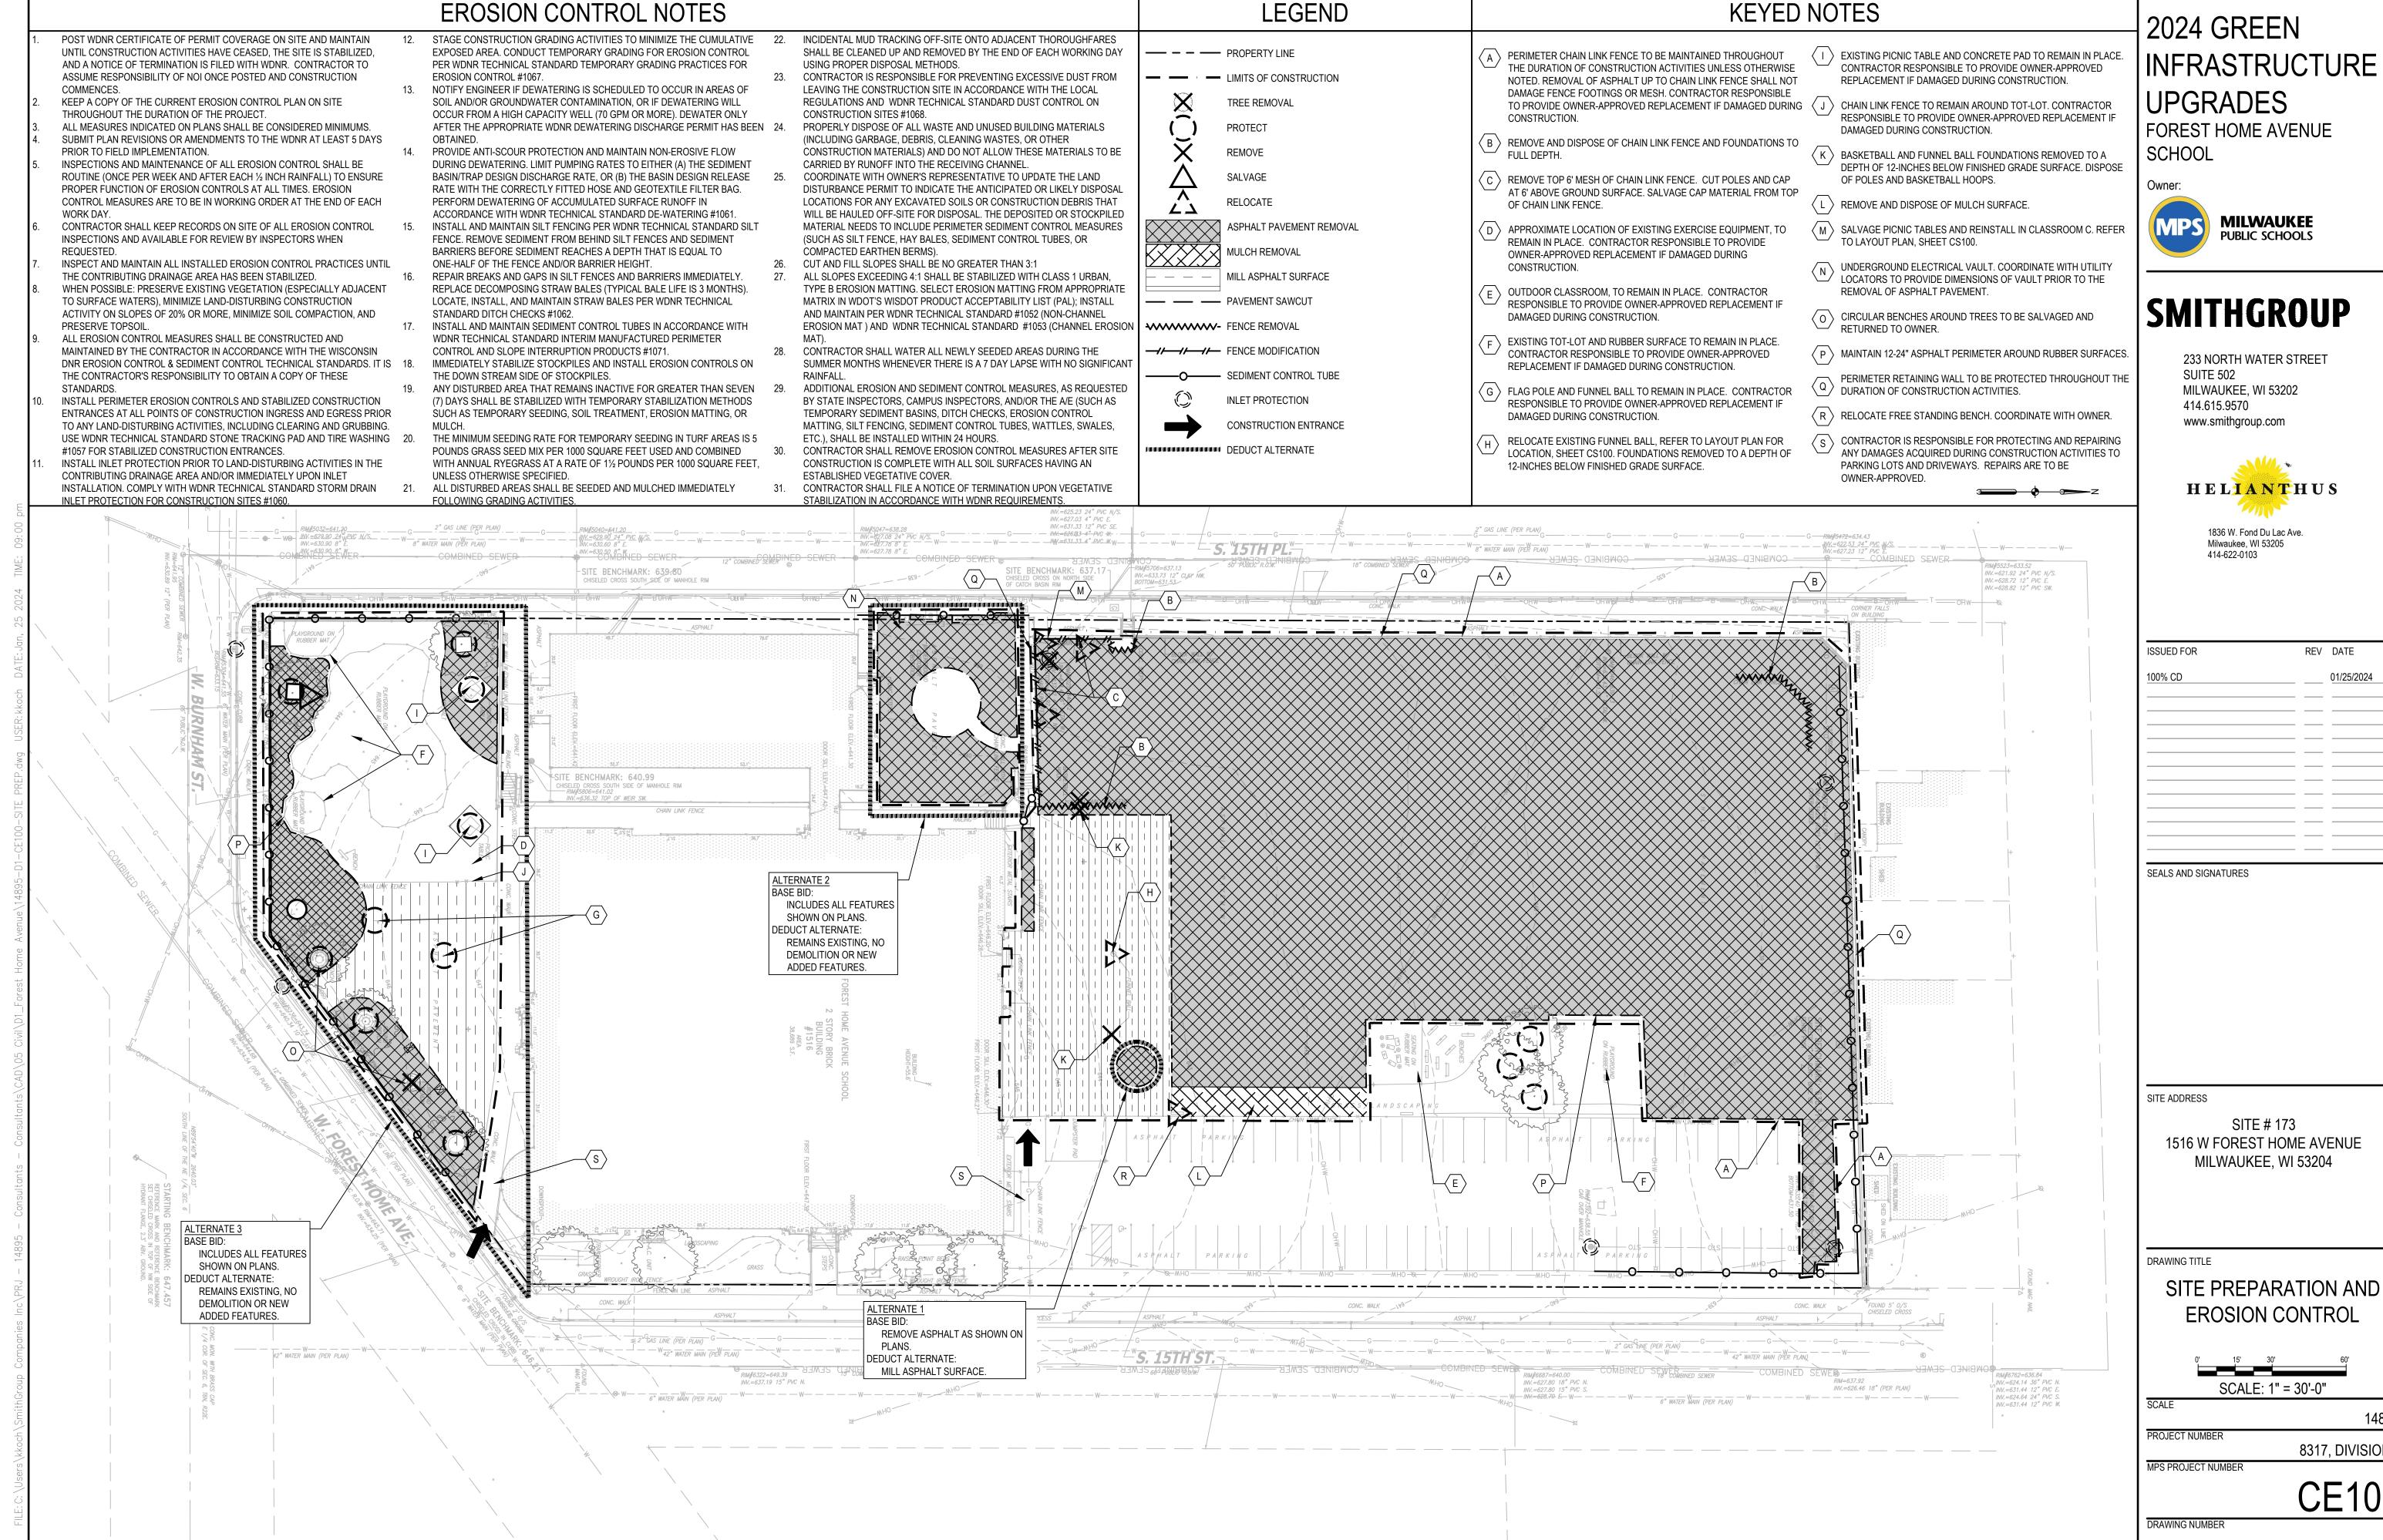


REV DATE


EROSION CONTROL


8317, DIVISION


CE100

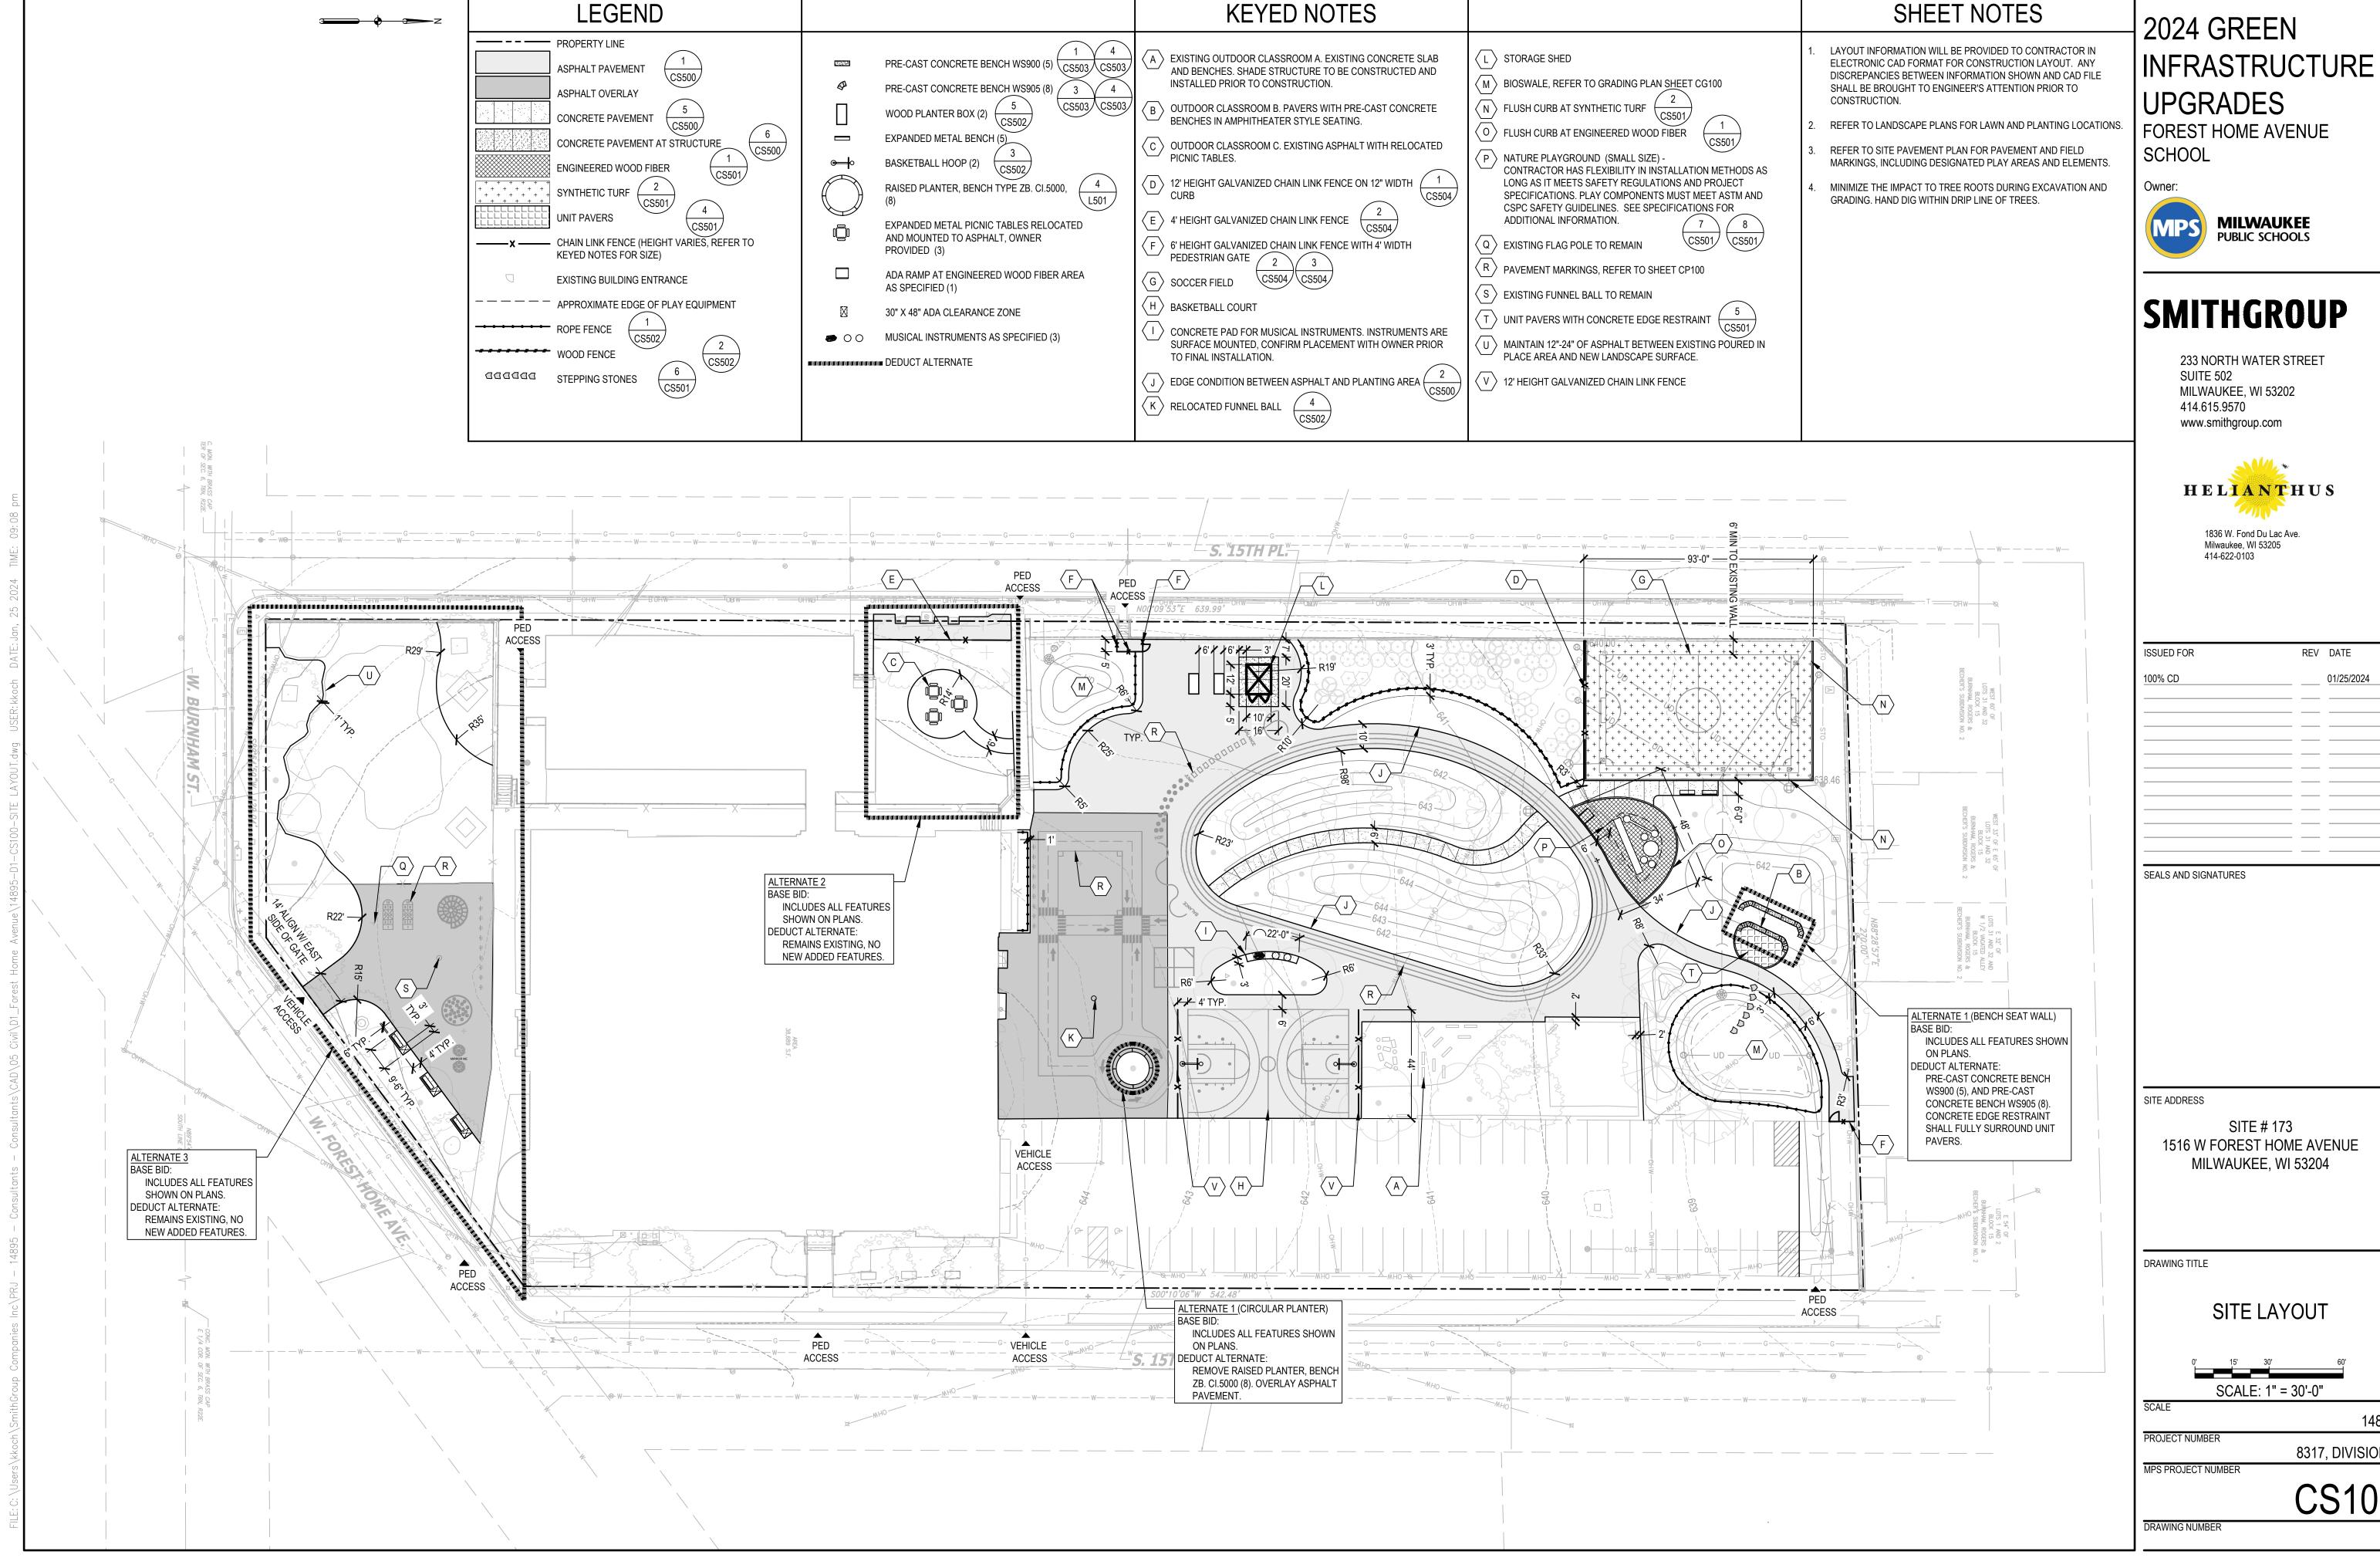

ISSUED FOR	REV	DATE
100% CD		01/25/2024

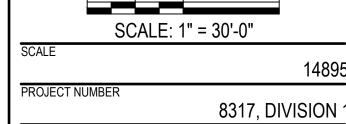


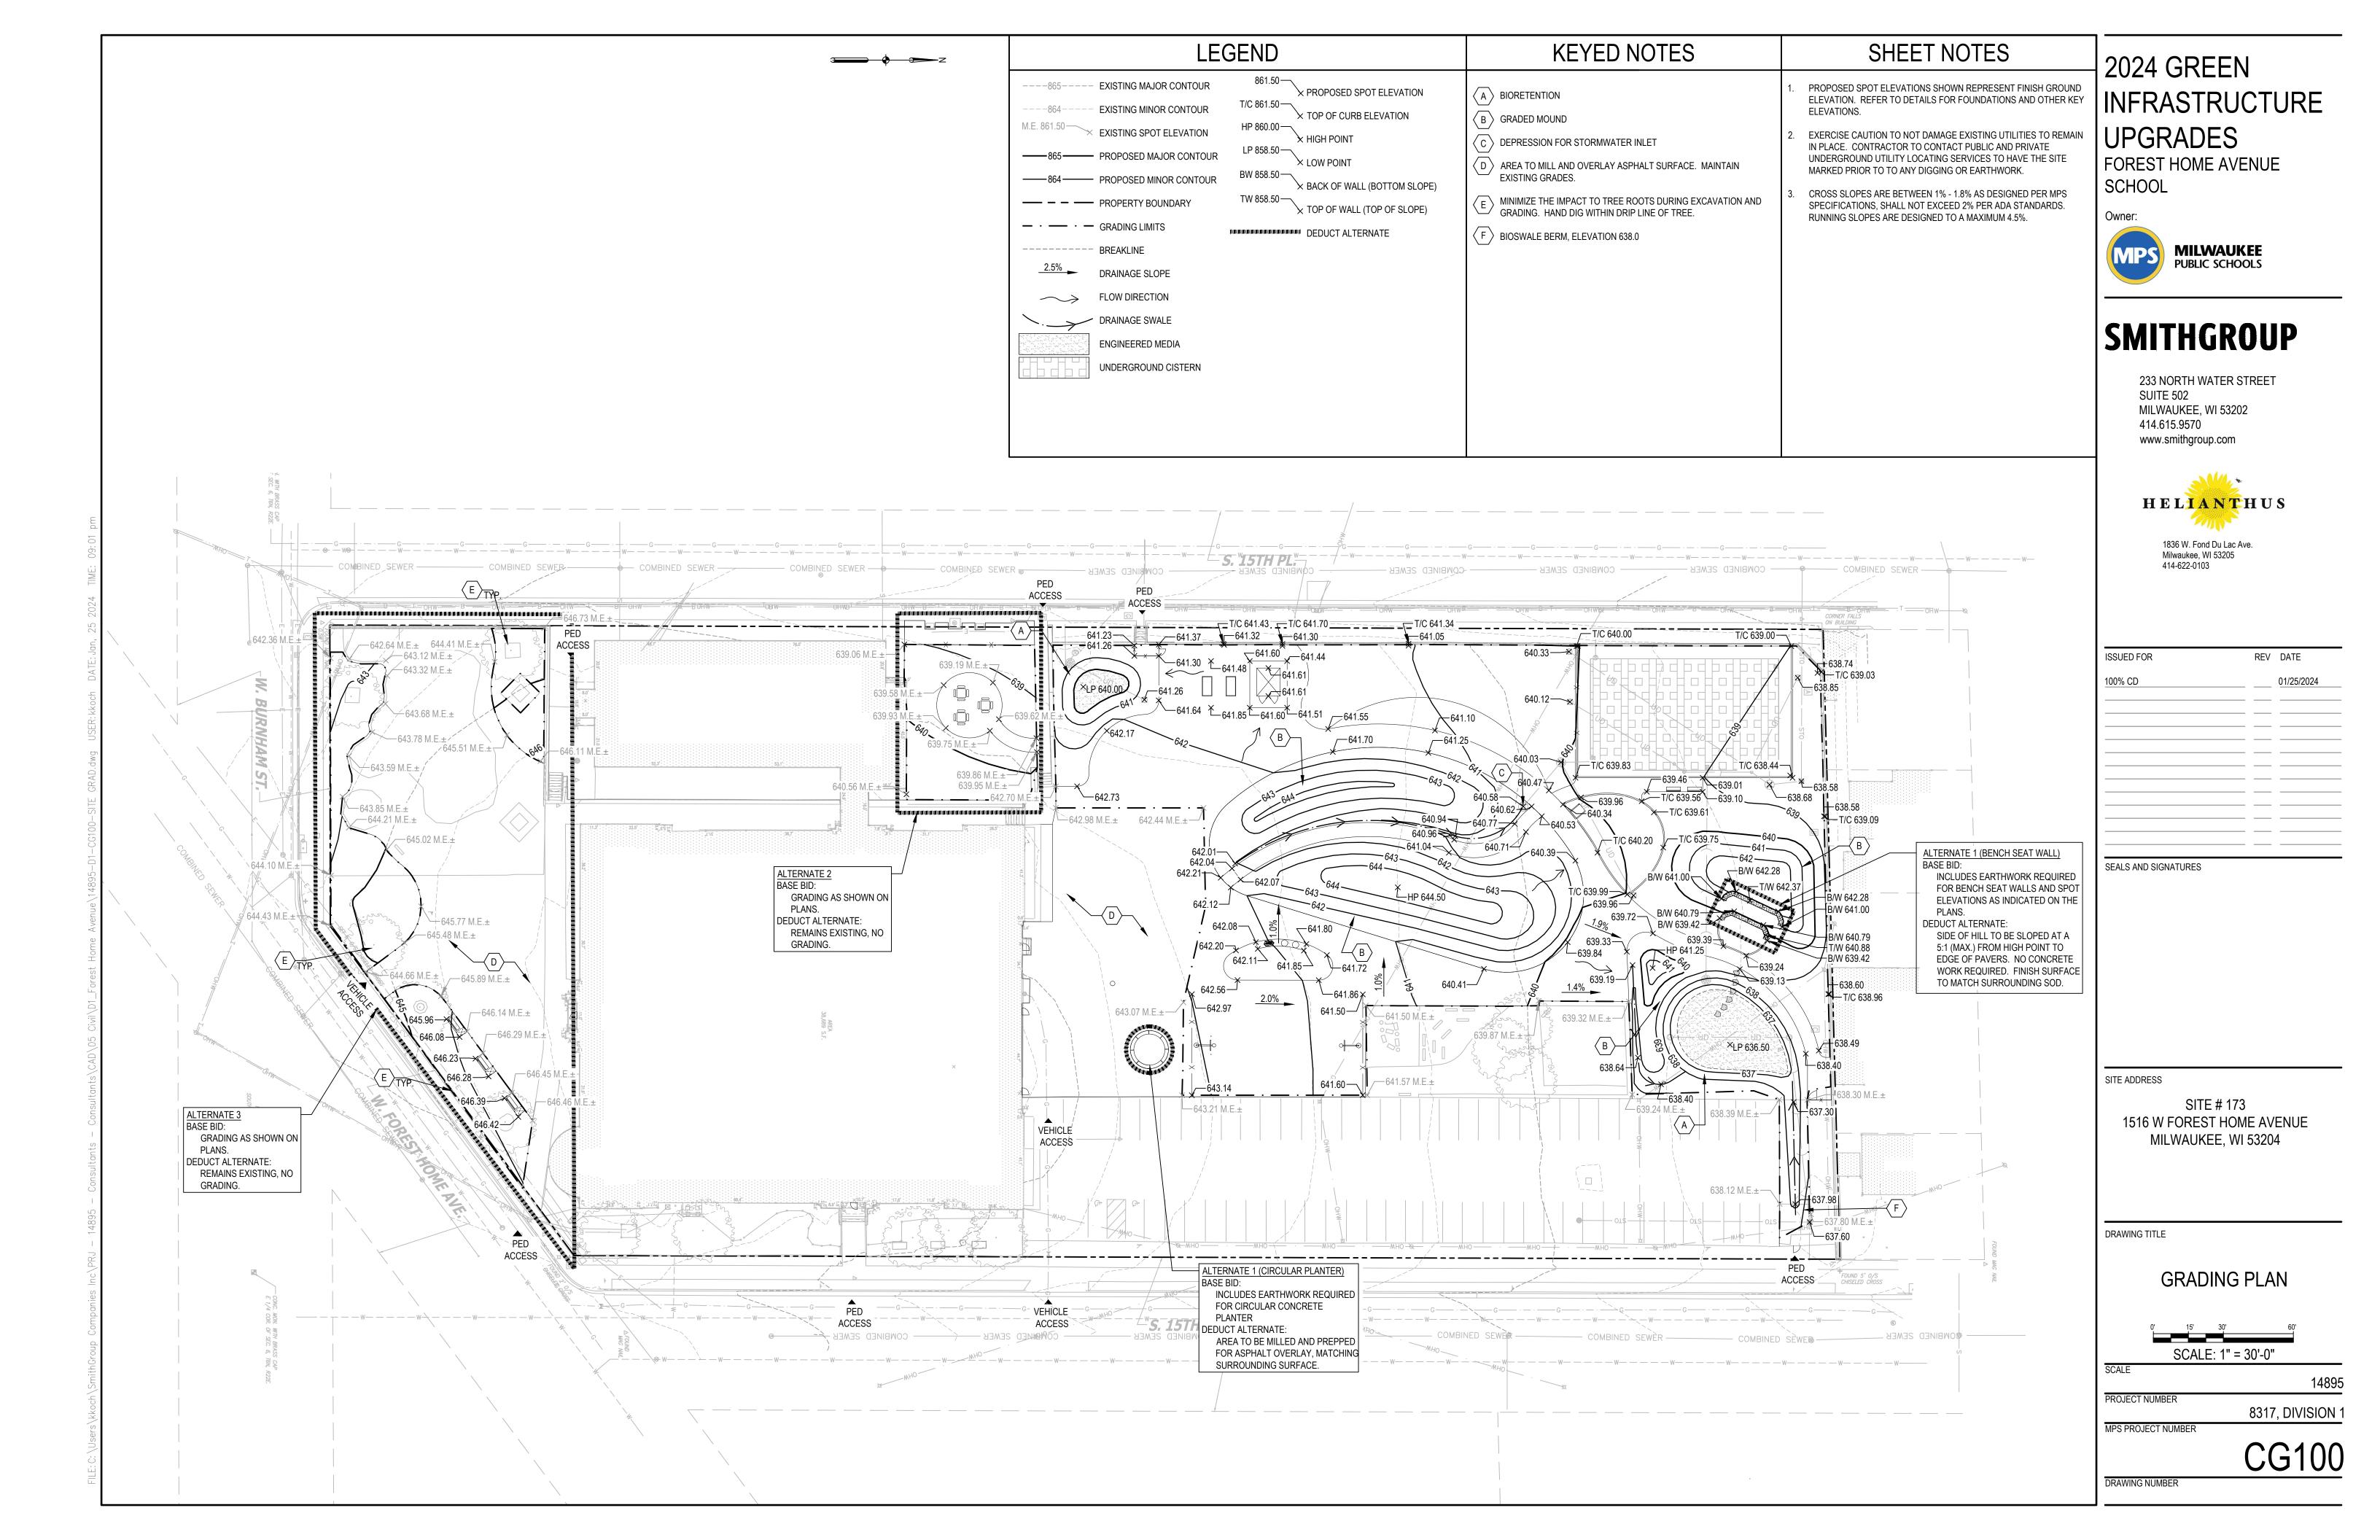

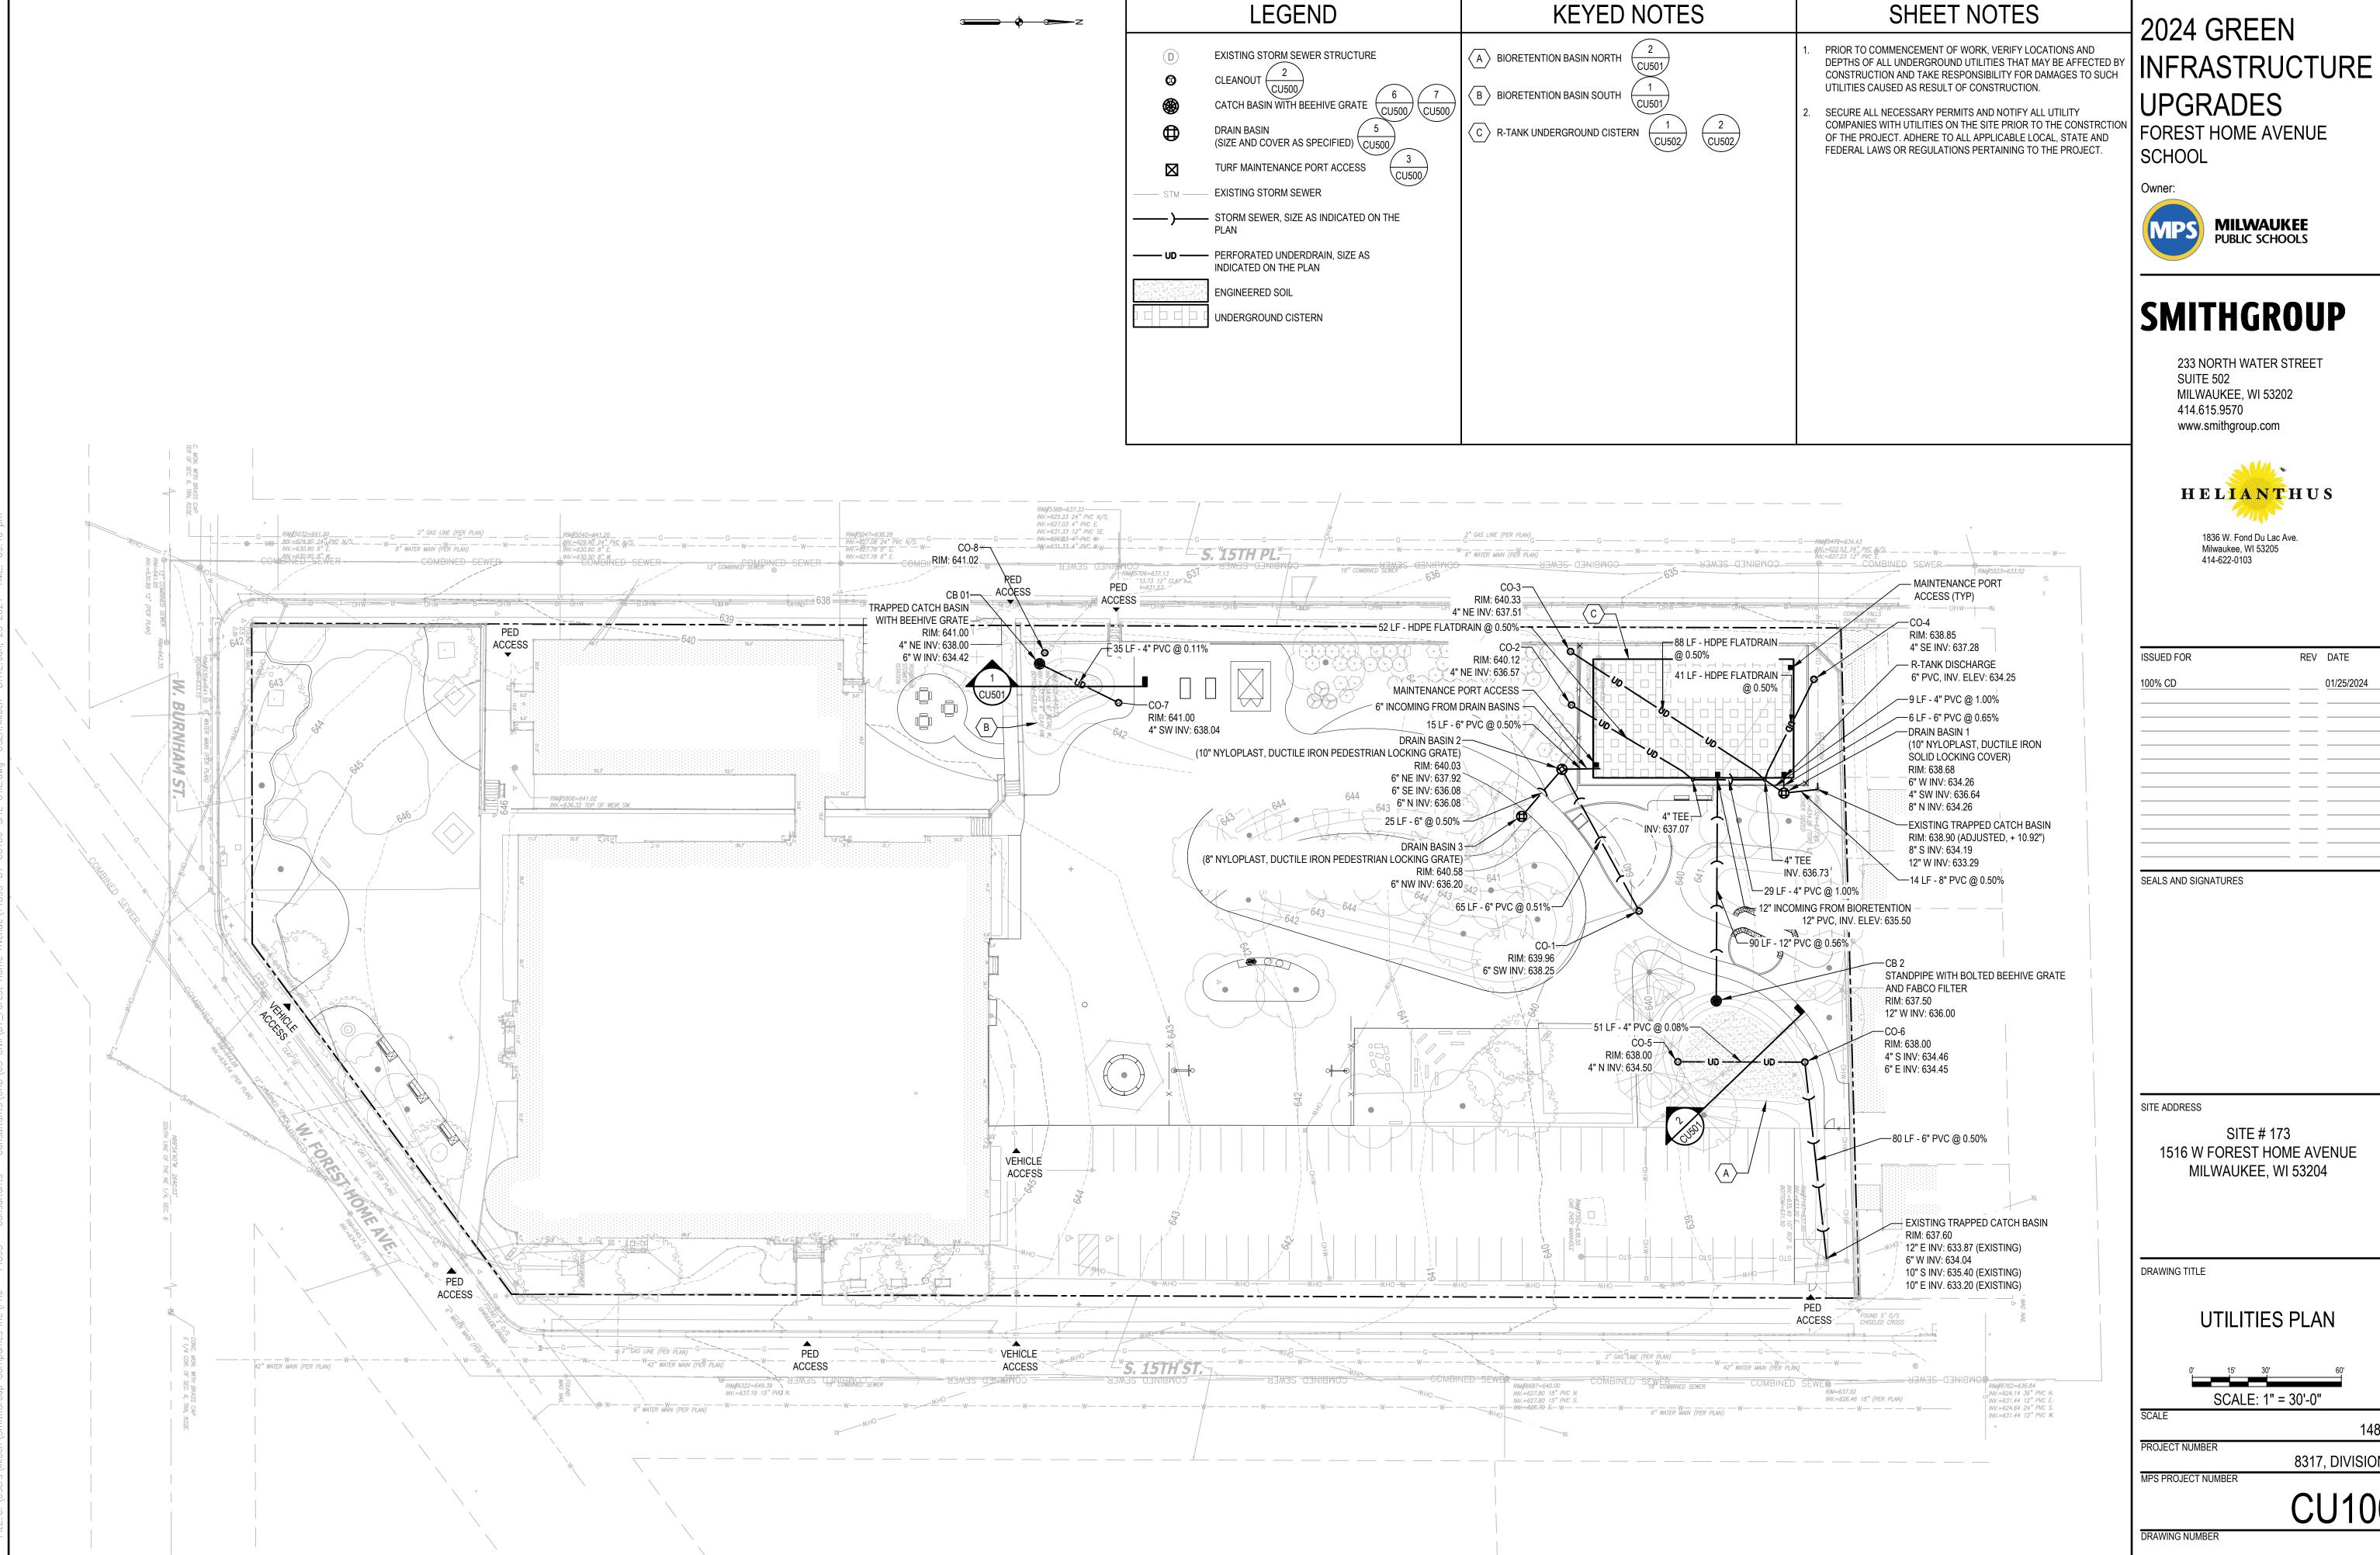

ISSUED FOR	REV	DATE
100% CD		01/25/2024

13 30	
SCALE: 1" = 3	0'-0"
SCALE	1489
PROJECT NUMBER	3317, DIVISION
MDO DDO JEOT NILIMBED	

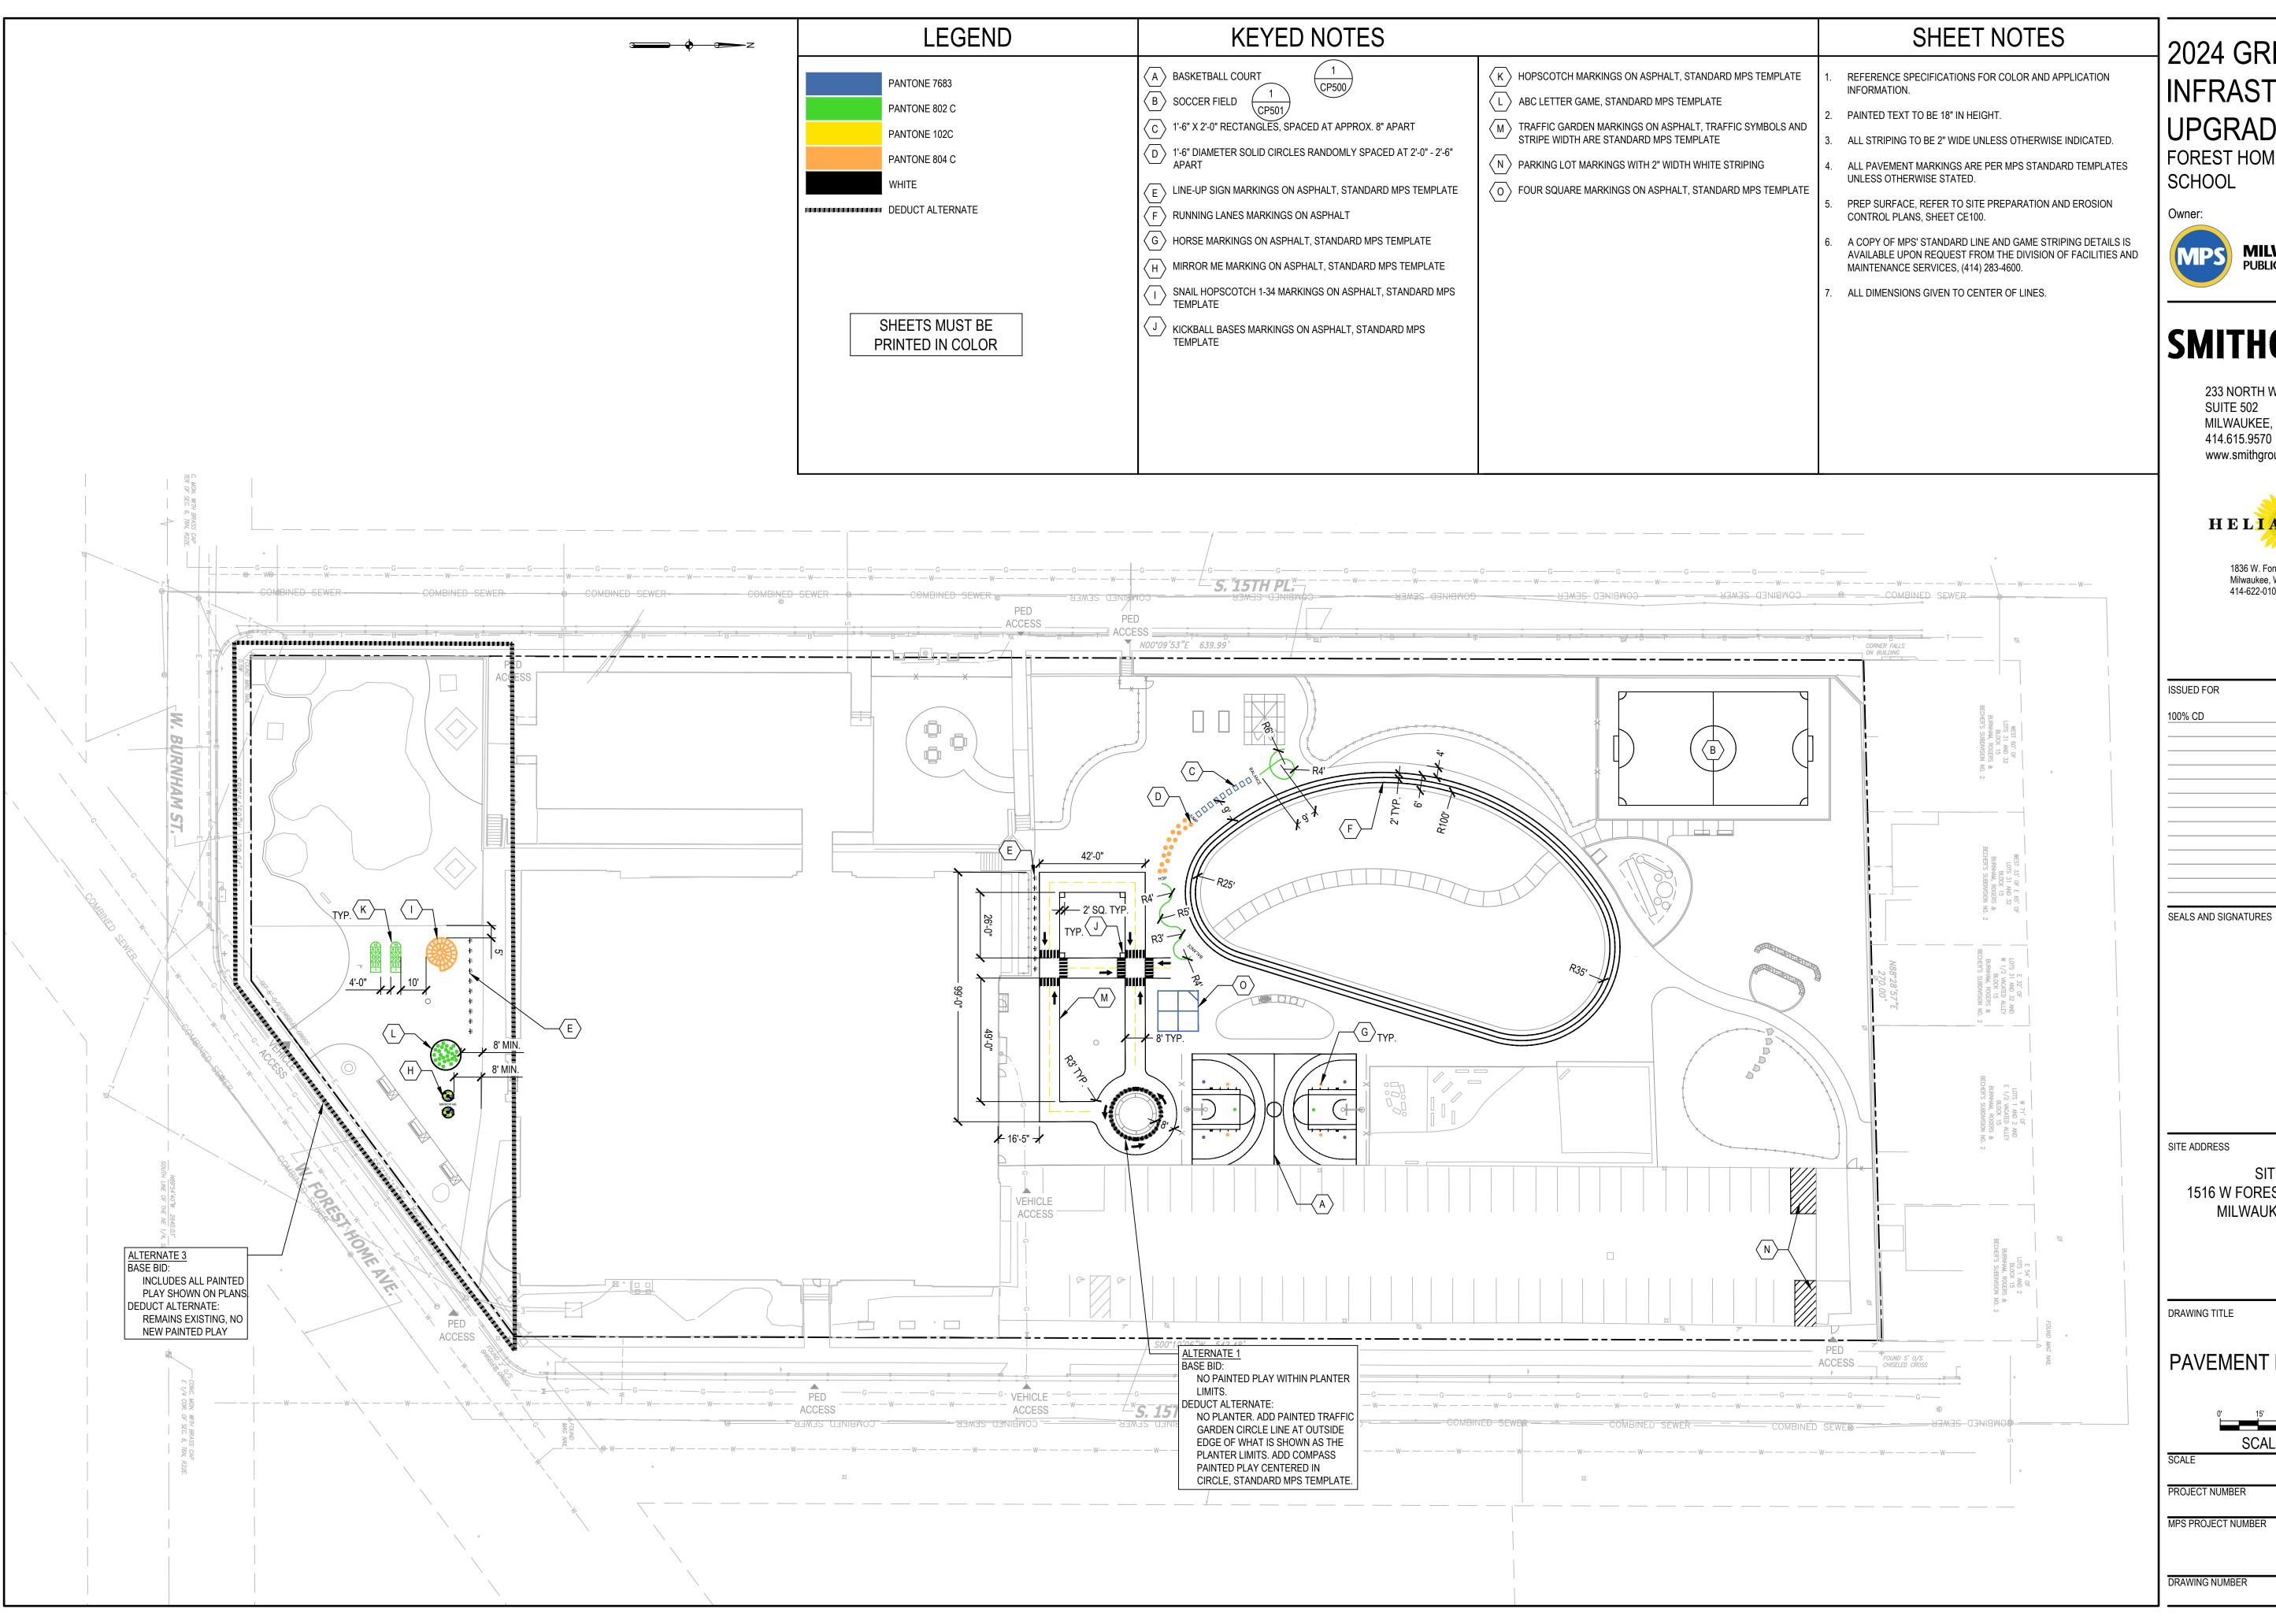

2024 GREEN INFRASTRUCTURE UPGRADES

FOREST HOME AVENUE



SMITHGROUP

233 NORTH WATER STREET SUITE 502 MILWAUKEE, WI 53202 414.615.9570 www.smithgroup.com



1836 W. Fond Du Lac Ave. Milwaukee, WI 53205 414-622-0103

ISSUED FOR	REV	DATE
100% CD		01/25/2024

SITE # 173 1516 W FOREST HOME AVENUE MILWAUKEE, WI 53204

PAVEMENT MARKINGS PLAN


0'	15'	30'		60'	
	SCALE	E: 1" = 3	30'-0"		_
SCALE				1489	5
PROJECT NUMBE	ER		8317, [DIVISION	- 1
MPS PROJECT N	JMBER				_

DRAWING NUMBER

GENERAL NOTES:

MANUFACTURED ALTERNATIVES APPROVED AND LISTED ON THE DEPARTMENT'S EROSION CONTROL PRODUCT ACCEPTABILITY LIST MAY BE SUBSTITUTED. WHEN REMOVING OR MAINTAINING INLET PROTECTION, CARE SHALL BE TAKEN SO THAT THE SEDIMENT TRAPPED ON THE GEOTEXTILE FABRIC DOES NOT FALL INTO THE INLET. ANY MATERIAL FALLING INTO THE INLET SHALL BE REMOVED IMMEDIATELY.

- FINISHED SIZE, INCLUDING FLAP POCKETS WHERE REQUIRED, SHALL EXTEND A MINIMUM OF 10" AROUND THE PERIMETER TO FACILITATE MAINTENANCE OR REMOVAL.
- 2. FOR INLET PROTECTION, TYPE C (WITH CURB BOX), AN ADDITIONAL 18" OF FABRIC IS WRAPPED AROUND THE WOOD AND SECURED WITH STAPLES. THE WOOD SHALL NOT BLOCK THE ENTIRE HEIGHT OF THE
- FLAP POCKETS SHALL BE LARGE ENOUGH TO ACCEPT WOOD 2x4.

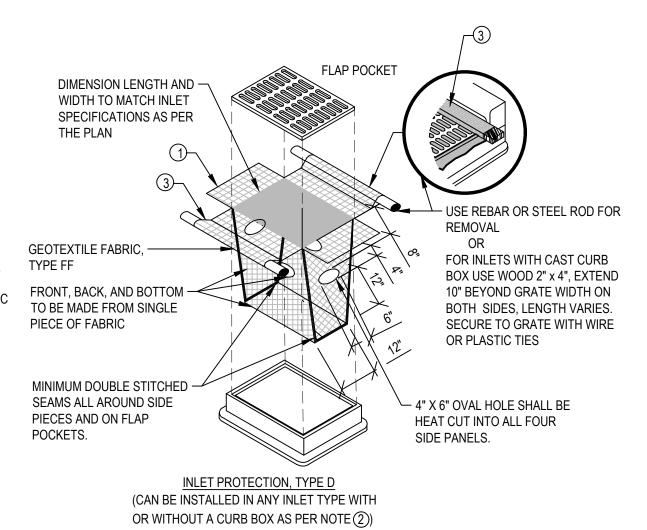

INSTALLATION NOTES:

TYPE B & C

TOP ANCHOR

TRIM EXCESS FABRIC IN THE FLOW LINE TO WITHIN 3" OF THE GRATE. THE CONTRACTOR SHALL DEMONSTRATE A METHOD OF MAINTENANCE, USING A SEWN FLAP, HAND HOLDS OR OTHER METHOD TO PREVENT ACCUMULATED SEDIMENT FROM ENTERING THE INLET.

DO NOT INSTALL INLET PROTECTION TYPE D IN INLETS SHALLOWER THAN 30", MEASURED FROM THE BOTTOM OF THE INLET TO THE TOP OF THE GRATE. TRIM EXCESS FABRIC IN THE FLOW LINE TO WITHIN 3" OF THE GRATE. THE INSTALLED BAG SHALL HAVE A MINIMUM SIDE CLEARANCE, BETWEEN THE INLET WALLS AND THE BAG, MEASURED AT THE BOTTOM OF THE OVERFLOW HOLES, OF 3". WHERE NECESSARY THE CONTRACTOR SHALL CINCH THE BAG, USING PLASTIC ZIP TIES, TO ACHIEVE THE 3" CLEARANCE. THE TIES SHALL BE PLACED AT A MAXIMUM OF 4" FROM THE BOTTOM OF THE BAG.

EROSION CONTROL MATTING

PLAN VIEW - FLOW LESS THAN 45° TO

SCALE: 1/2" = 1'-0"

, 2'-0" OVERLAP

PLAN VIEW - FLOW 45 TO 90° TO TUBE

WHEN SEDIMENT CONTROL TUBE IS USED ON A PAVED SURFACE CONCRETE BLOCKS SHALL BE USED TO SECURE SEDIMENT CONTROL TUBE IN PLACE OF STAKING. ACCUMULATED SEDIMENT SHALL BE REMOVED FROM BEHIND THE SEDIMENT CONTROL TUBE WHEN IT HAS REACHED A HEIGHT EQUAL TO HALF OF THE TUBE HEIGHT. SMALL HOLES OR NARROW RIPS LESS THAN 12" LONG MAY BE STITCHED CLOSED USING PLASTIC 4'-0" (MIN.) HOOK ZIP TIES. LARGER RIPS SHALL BE FIXED PER THE REPAIR DETAIL. HEAVILY DAMAGED SECTIONS _ 2" x 2" x 36" WOOD STAKES ⊁ SHALL BE REPLACED ENTIRELY. MAINTAIN 2' MINIMUM OVERLAP AT EACH END. AT 10'-0" O.C. (MIN.) NARROW TEAR ---LONGER THAN 12" - NEW FABRIC WRAPPED FLOW AROUND TUBE AND TIED AT ¥ EXISTING SEDIMENT CONTROL TUBE -DOWNSTREAM SIDE. EXTEND **NEW FABRIC A MINIMUM OF 12"** PAST EACH END OF TEAR PLASTIC TIES , 2'-0" OVERLAP

BACK-GROUT W/ TUBE -

DRIVE STAKE 12" MIN. —

FILLER MATERIAL

FLOW

– 12" DIA. TUBE

- 12" DIA. TUBE

__ 2" x 2" x 36" WOOD STAKES

AT 10'-0" O.C. (MIN.)

SEDIMENT CONTROL TUBE

REPAIR DETAIL - TEAR GREATER THAN 12

OR STITCHING

SECTION VIEW

__ 2" x 2" x 36" WOOD STAKES


AT 10'-0" O.C. (MIN.)

└─ 12" DIA. TUBE

INLET PROTECTION

GENERAL NOTES:

- 1. SEE SPECIFICATIONS FOR EROSION CONTROL MATTING MATERIAL- MUST BE **BIODEGRADABLE**
- 2. SEE SPECIFICATIONS FOR FASTENERS- MUST BE BIODEGRADABLE

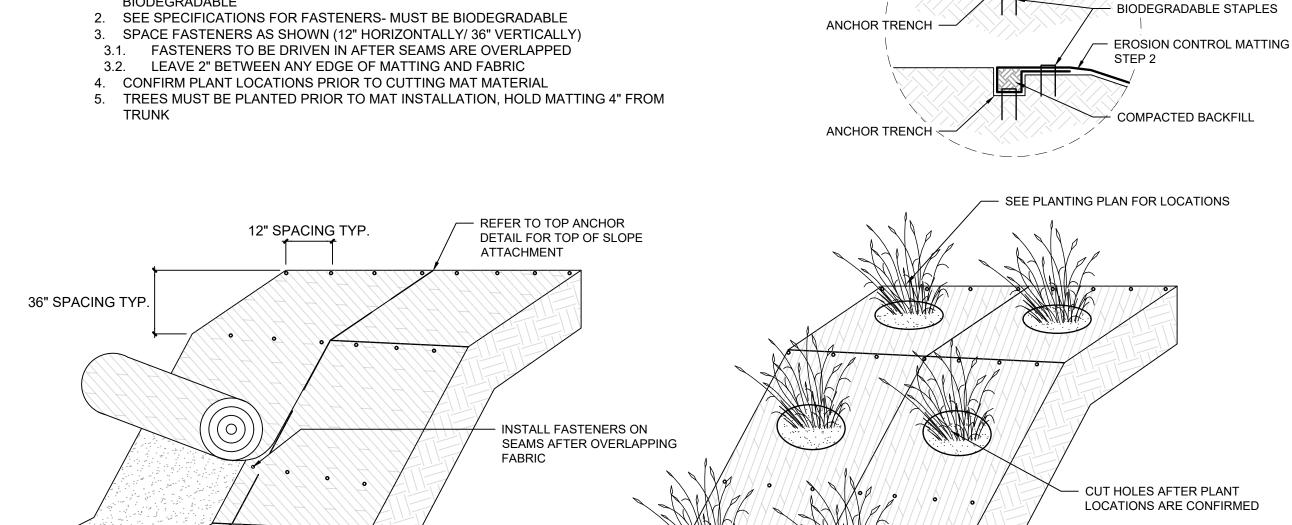

EROSION CONTROL MATTING ON SLOPE (MPS STANDARD)

OVERLAP SEAMS BY 6"

SCALE: 1/2" = 1'-0"

2024 GREEN INFRASTRUCTURE UPGRADES FOREST HOME AVENUE

Owner:

SCHOOL



SMITHGROUP

233 NORTH WATER STREET SUITE 502 MILWAUKEE, WI 53202 414.615.9570 www.smithgroup.com



1836 W. Fond Du Lac Ave. Milwaukee, WI 53205 414-622-0103

ISSUED FOR	REV	DATE
100% CD		01/25/2024

SITE ADDRESS

SEALS AND SIGNATURES

SCALE: 1/2" = 1'-0"


SITE # 173 1516 W FOREST HOME AVENUE MILWAUKEE, WI 53204

DRAWING TITLE

EROSION CONTROL DETAILS

SCALE PROJECT NUMBER 8317, DIVISION 7 MPS PROJECT NUMBER

DRAWING NUMBER

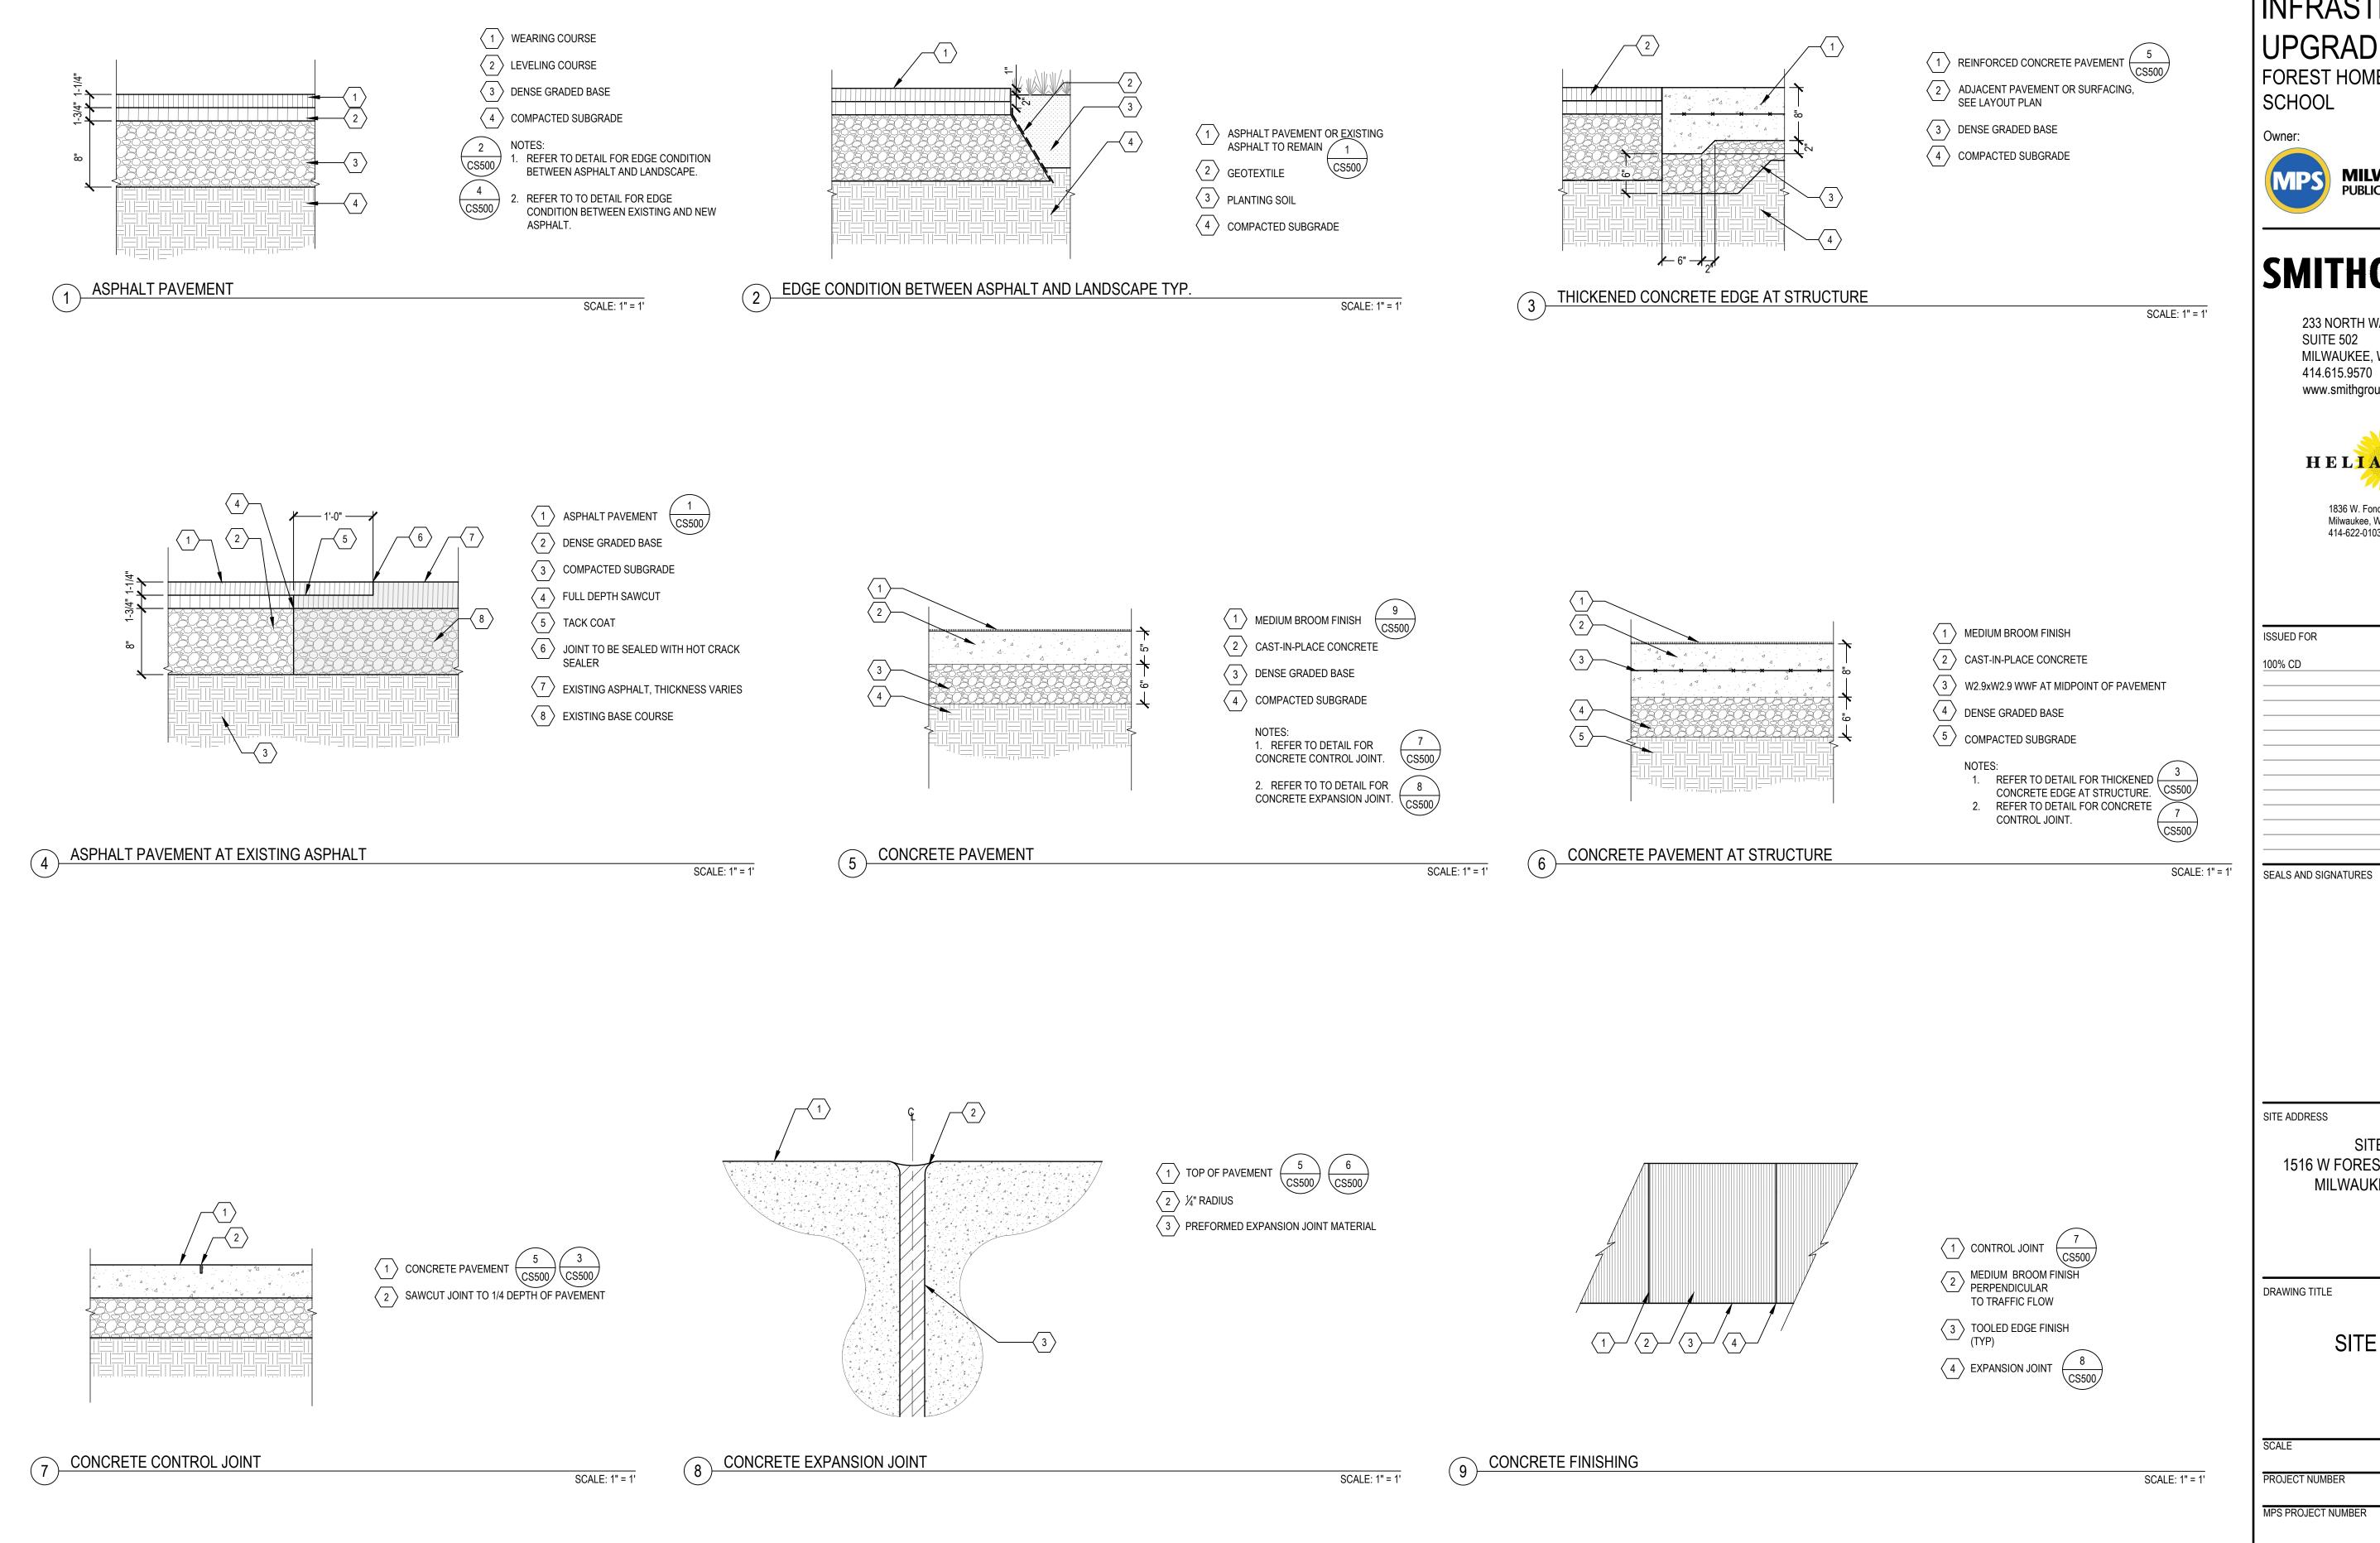

2024 GREEN INFRASTRUCTURE UPGRADES

FOREST HOME AVENUE SCHOOL

Owner:



SMITHGROUP

233 NORTH WATER STREET SUITE 502 MILWAUKEE, WI 53202 414.615.9570 www.smithgroup.com



1836 W. Fond Du Lac Ave. Milwaukee, WI 53205 414-622-0103

ISSUED FOR	REV	DATE
100% CD		01/25/2024

SITE ADDRESS


SITE # 173 1516 W FOREST HOME AVENUE MILWAUKEE, WI 53204

DRAWING TITLE

DRAWING NUMBER

SITE DETAILS

	CS500
MPS PROJECT NUMBER	
	8317, DIVISION
PROJECT NUMBER	
SCALE	1489

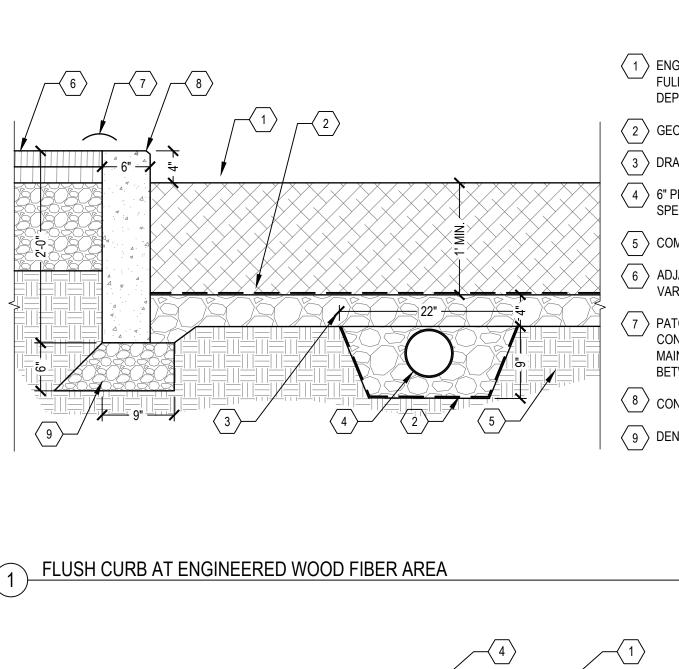

1 ENGINEERED WOOD FIBER SURFACING, FULLY COMPACTED TO 12 INCH MINIMUM DEPTH, POST SETTLEMENT

2 GEOTEXTILE FABRIC

(3) DRAINAGE AGGREGATE

 \langle 4 \rangle 6" PERFORATED PVC, SLOPED AS SPECIFIED ON PLANS

5 COMPACTED SUBGRADE

⟨ 6 ⟩ ADJACENT PAVEMENT OR LANDSCAPE, VARIES, SEE LAYOUT.

7 PATCH BETWEEN ASPHALT AND CONCRETE CURB AS NECESSARY MAINTAINING A FLUSH TRANSITION BETWEEN SURFACES

(8) CONCRETE CURB 9 DENSE GRADED BASE (1) SYNTHETIC TURF

2 2" TURF INFILL MATERIAL

(3) CHOKER STONE

4 DRAINAGE AGGREGATE

 \langle 5 \rangle GEOTEXTILE FABRIC, TYPE DF

 $\langle 6 \rangle$ 2 X 6 NAILER BOARD FASTENED WITH 3/8" X 6" BOLT EMBEDDED AND EPOXY GLUED MIN. 2 ½" INTO CURB, SPACED 3'-0" O.C. HORIZONTALLY

7 COMPACTED SUBGRADE

ADJACENT PAVEMENT OR LAWN, VARIES, SEE PLAN

9 CONCRETE CURB $\frac{3}{}$

WIDTH VARIES, SEE PLAN AND RELEVANT DETAILS

 $\binom{1}{1}$ 1/2' CHAMFER AT 45° WHEN NOT FLUSH WITH ADJACENT PAVEMENT

2 FLUSH WITH ADJACENT PAVEMENT

3 CONCRETE CURB

#4 HORIZONTAL REBAR EPOXY COATED, CONTINUOUS CENTERED IN CURB WIDTH.

 $\langle 5 \rangle$ #4 REBAR EPOXY COATED AT 18" O.C.

6 DENSE GRADED BASE

7 ADJACENT PAVEMENT, VARIES, SEE PLAN AND RELEVANT DETAILS


 \langle 8 \rangle ADJACENT MATERIAL, VARIES, SEE PLAN AND RELEVANT DETAILS

1. LIGHTLY BROOM CURB SURFACE WITH GRAIN PERPENDICULAR TO DIRECTION OF TRAFFIC

FLUSH CURB AT SYNTHETIC TURF SCALE: 1" = 1'

SCALE: 1" = 1'

SCALE: 1" = 1'

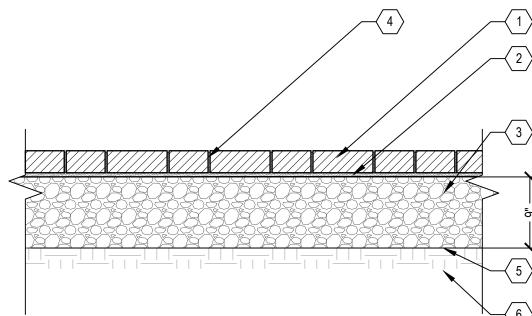

UNIT PAVERS

PERMEABLE BEDDING COURSE: 1" THICK OF $\frac{1}{4}$ " CLEAR OPEN GRADED CHIP STONE (ASTM NO. 8) SCREEDED OVER BASE

PERMEABLE BASE: OPEN GRADED STONE COMPACTED TO ACHIEVE FULL PARTICLE LOCK-UP AND CONSOLIDATION

JOINTING MATERIAL AND JOINT STABILIZATION: CLEAR STONE CHIP (ASTM NO. 9) SWEPT IN AS JOINTING INFILL.

(5) STABILIZATION GRID BETWEEN SUBGRADE AND BASE

6 COMPACTED SUBGRADE

TYPICAL CURB DETAIL

(1) UNIT PAVERS 2 CONCRETE CURB


(3) DENSE GRADED BASE


4 COMPACTED SUBGRADE

UNIT PAVERS

UNIT PAVERS WITH CONCRETE EDGE RESTRAINT

SCALE: 1" = 1'

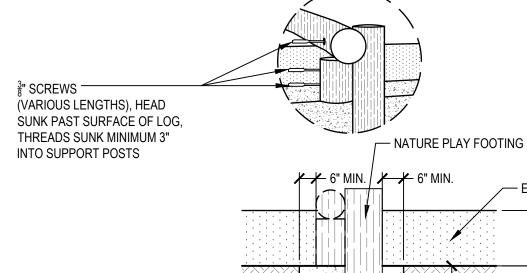

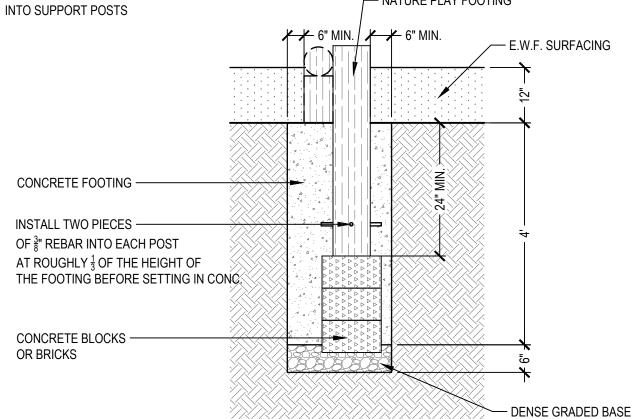

WHICHEVER IS GREATER.

HEIGHTS.

- ENGINEERED WOOD FIBER SURFACING - CONCRETE REINFORCED WITH MESH — DENSE GRADED BASE

1. ALL DEPTHS MUST MEET MANUFACTURER'S SPECIFICATIONS, OR MPS SPECIFICATIONS,

MAKE TRENCH 15"-16" DEEP; 12" OF CONCRETE AND 3"-4" OF COMPACTED GRAVEL, AND MAKE

4. INSTALL TWO PIECES OF $\frac{2}{8}$ " REBAR INTO EACH SUPPORT JUMPER AT ROUGHLY $\frac{1}{3}$ OF THE HEIGHT

LENGTH OF STUMP JUMPERS VARIES DEPENDING ON DESIRED HEIGHT AND AGE GROUP, 4

STUMP JUMPERS MUST NOT BE HIGHER THAN 20" FROM PROTECTIVE SURFACING WHEN

ROUND ALL EXPOSED EDGES AND REMOVE SAW MARKS WITH A SANDER OR GRINDER.

9. INSTALLER TO PROVIDE PERMANENT HIGH AND LOW MARKS (AT LEAST 3 VERTICALS) FOR

STANDARD LENGTHS ARE PROVIDED; 32", 42", 48", AND 52", BUT THEY CAN BE CUT TO CUSTOM

SURE THERE IS A MINIMUM OF 6" OF CONCRETE AROUND THE SIDES OF THE JUMPERS.

1. PLACE STEPPING STONES TO CONFIGURATIONS AND LOCATION AS SHOWN ON PLAN.

 $ot \longleftarrow$ WIDTH OF STONE \langle A \rangle -

2. SELECT AND PLACE STEPPING STONES SO THAT A MINIMUM OF EXCAVATION SCARS ARE VISIBLE. 3. STEPPING STONES TO BE APPROVED BY

OWNER'S PROJECT REPRESENTATIVE PRIOR TO

PLACEMENT. 4. DO NOT FRACTURE STEPPING STONES DURING REJECTION.

5. WASH OFF STEPPING STONES COMPLETELY

SECTION OF STEPPING STONES

PLACEMENT, SUCH ACTION WILL BE CAUSE FOR

STONE STEPPERS DIMENSIONS:

A WIDTH OF STONE - 18" TO 24"

⟨B⟩ LENGTH OF STONE- 24" TO 30"

(C) HEIGHT OF STONE- 18" TO 24" HEIGHT

 \langle D \rangle HEIGHT ABOVE FINISHED GRADE - 2" TO 4" WHEN PLACED ON A SLOPE, THE TOP OF THE STONE SHOULD BE LEVEL. MAINTAIN THE MINIMUM HEIGHT OF 2" ABOVE FINISHED GRADE AT THE STONE'S HIGHER $\langle 1 \rangle$ STEPPING STONES

3 BIOSWALE SOIL, SEE

⟨ 2 ⟩ ADJACENT PLANTINGS, SEE PLANTING PLAN

WIDTH OF STONE - A

PLAN OF A STEPPING STONE

PLANTING DETAILS. 4 COMPACTED SUBGRADE

BELOW STEPPING STONES

SCALE: 1" = 1'

ALL DEPTHS MUST MEET MANUFACTURER'S SPECIFICATIONS, OR MPS SPECIFICATIONS, WHICHEVER IS GREATER. MAKE FOOTINGS BETWEEN 18"-24" DEEP AND MAKE SURE THERE IS A MINIMUM OF 6" OF CONCRETE AROUND THE SUPPORT

ONE SUPPORT POST MUST BE POSITIONED DIRECTLY UNDER THE LOG TO SUPPORT THE WEIGHT, WHILE THE OTHER WILL

STABILIZE THE LOG LATERALLY ONCE THE HARDWARE IS INSTALLED. 4. INSTALL TWO PIECES OF $\frac{3}{8}$ " REBAR INTO EACH SUPPORT POST AT ROUGHLY A THIRD OF THE HEIGHT OF THE FOOTING BEFORE SETTING IN CONCRETE.

PRE-DRILL A COUNTERSINK HOLE INTO THE LOG DEEP ENOUGH SO THAT WASHER AND SCREW HEAD DO NOT PROTRUDE BEYOND THE SURFACE OF THE LOG TO PREVENT POTENTIAL ENTANGLEMENTS HAZARDS. PLEASE NOTE: BLACK LOCUST (ROBINIA) IS EXTREMELY DENSE. NOT DRILLING A PILOT HOLE WILL POTENTIALLY RESULT IN A

SHEARED LAG SCREW. ATTACH LOG TO A SECOND SUPPORT POST WITH 8",10",12" OR LONGER, $\frac{3}{8}$ " STRUCTURAL, COATED LAG SCREW.

8. ROUND ALL EXPOSED EDGES AND REMOVE SAW MARKS WITH A SANDER.

STUMP JUMPERS FOOTING (MPS STANDARD DETAIL)

ENGINEER WOOD FIBER SAFETY SURFACING.

2. STUMP JUMPERS TO BE INSTALLED AS A STRIP FOOTING.

OF THE FOOTING BEFORE SETTING IN CONCRETE.

STUMP JUMPERS MUST BE A MIN. OF 10" IN DIAMETER.

INTENDED FOR 2-5 YEAR OLDS, AND 30" FOR 5-12 YEAR OLDS.

2024 GREEN INFRASTRUCTURE UPGRADES FOREST HOME AVENUE

Owner:

SCHOOL



SMITHGROUP

233 NORTH WATER STREET SUITE 502 MILWAUKEE. WI 53202 414.615.9570 www.smithgroup.com



1836 W. Fond Du Lac Ave. Milwaukee, WI 53205 414-622-0103

ISSUED FOR REV DATE 100% CD SEALS AND SIGNATURES

SITE ADDRESS

SITE # 173 1516 W FOREST HOME AVENUE MILWAUKEE, WI 53204

DRAWING TITLE

SITE DETAILS

SCALE PROJECT NUMBER 8317, DIVISION 1 MPS PROJECT NUMBER

DRAWING NUMBER

STEPPING STONES


AFTER PLACEMENT.


SCALE: 1" = 1'

NATURE PLAY FOOTINGS (MPS STANDARD DETAIL)

NOT TO SCALE


NOT TO SCALE

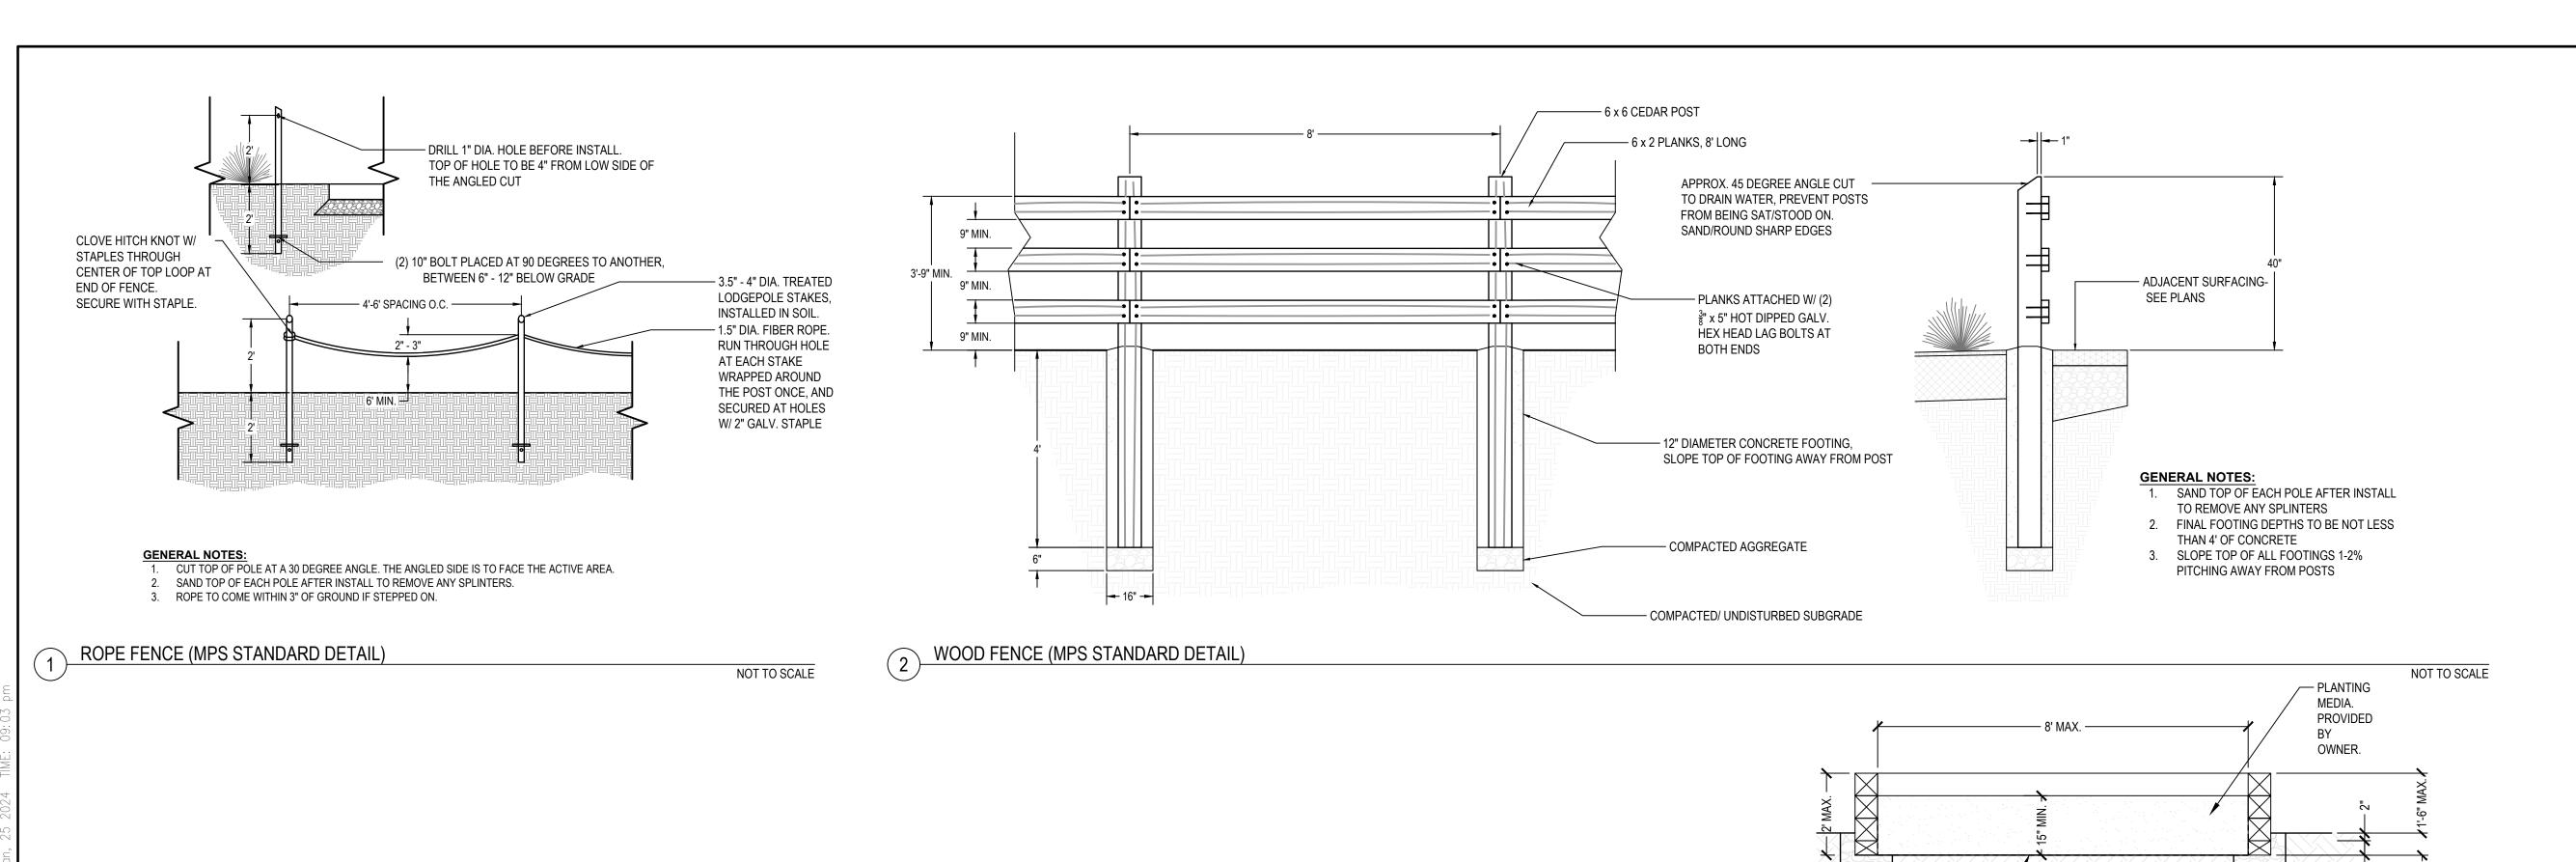


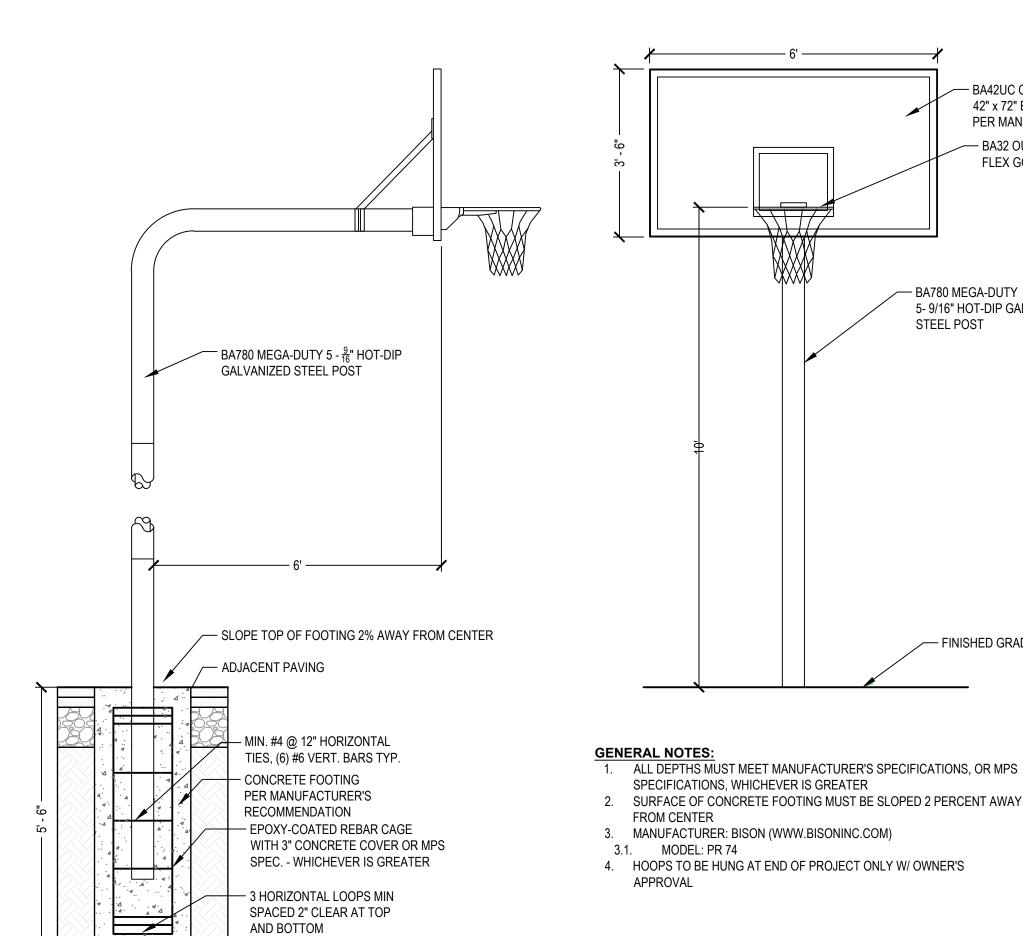

— DENSE GRADED BASE

BASKETBALL HOOP (MPS STANDARD DETAIL)

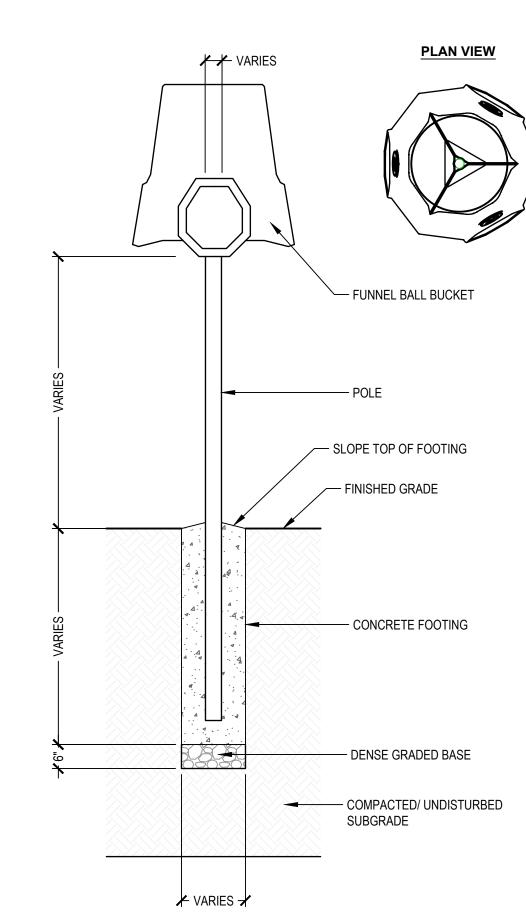

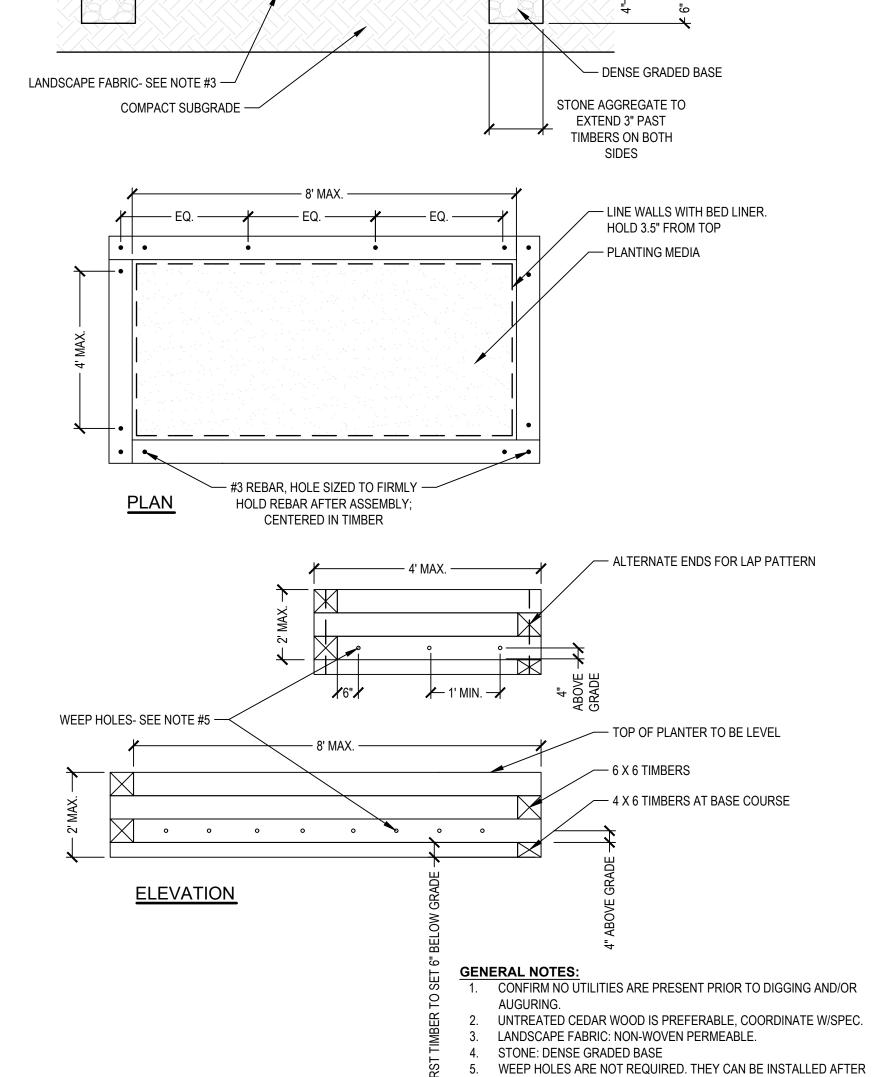

2024 GREEN INFRASTRUCTURE UPGRADES FOREST HOME AVENUE SCHOOL

Owner:




SMITHGROUP

233 NORTH WATER STREET SUITE 502 MILWAUKEE, WI 53202 414.615.9570 www.smithgroup.com



1836 W. Fond Du Lac Ave. Milwaukee, WI 53205 414-622-0103

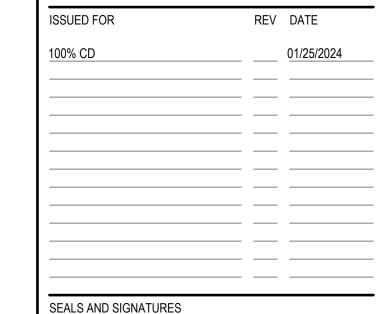

SITE ADDRESS

SITE # 173 1516 W FOREST HOME AVENUE MILWAUKEE, WI 53204

DRAWING TITLE

SITE DETAILS

SCALE PROJECT NUMBER 8317, DIVISION 1 MPS PROJECT NUMBER

DRAWING NUMBER

FUNNEL BALL FOUNDATION (MPS STANDARD DETAIL)

NOT TO SCALE

WOOD PLANTER BOX (MPS STANDARD DETAIL)

1. ALL DEPTHS MUST MEET MANUFACTURER'S SPECIFICATIONS, OR MPS

DO NOT INSTALL BUCKET UNTIL END OF PROJECT WITH OWNER'S

SPECIFICATIONS, WHICHEVER IS GREATER

NOT TO SCALE

SCALE: 1/2" = 1'

GENERAL NOTES:

PERMISSION.

MANUFACTURER: BURKE

3.1. PRODUCT: FUNNEL BALL

BA42UC OFFICIAL

— BA32 OUTDOOR FLEX GOAL

- BA780 MEGA-DUTY

STEEL POST


5- 9/16" HOT-DIP GALVANIZED


- FINISHED GRADE

42" x 72" BACKBOARD

PER MANUFACTER'S REC.

CONSTRUCTION IF DRAINAGE IS POOR.

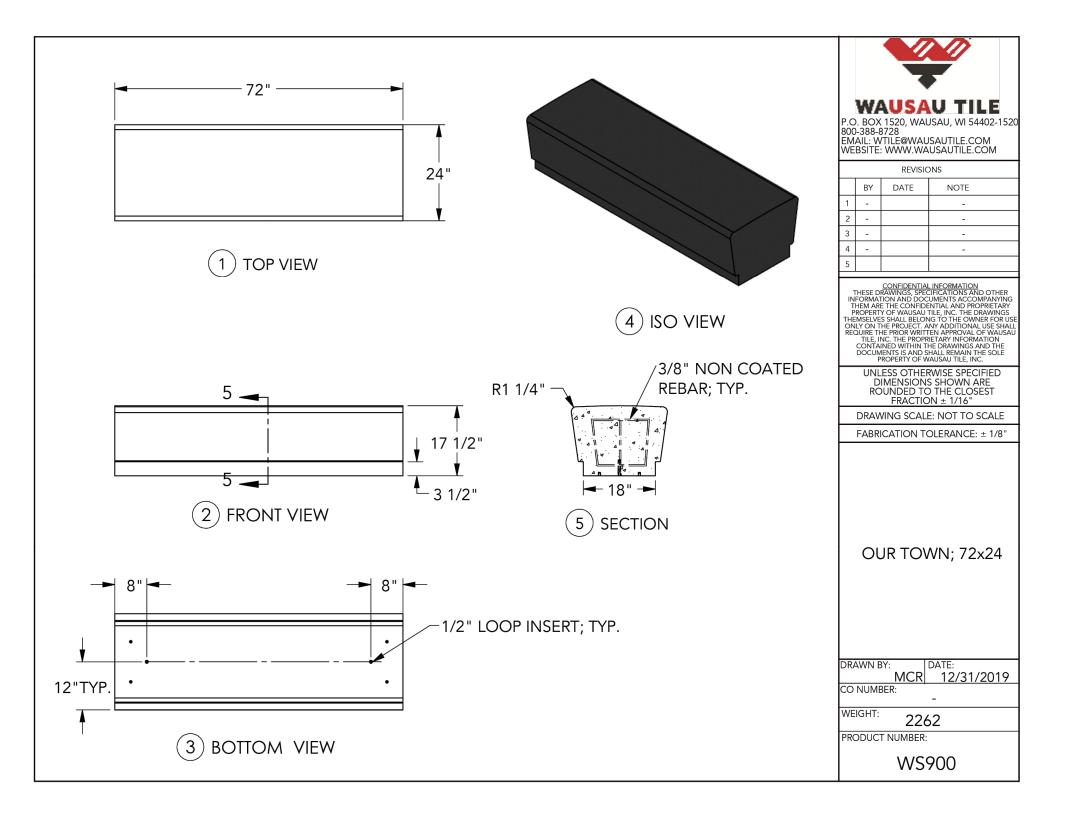

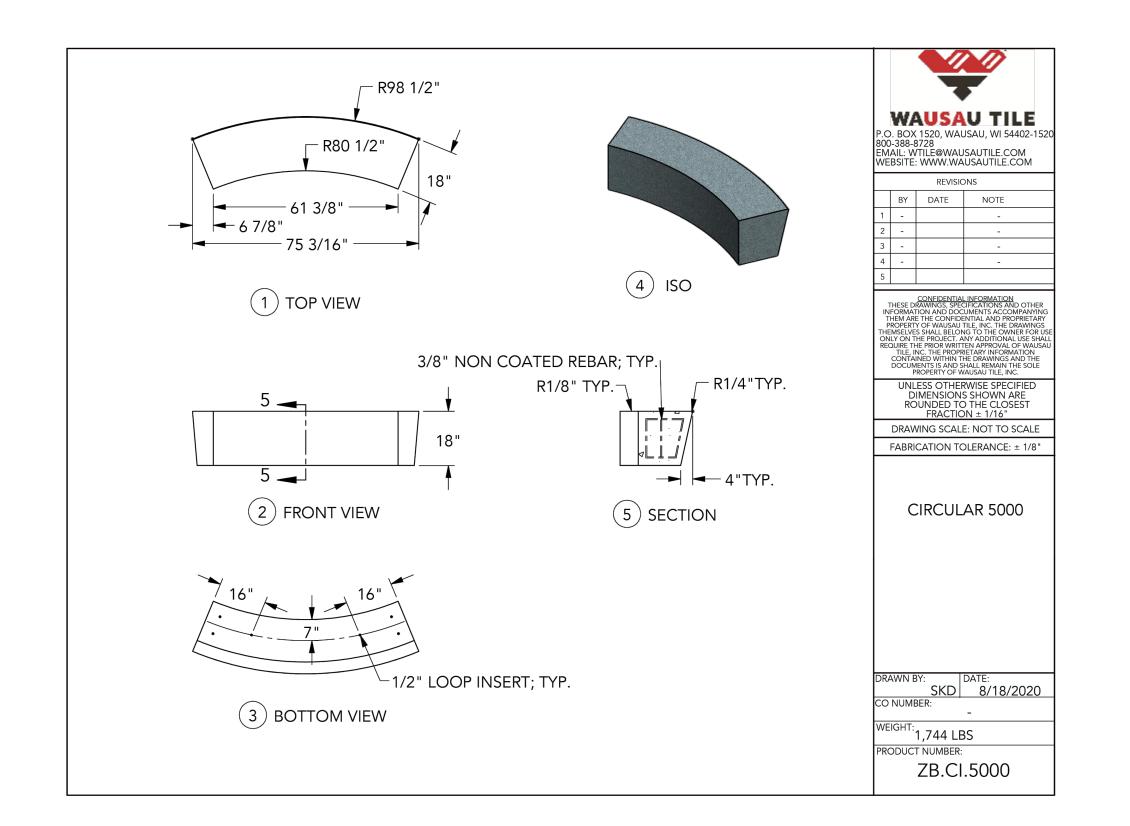

CONCRETE BENCH TYPE WS900


SCALE: 1" = 1'


SCALE: 1" = 1'

CONCRETE BENCH TYPE ZB.CI.5000

SCALE: 1" = 1'

SCALE: 1" = 1'

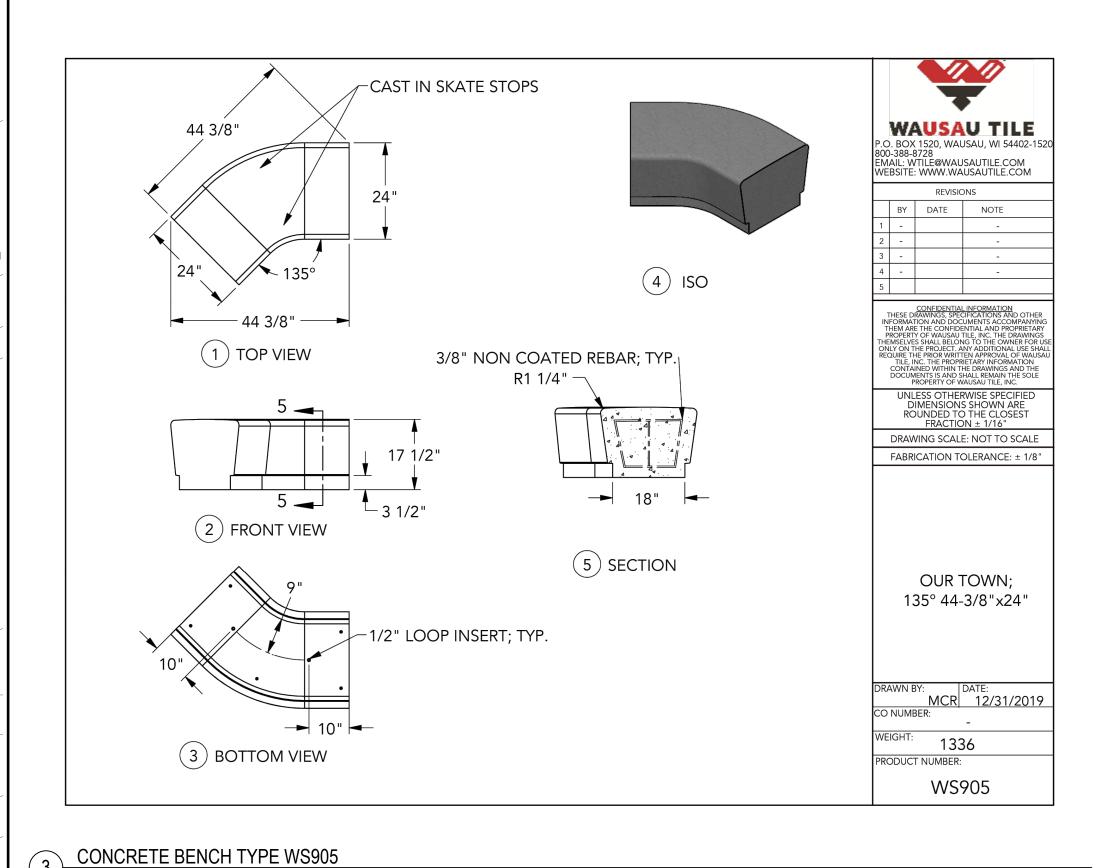

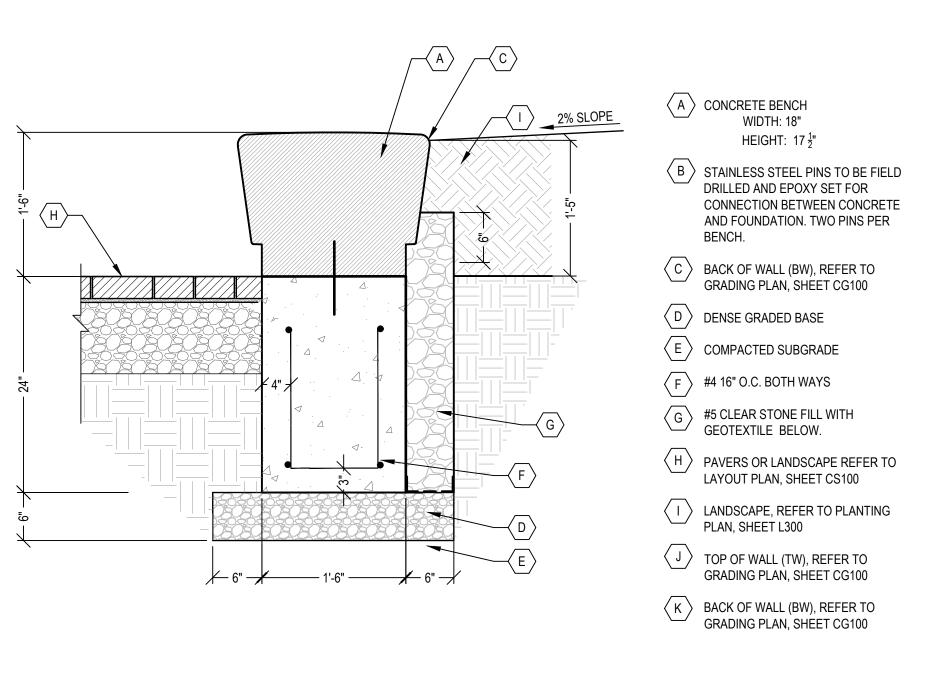

PRECAST BENCH INSTALLATION

2024 GREEN INFRASTRUCTURE UPGRADES

FOREST HOME AVENUE SCHOOL

Owner:



SMITHGROUP

233 NORTH WATER STREET SUITE 502 MILWAUKEE, WI 53202 414.615.9570 www.smithgroup.com



1836 W. Fond Du Lac Ave. Milwaukee, WI 53205 414-622-0103

 01/25/2024

SITE ADDRESS


SITE # 173 1516 W FOREST HOME AVENUE MILWAUKEE, WI 53204


DRAWING TITLE

DRAWING NUMBER

SITE DETAILS

	CS503
MPS PROJECT NUMBER	
	8317, DIVISION 1
PROJECT NUMBER	
	14895
SCALE	_

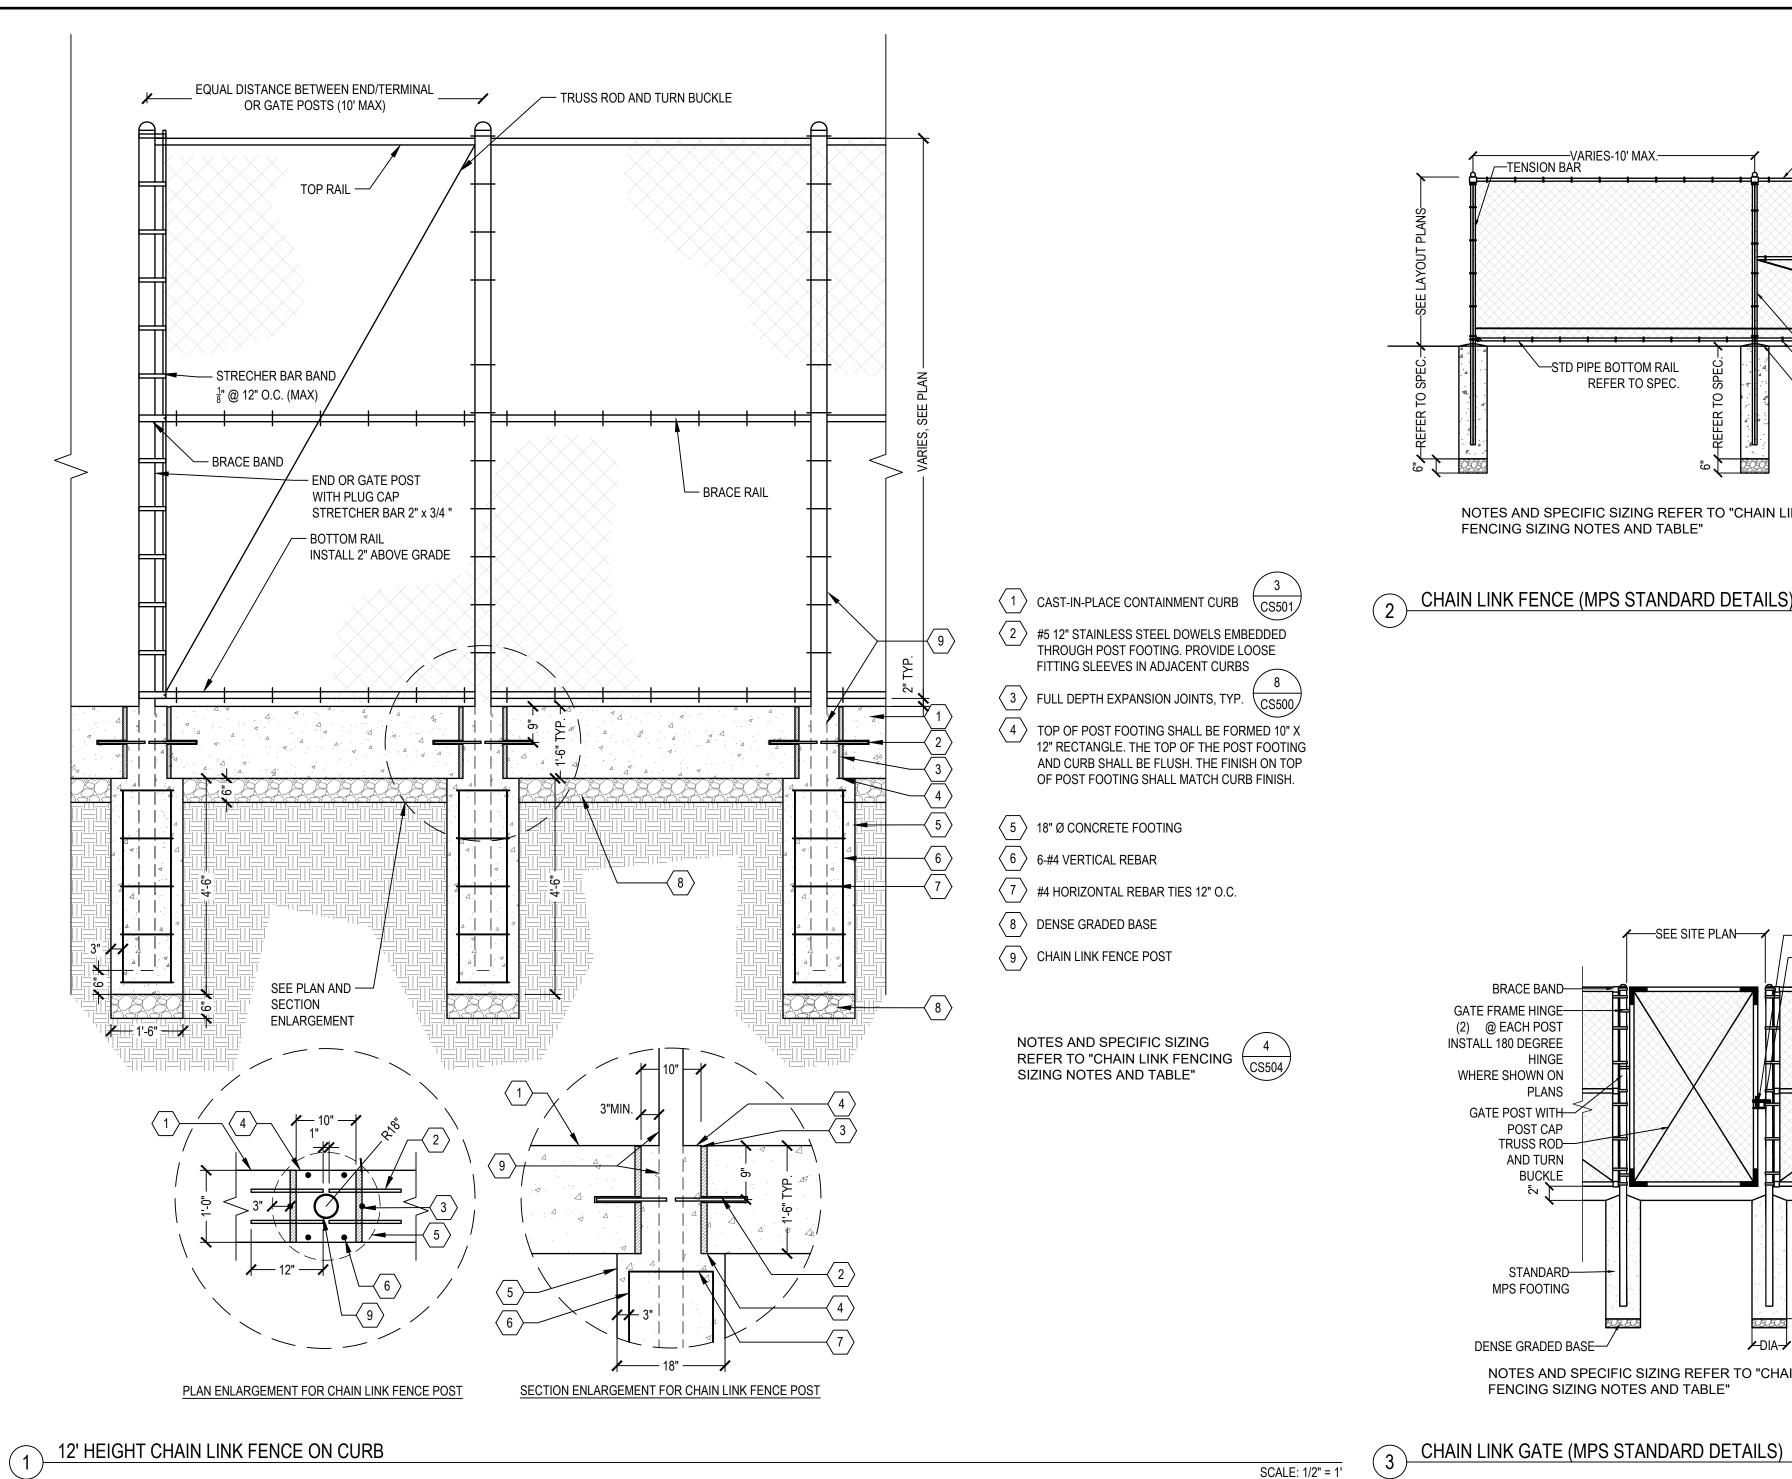

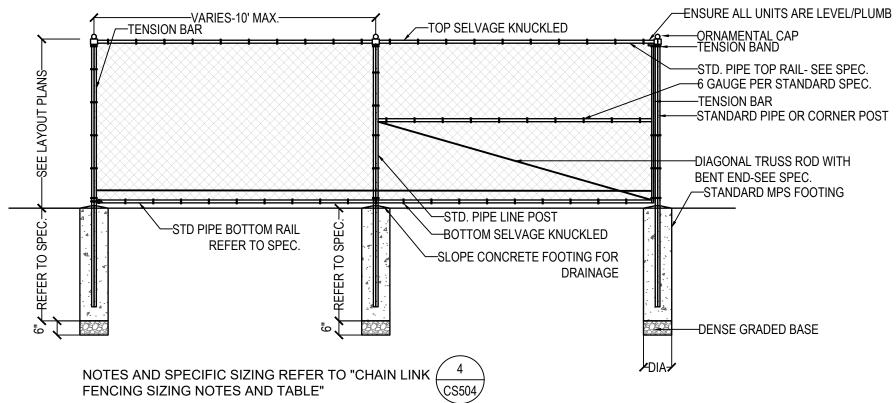

CHAIN LINK FENCE (MPS STANDARD DETAILS)

NOT TO SCALE

HEIGHT (")

SEE SITE PLAN FORK LATCH AND CATCH LOCK KEEPER AND GUIDE BRACE BAND GATE FRAME HINGE-(2) @ EACH POST INSTALL 180 DEGREE HINGE WHERE SHOWN ON GATE POST WITH-POST CAP TRUSS ROD-STANDARD-MPS FOOTING DENSE GRADED BASE-NOTES AND SPECIFIC SIZING REFER TO "CHAIN LINK (_

FENCING SIZING NOTES AND TABLE"

LINE	< 4'	0'-2"
LINE	4' - 14'	0'-2 1/2"
LINE	> 14'	3'-0"
END	< 4'	0'-2 1/2"
END	4' - 12'	0'-3"
END	> 12'	0'-4"
GATE	4' - 6'	0'-3"
GATE	7' - 12'	0'-4"
GATE	> 12'	0'-6"
A"FOOTING DEPTH" IS INCLUSIVE OF 6" OF S AT BOTTOM OF HOLE EMBEDMENT TO BE 6' THAN DIMENSION SHO	TONE 1. COOF . POST LOCA "LESS ON POON POON POON POON POON POON POON	NOTES: RDINATE LAYOUT A TE FENCE POSTS A LANS WHERE APPL MIT SHOP DRAWING SPECIFICATIONS FO
*DEV (15) A C A IN 10 T 515		

W/ OWNER DURING SHOP DRAWING REVIEW

NOT TO SCALE

POST TYPE

6'-0" 1'-0" 8'-0" AND INSTALLATION WITH CONCRETE WORK. S AT CONCRETE SCORE JOINTS AS SHOWN

FOOT DEPTH MIN. (") FOOT DIA. MIN. (")

0'-10"

0'-10"

1'-0"

0'-10"

1'-0"

1'-0"

4'-0"

4'-0"

6'-0"

4'-0"

4'-0"

6'-0"

6'-0"

PLICABLE. NGS FOR FENCE AS SPECIFIED FOR FENCE FOOTING REQUIREMENTS

CHAINLINK FENCE SIZING

POST DIA.(")

*REVIEW AGAINST FIELD 4. FINAL DEPTH OF FOOTING NOT TO BE LESS THAN 4' OF CONCRETE CONDITIONS AND CONFIRM 5. SLOPE TOP OF FOOTINGS 1-2% PITCHING AWAY FROM POSTS

CHAIN LINK FENCE SIZING TABLE AND NOTES

NOT TO SCALE

SITE ADDRESS

2024 GREEN

UPGRADES

SCHOOL

Owner:

FOREST HOME AVENUE

INFRASTRUCTURE

MILWAUKEE

PUBLIC SCHOOLS

SMITHGROUP

233 NORTH WATER STREET

HELIANTHUS

1836 W. Fond Du Lac Ave. Milwaukee, WI 53205

REV DATE

414-622-0103

ISSUED FOR

SEALS AND SIGNATURES

100% CD

MILWAUKEE, WI 53202

www.smithgroup.com

SUITE 502

414.615.9570


SITE # 173 1516 W FOREST HOME AVENUE MILWAUKEE, WI 53204

DRAWING TITLE

DRAWING NUMBER

SITE DETAILS

SCALE	
	148
PROJECT NUMBER	
	8317, DIVISIO
MPS PROJECT NUMBER	

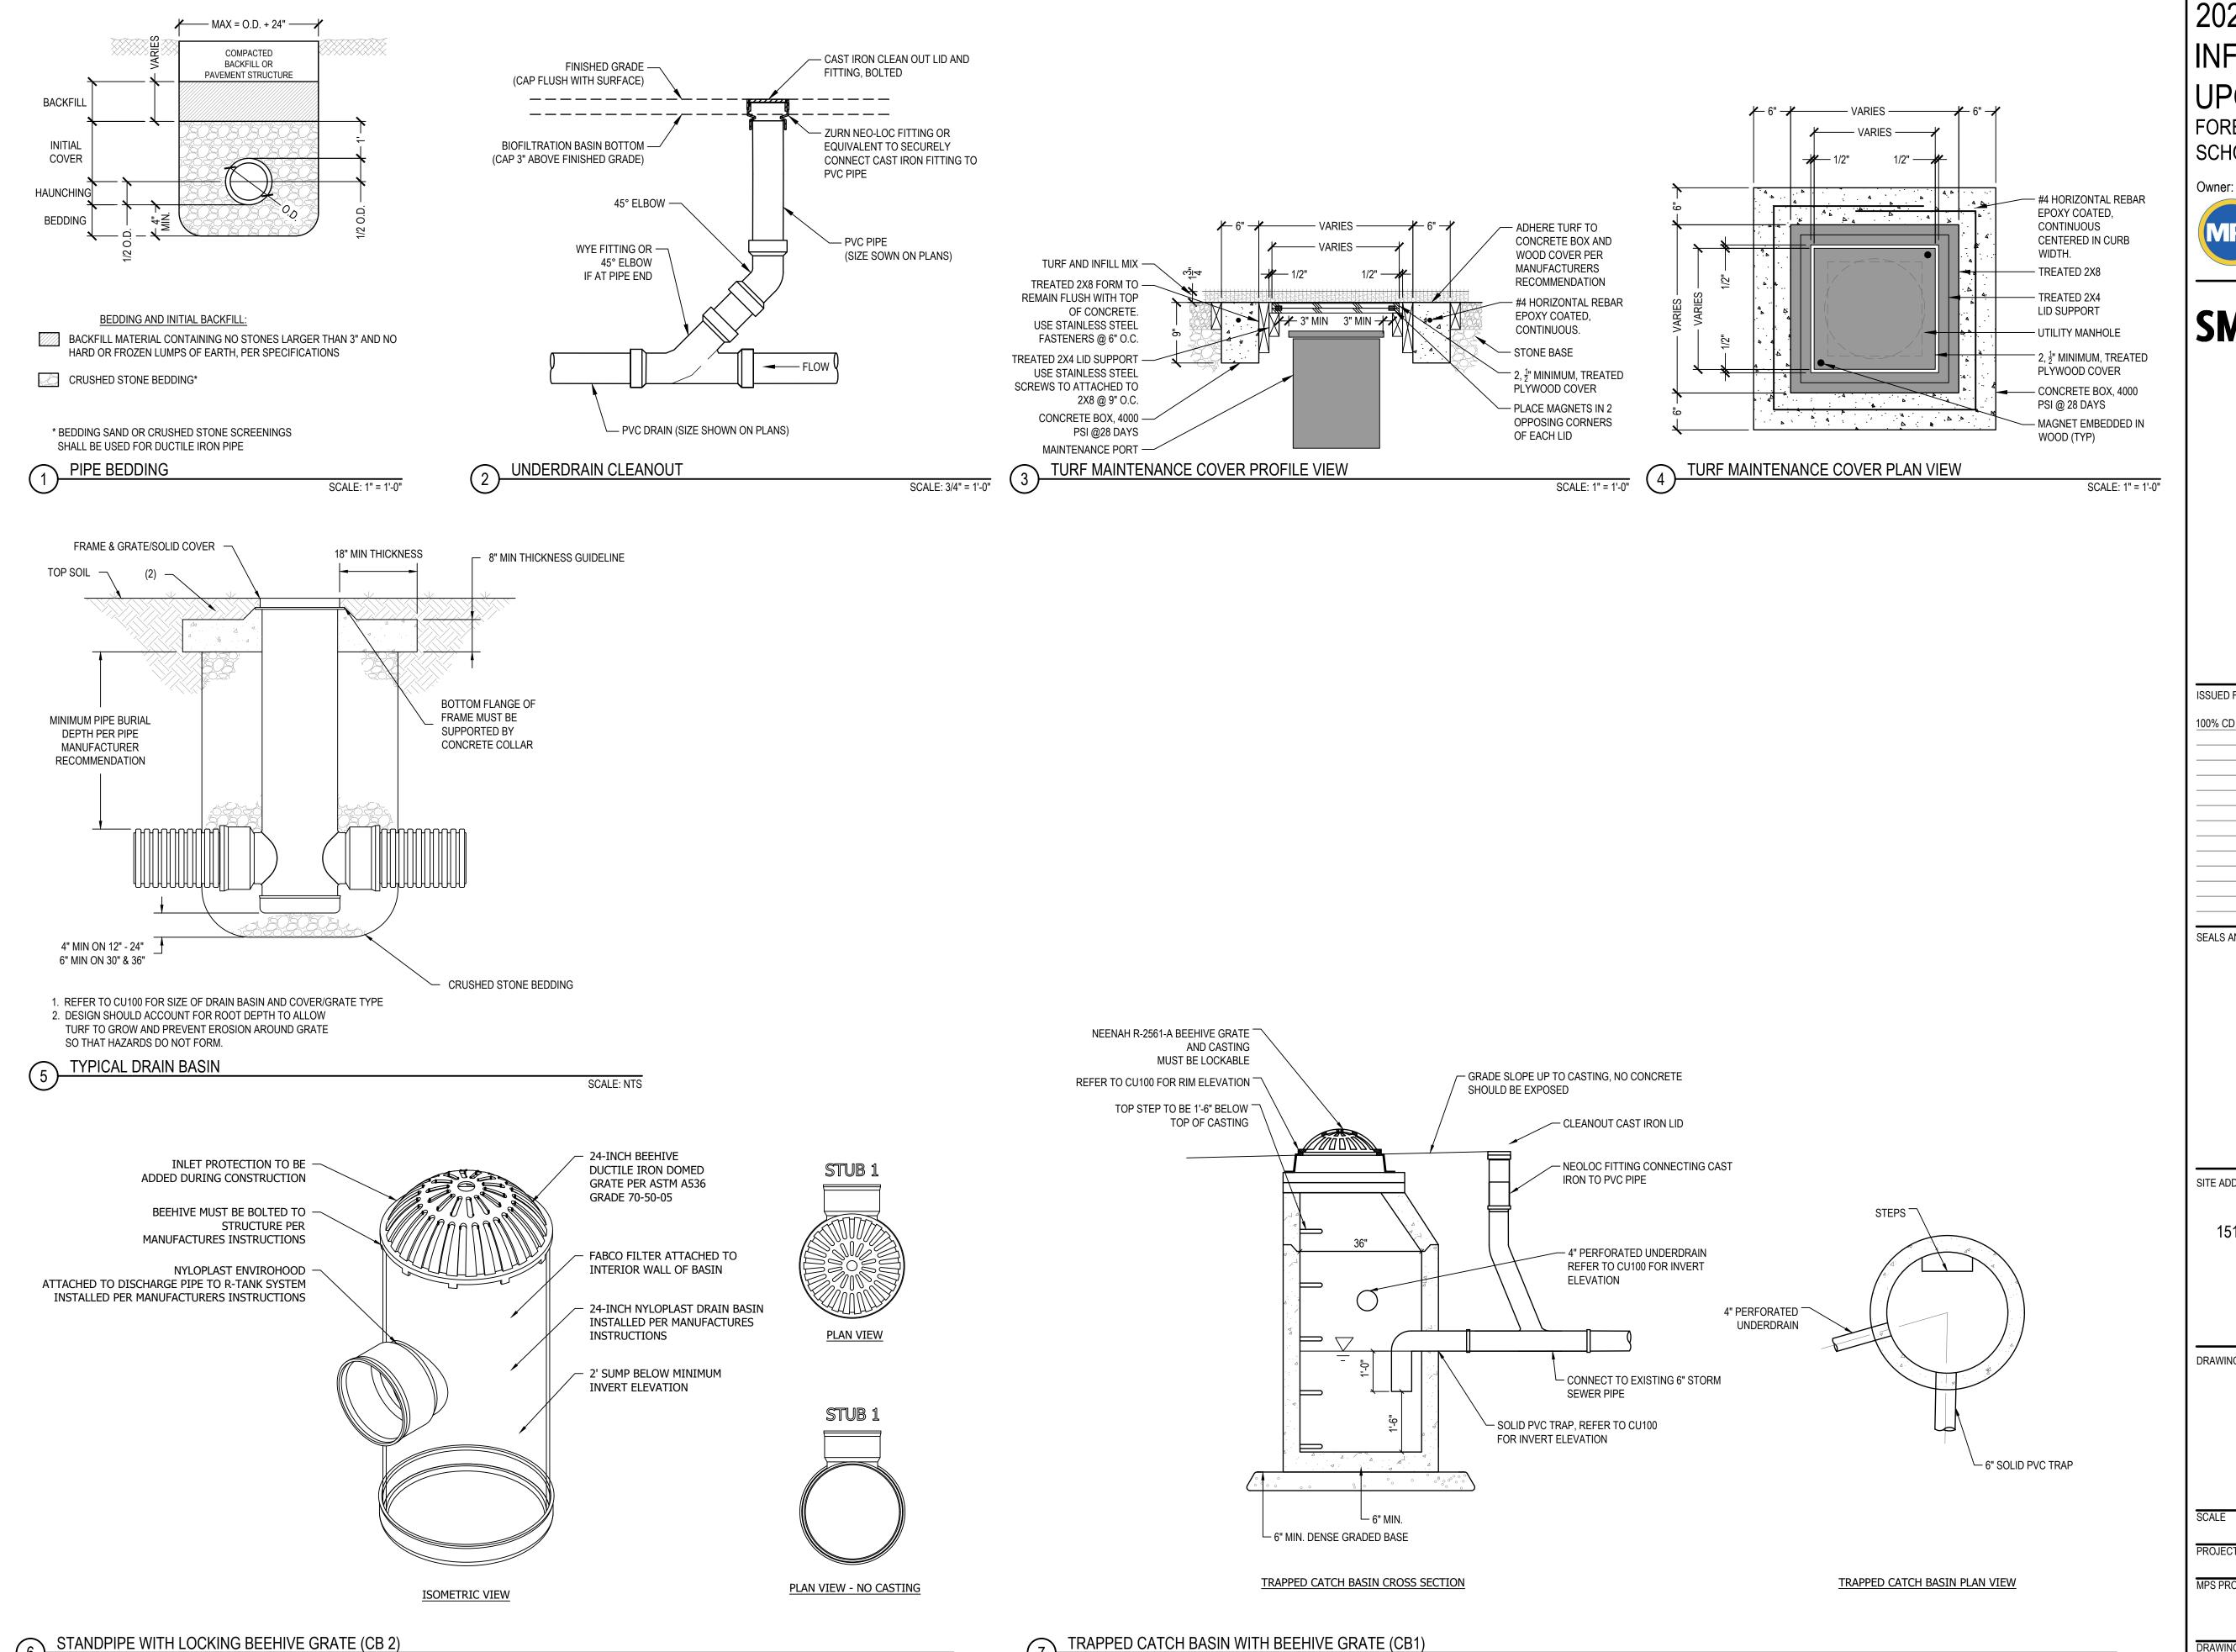

SCALE: 1" = 1'-0"

2024 GREEN INFRASTRUCTURE UPGRADES

FOREST HOME AVENUE SCHOOL



SMITHGROUP

233 NORTH WATER STREET SUITE 502 MILWAUKEE, WI 53202 414.615.9570 www.smithgroup.com



1836 W. Fond Du Lac Ave. Milwaukee, WI 53205 414-622-0103

REV	DATE
	01/25/2024
_	
_	
	REV

SEALS AND SIGNATURES

SITE ADDRESS

SITE # 173 1516 W FOREST HOME AVENUE MILWAUKEE, WI 53204


DRAWING TITLE

DRAWING NUMBER


UTILITY DETAILS

SCALE PROJECT NUMBER 8317, DIVISION 1 MPS PROJECT NUMBER

SCALE: 1/2" = 1'-0"

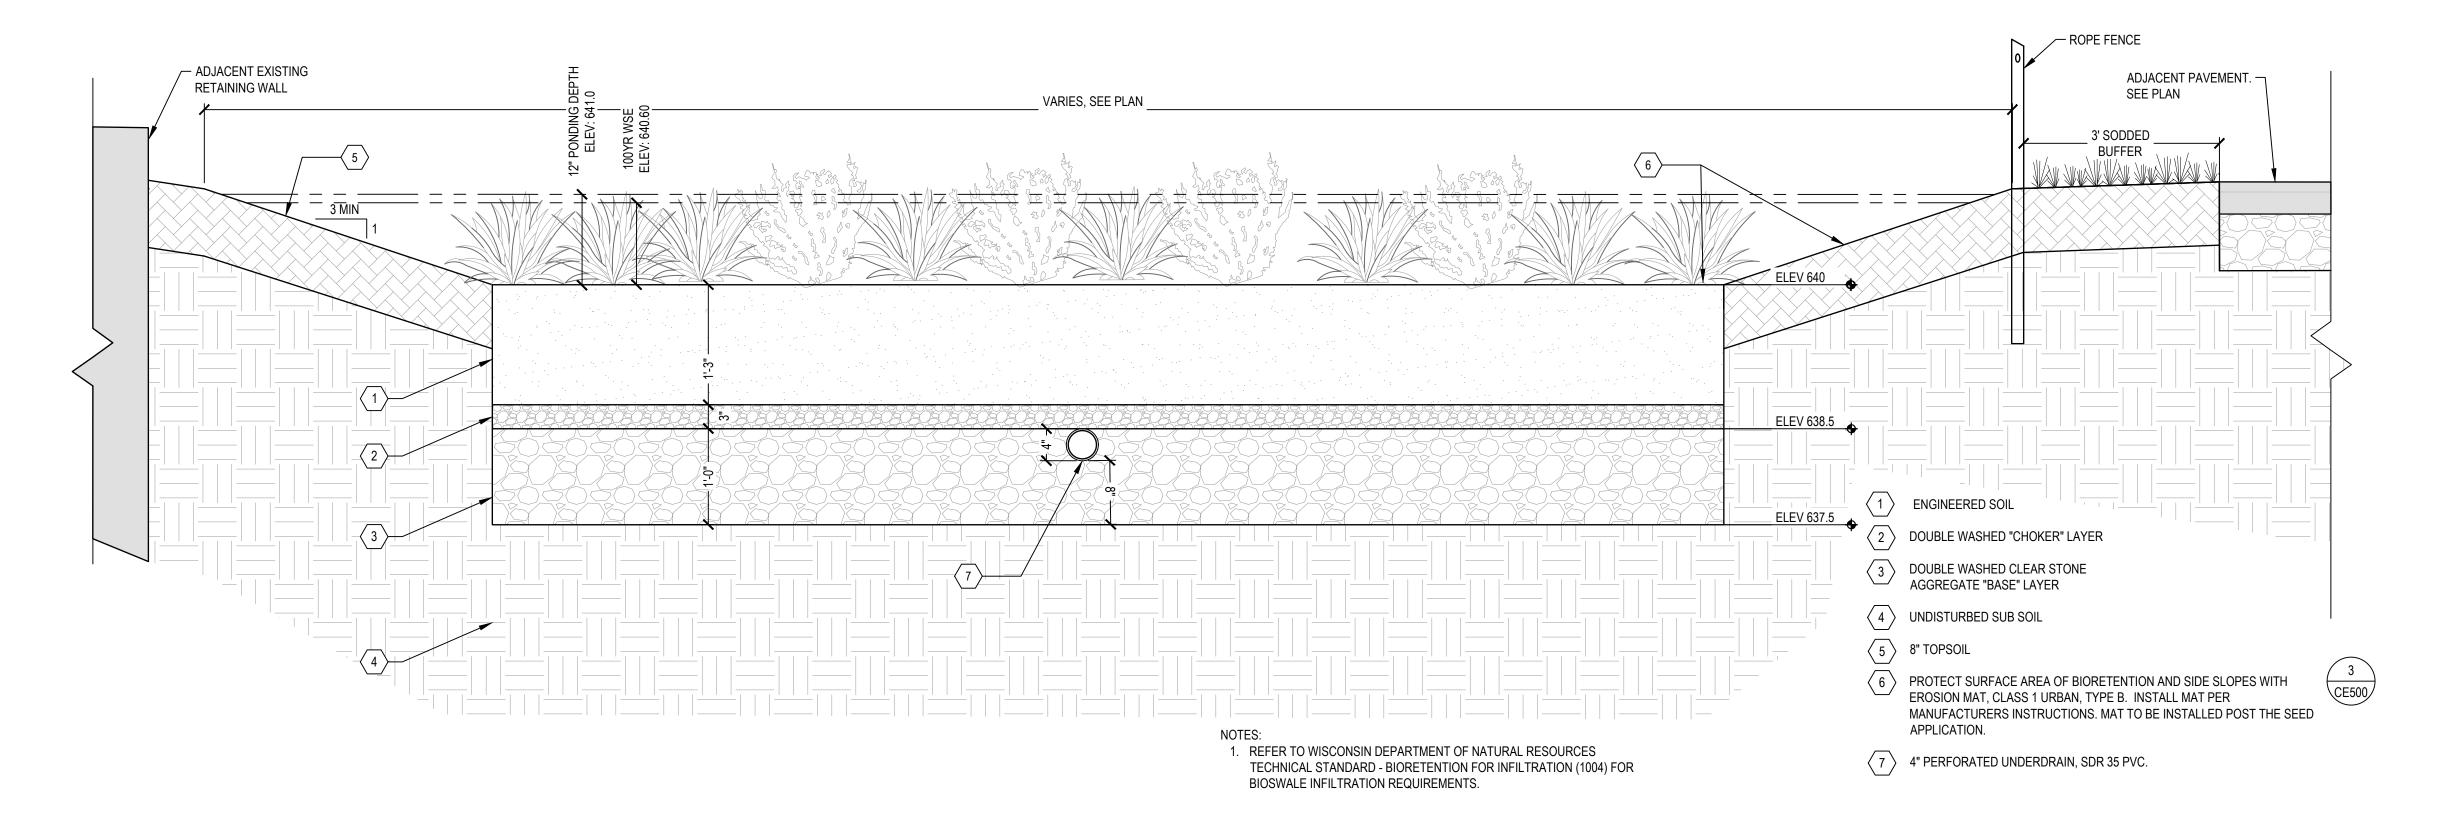

SCALE: 1"=1"

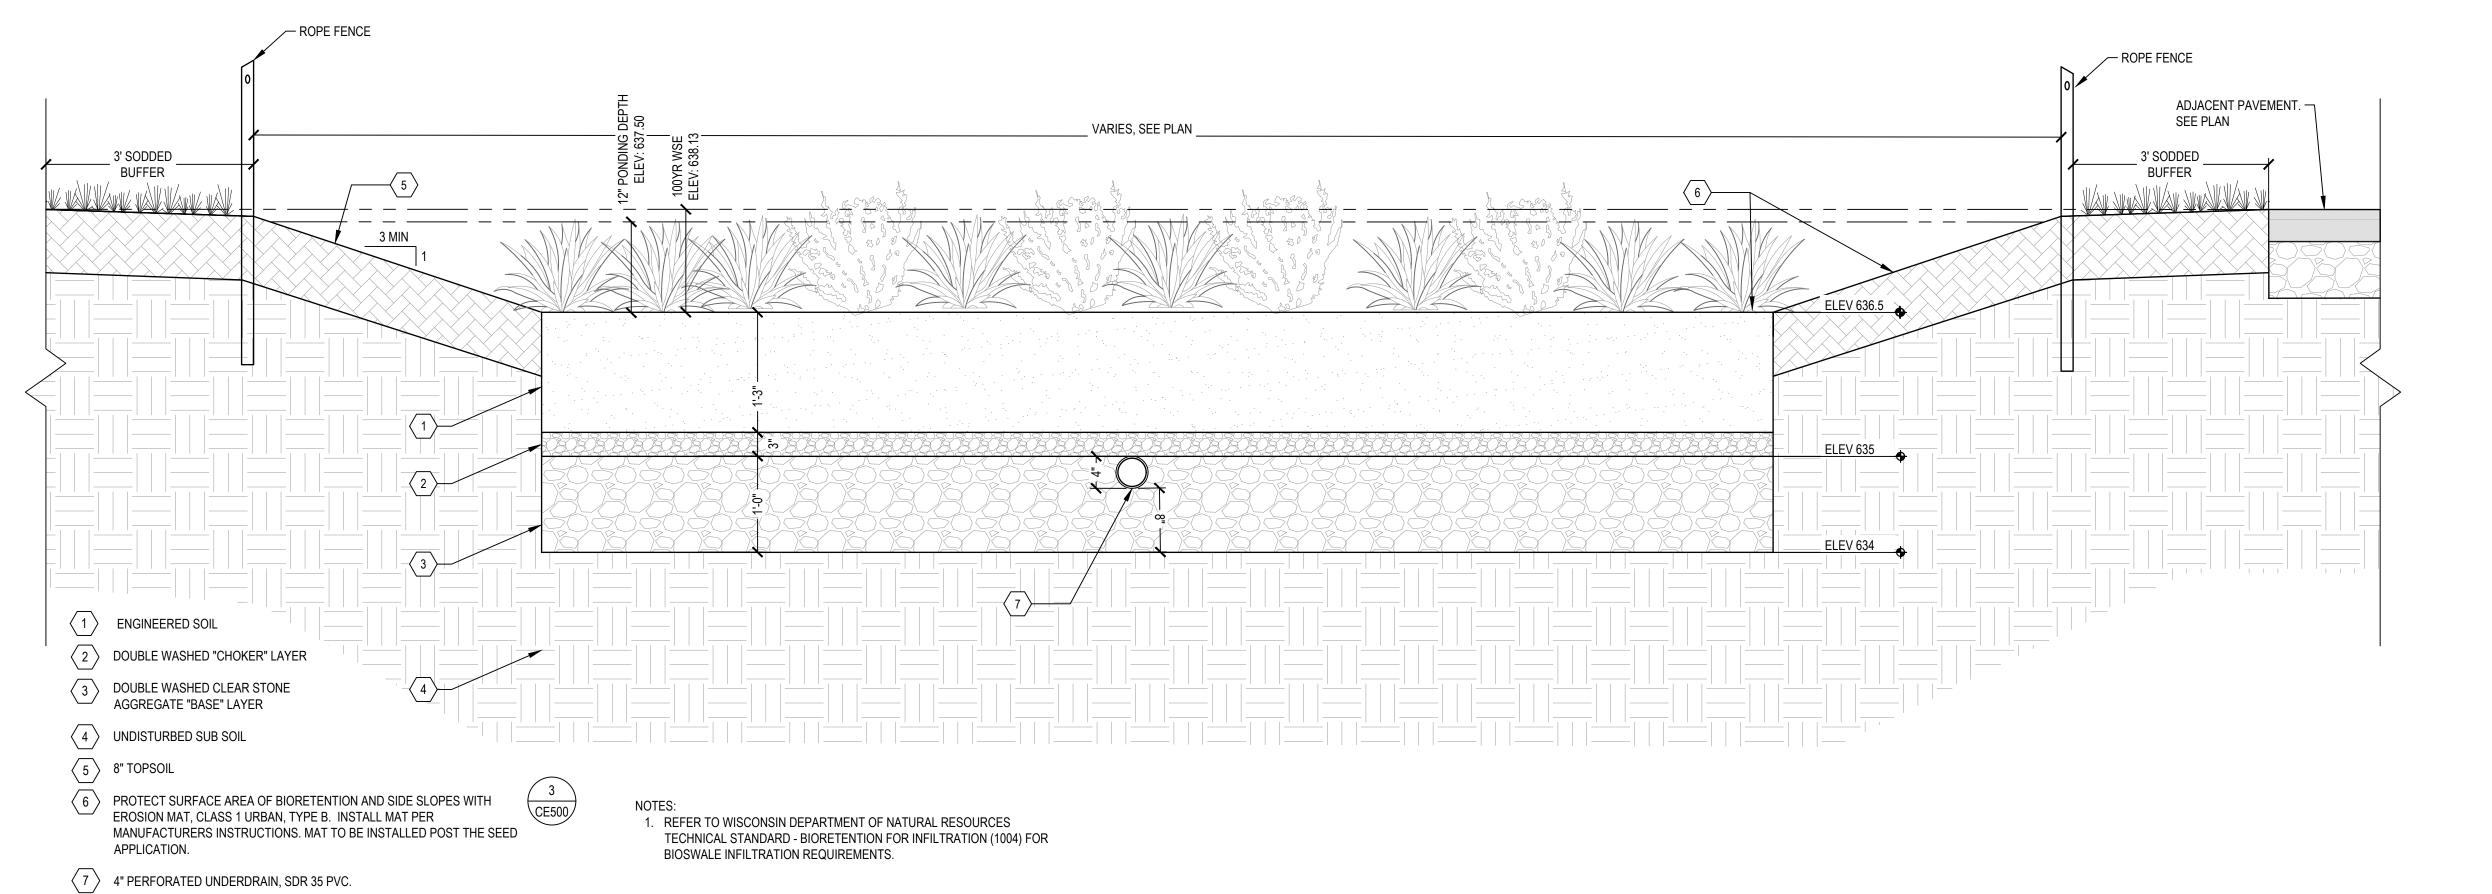

2024 GREEN
INFRASTRUCTURE
UPGRADES

FOREST HOME AVENUE SCHOOL

Owner:



SMITHGROUP

233 NORTH WATER STREET SUITE 502 MILWAUKEE, WI 53202 414.615.9570 www.smithgroup.com



1836 W. Fond Du Lac Ave. Milwaukee, WI 53205 414-622-0103

REV	DATE
	01/25/2024
	REV

SITE ADDRESS

SITE # 173 1516 W FOREST HOME AVENUE MILWAUKEE, WI 53204

DRAWING TITLE


UTILITY DETAILS

SCALE	
	14895
PROJECT NUMBER	
	8317, DIVISION 1
MPS PROJECT NUMBER	
	C11501

DRAWING NUMBER

NORTH BIORETENTION

SCALE: 1" = 1'

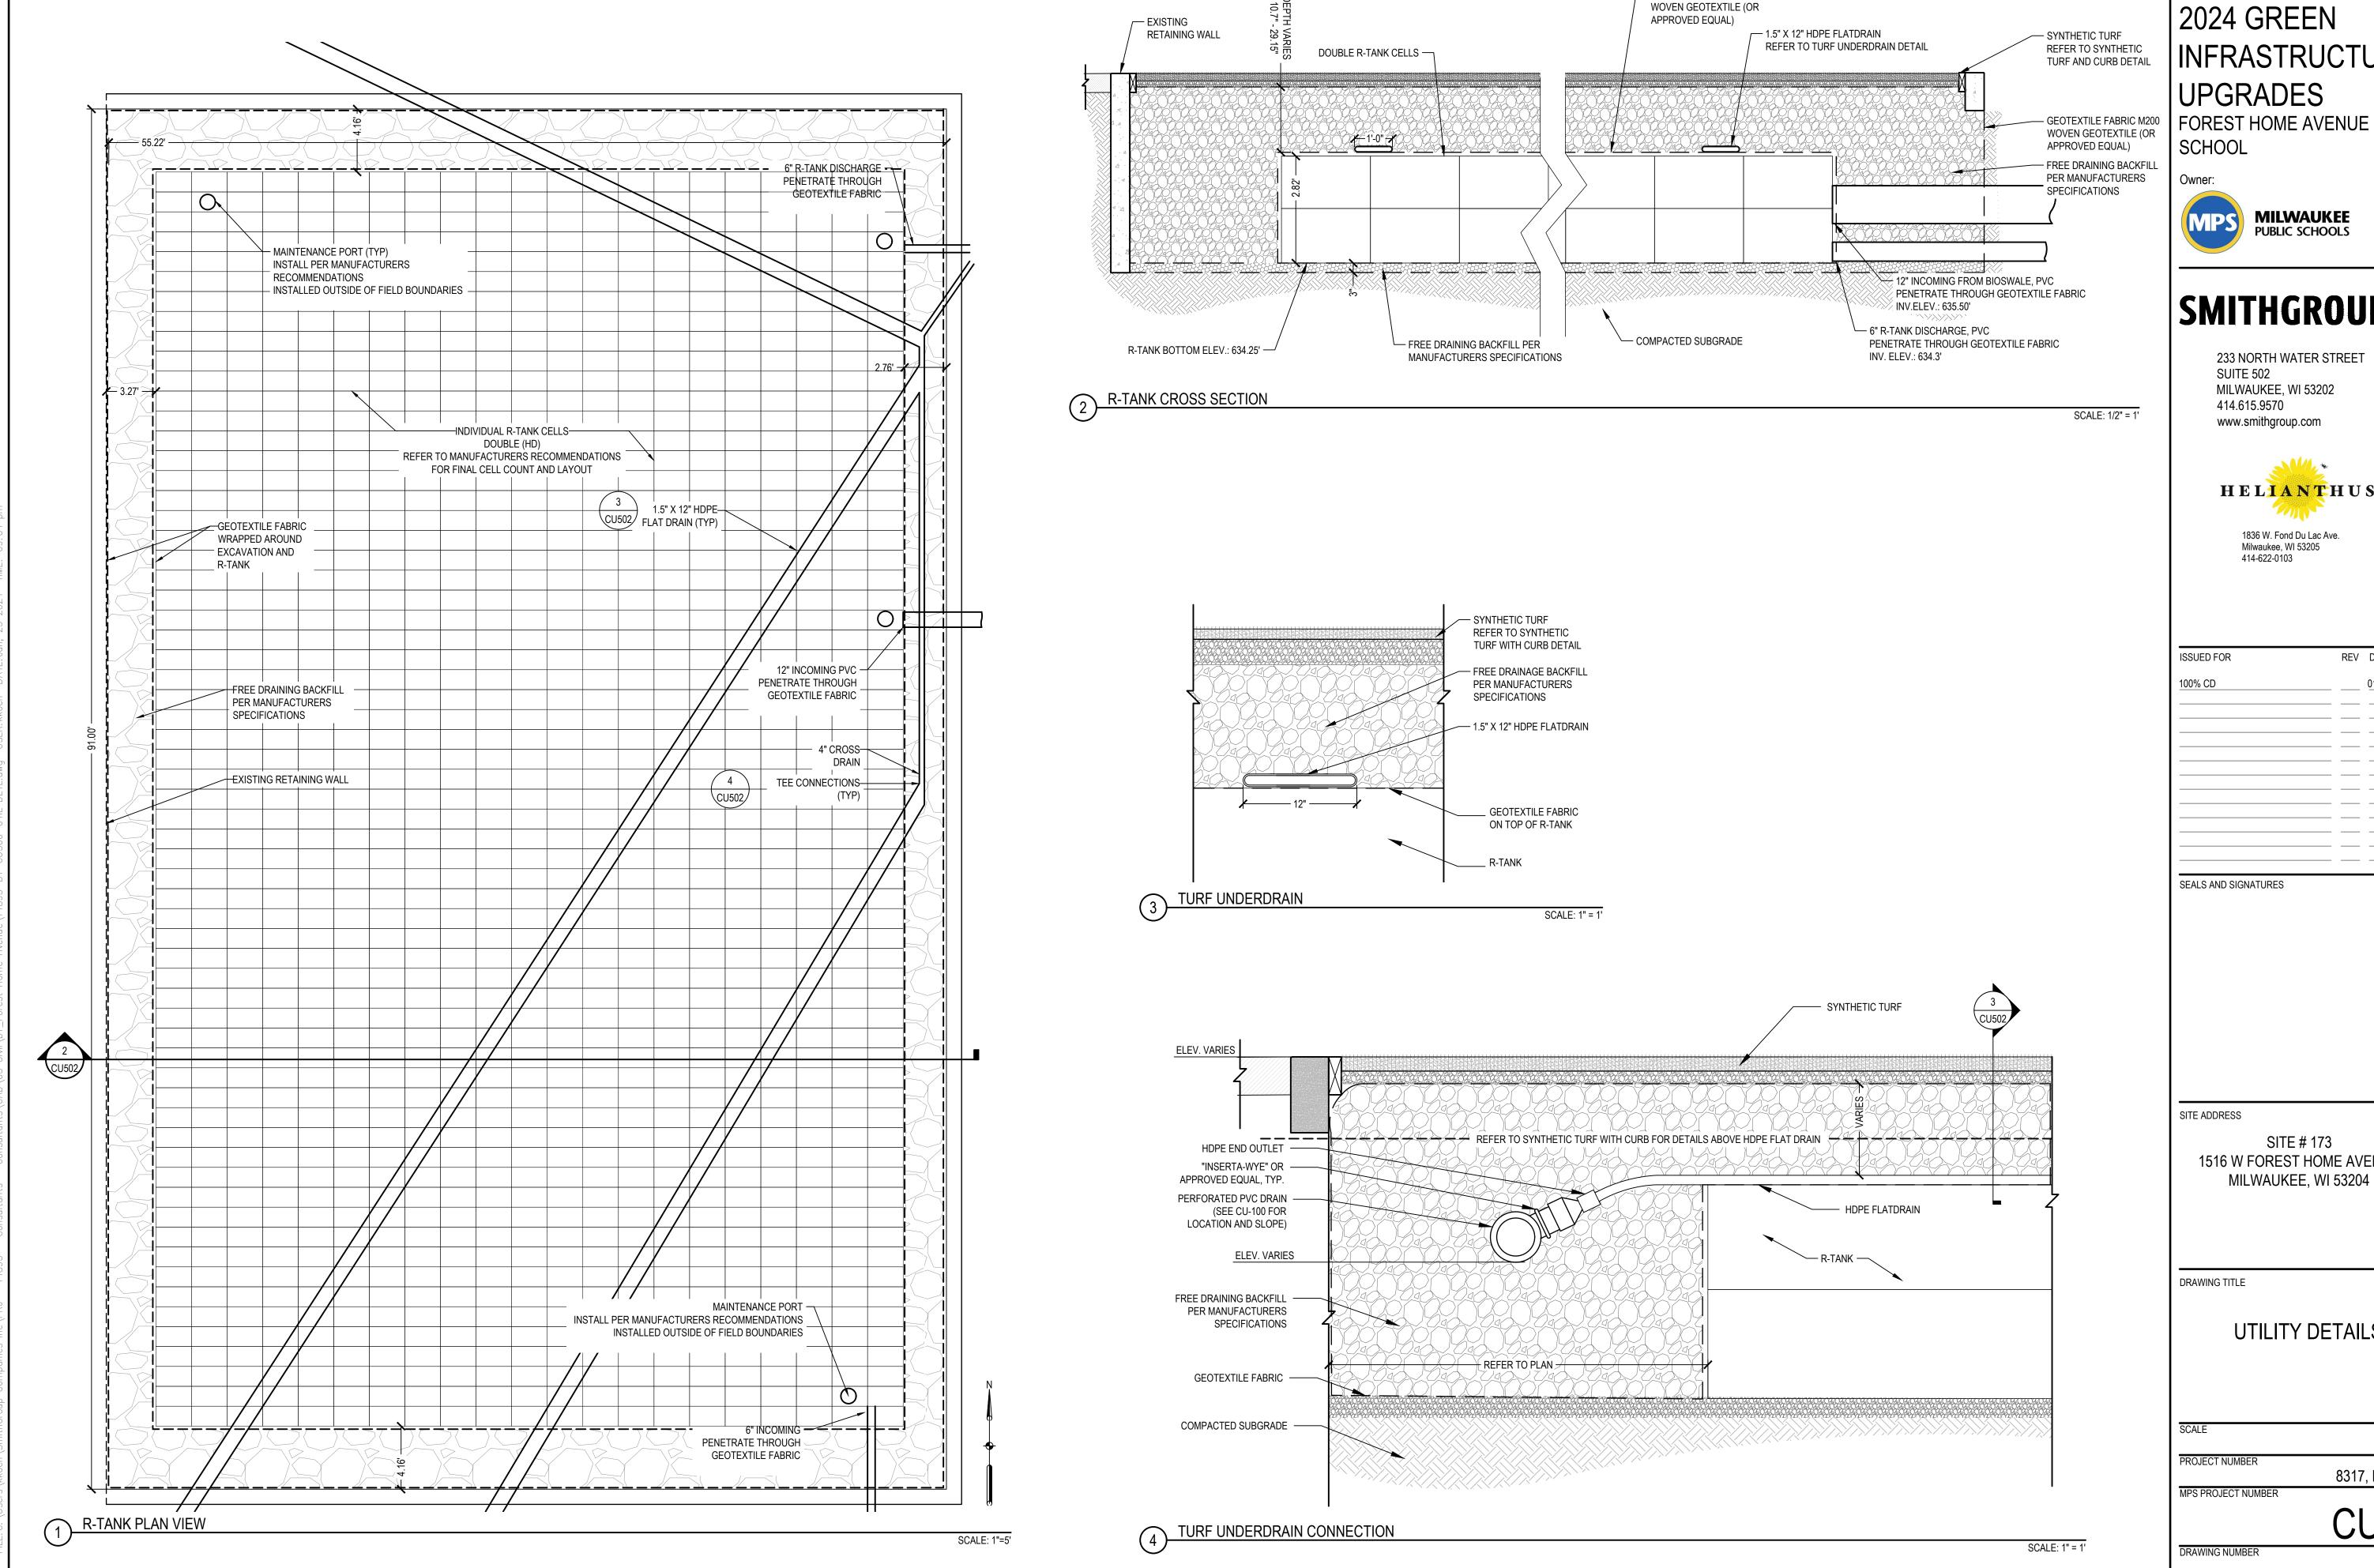

INFRASTRUCTURE

GEOTEXTILE FABRIC, M200

SMITHGROUP

233 NORTH WATER STREET



1836 W. Fond Du Lac Ave.

SUED FOR	REV	DATE
0% CD		01/25/2024
	_	
	_	
	_	
ALC AND CICNATURES		

1516 W FOREST HOME AVENUE MILWAUKEE, WI 53204

UTILITY DETAILS

MPS PROJECT NUMBER	CU502
PROJECT NUMBER	8317, DIVISION 1
SCALE	14895

ALL STRIPING IS TO BE 2" IN WIDTH EXCEPT FOR "HORSE" SOLID CIRCLES. REFER TO CP100 FOR HORSE CIRCLE COLOR AND STRIPING COLOR.
 SAFETY ZONE SHALL BE CLEAR OF ALL VERTICAL OBSTRUCTIONS AND GRADE CHANGES. MATERIAL CHANGES ARE ALLOWABLE, SO LONG AS IT MEETS OTHER

3. SAFETY ZONE DIMENSIONS SHOULD REFER TO LAYOUT SHEET, CS100

4. DIMENSIONS INSIDE OF STRIPING UNLESS INDICATED OTHERWISE BY "OUT" IN THE ANNOTATION.

5. LENGTH OF HOOP GOOSENECK TO BE 4'-0" TO 6'-0" AND POST LOCATION UPDATED ACCORDINGLY



2024 GREEN INFRASTRUCTURE UPGRADES FOREST HOME AVENUE

SCHOOL



SMITHGROUP

233 NORTH WATER STREET SUITE 502 MILWAUKEE, WI 53202 414.615.9570 www.smithgroup.com



1836 W. Fond Du Lac Ave. Milwaukee, WI 53205 414-622-0103

ISSUED FOR	REV	DATE
100% CD		01/25/2024

SEALS AND SIGNATURES

SITE ADDRESS

SITE # 173 1516 W FOREST HOME AVENUE MILWAUKEE, WI 53204

DRAWING TITLE


PAVEMENT MARKING **DETAILS**

SCALE PROJECT NUMBER 8317, DIVISION 1 MPS PROJECT NUMBER

DRAWING NUMBER

SCALE: 1/4" = 1'

BASKETBALL COURT (MPS STANDARD DETAIL)

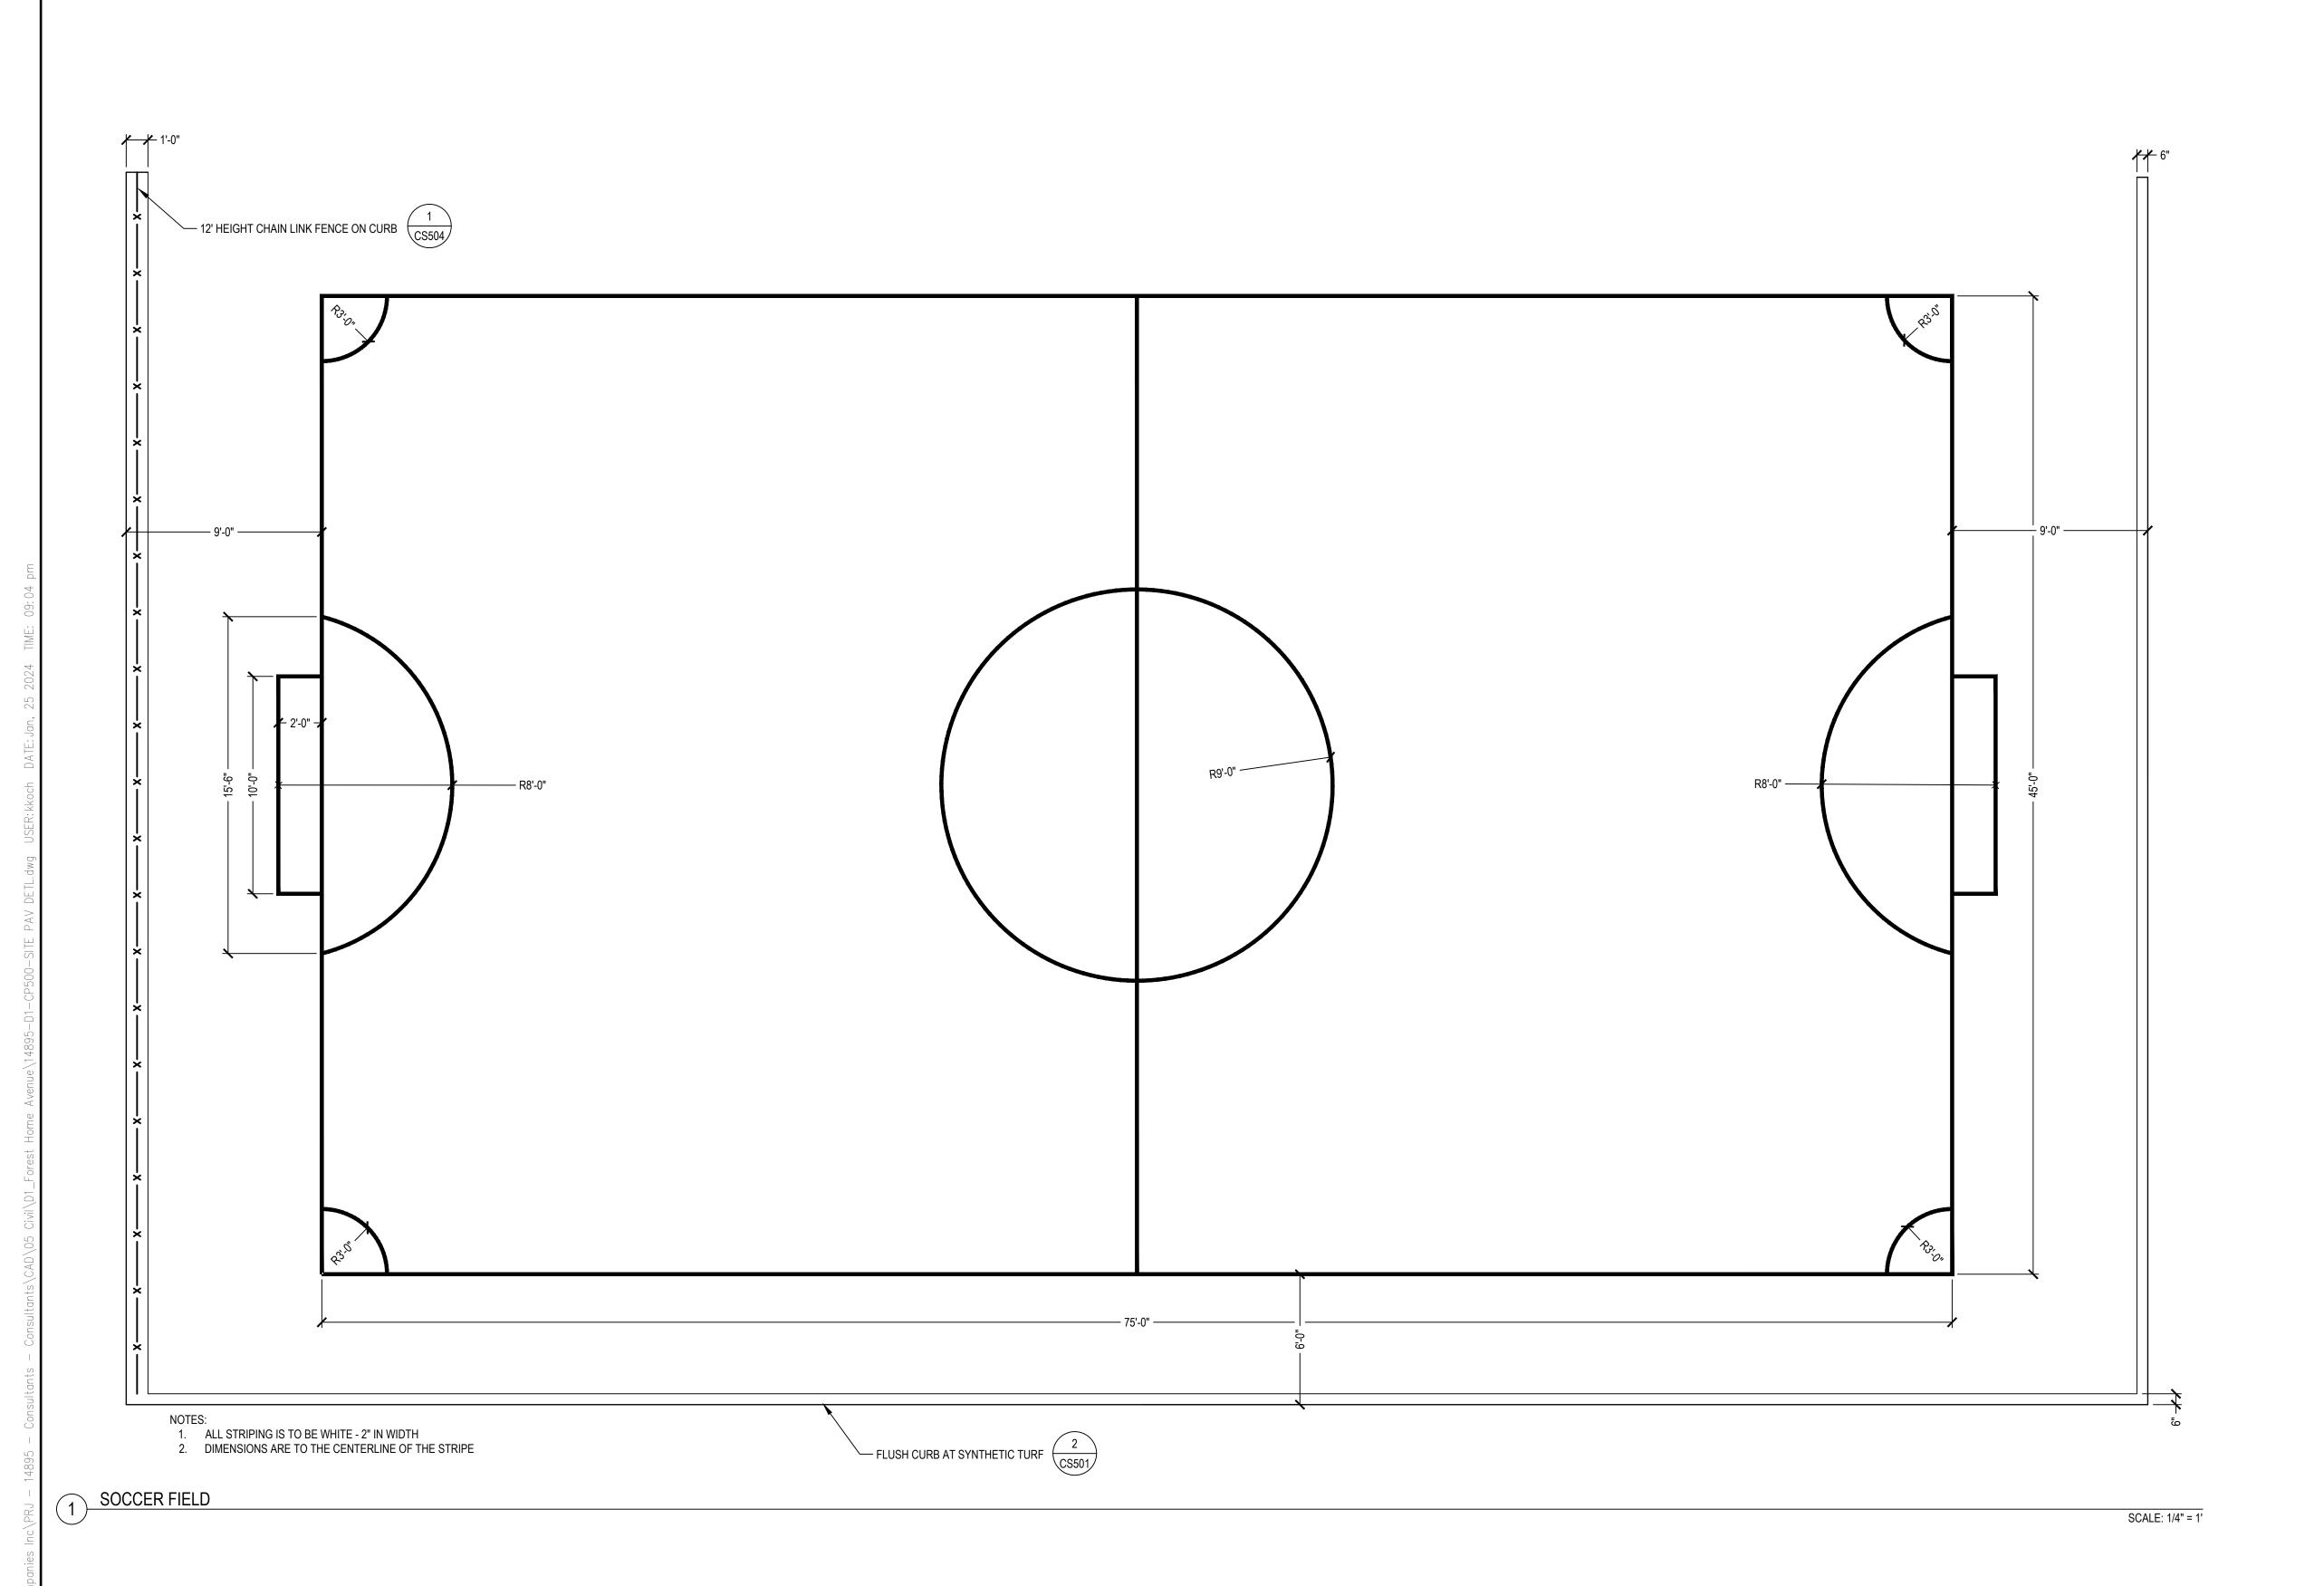

2024 GREEN INFRASTRUCTURE UPGRADES

FOREST HOME AVENUE SCHOOL

Owner:



SMITHGROUP

233 NORTH WATER STREET SUITE 502 MILWAUKEE, WI 53202 414.615.9570 www.smithgroup.com



1836 W. Fond Du Lac Ave. Milwaukee, WI 53205 414-622-0103

ISSUED FOR	REV	DATE
100% CD		01/25/2024
SEALS AND SIGNATURES		

SITE ADDRESS


SITE # 173 1516 W FOREST HOME AVENUE MILWAUKEE, WI 53204

DRAWING TITLE

DRAWING NUMBER

PAVEMENT MARKING DETAILS

20415	
SCALE	14895
PROJECT NUMBER	11000
PROJECT NOWIDEN	8317, DIVISION
MPS PROJECT NUMBER	
	CP501

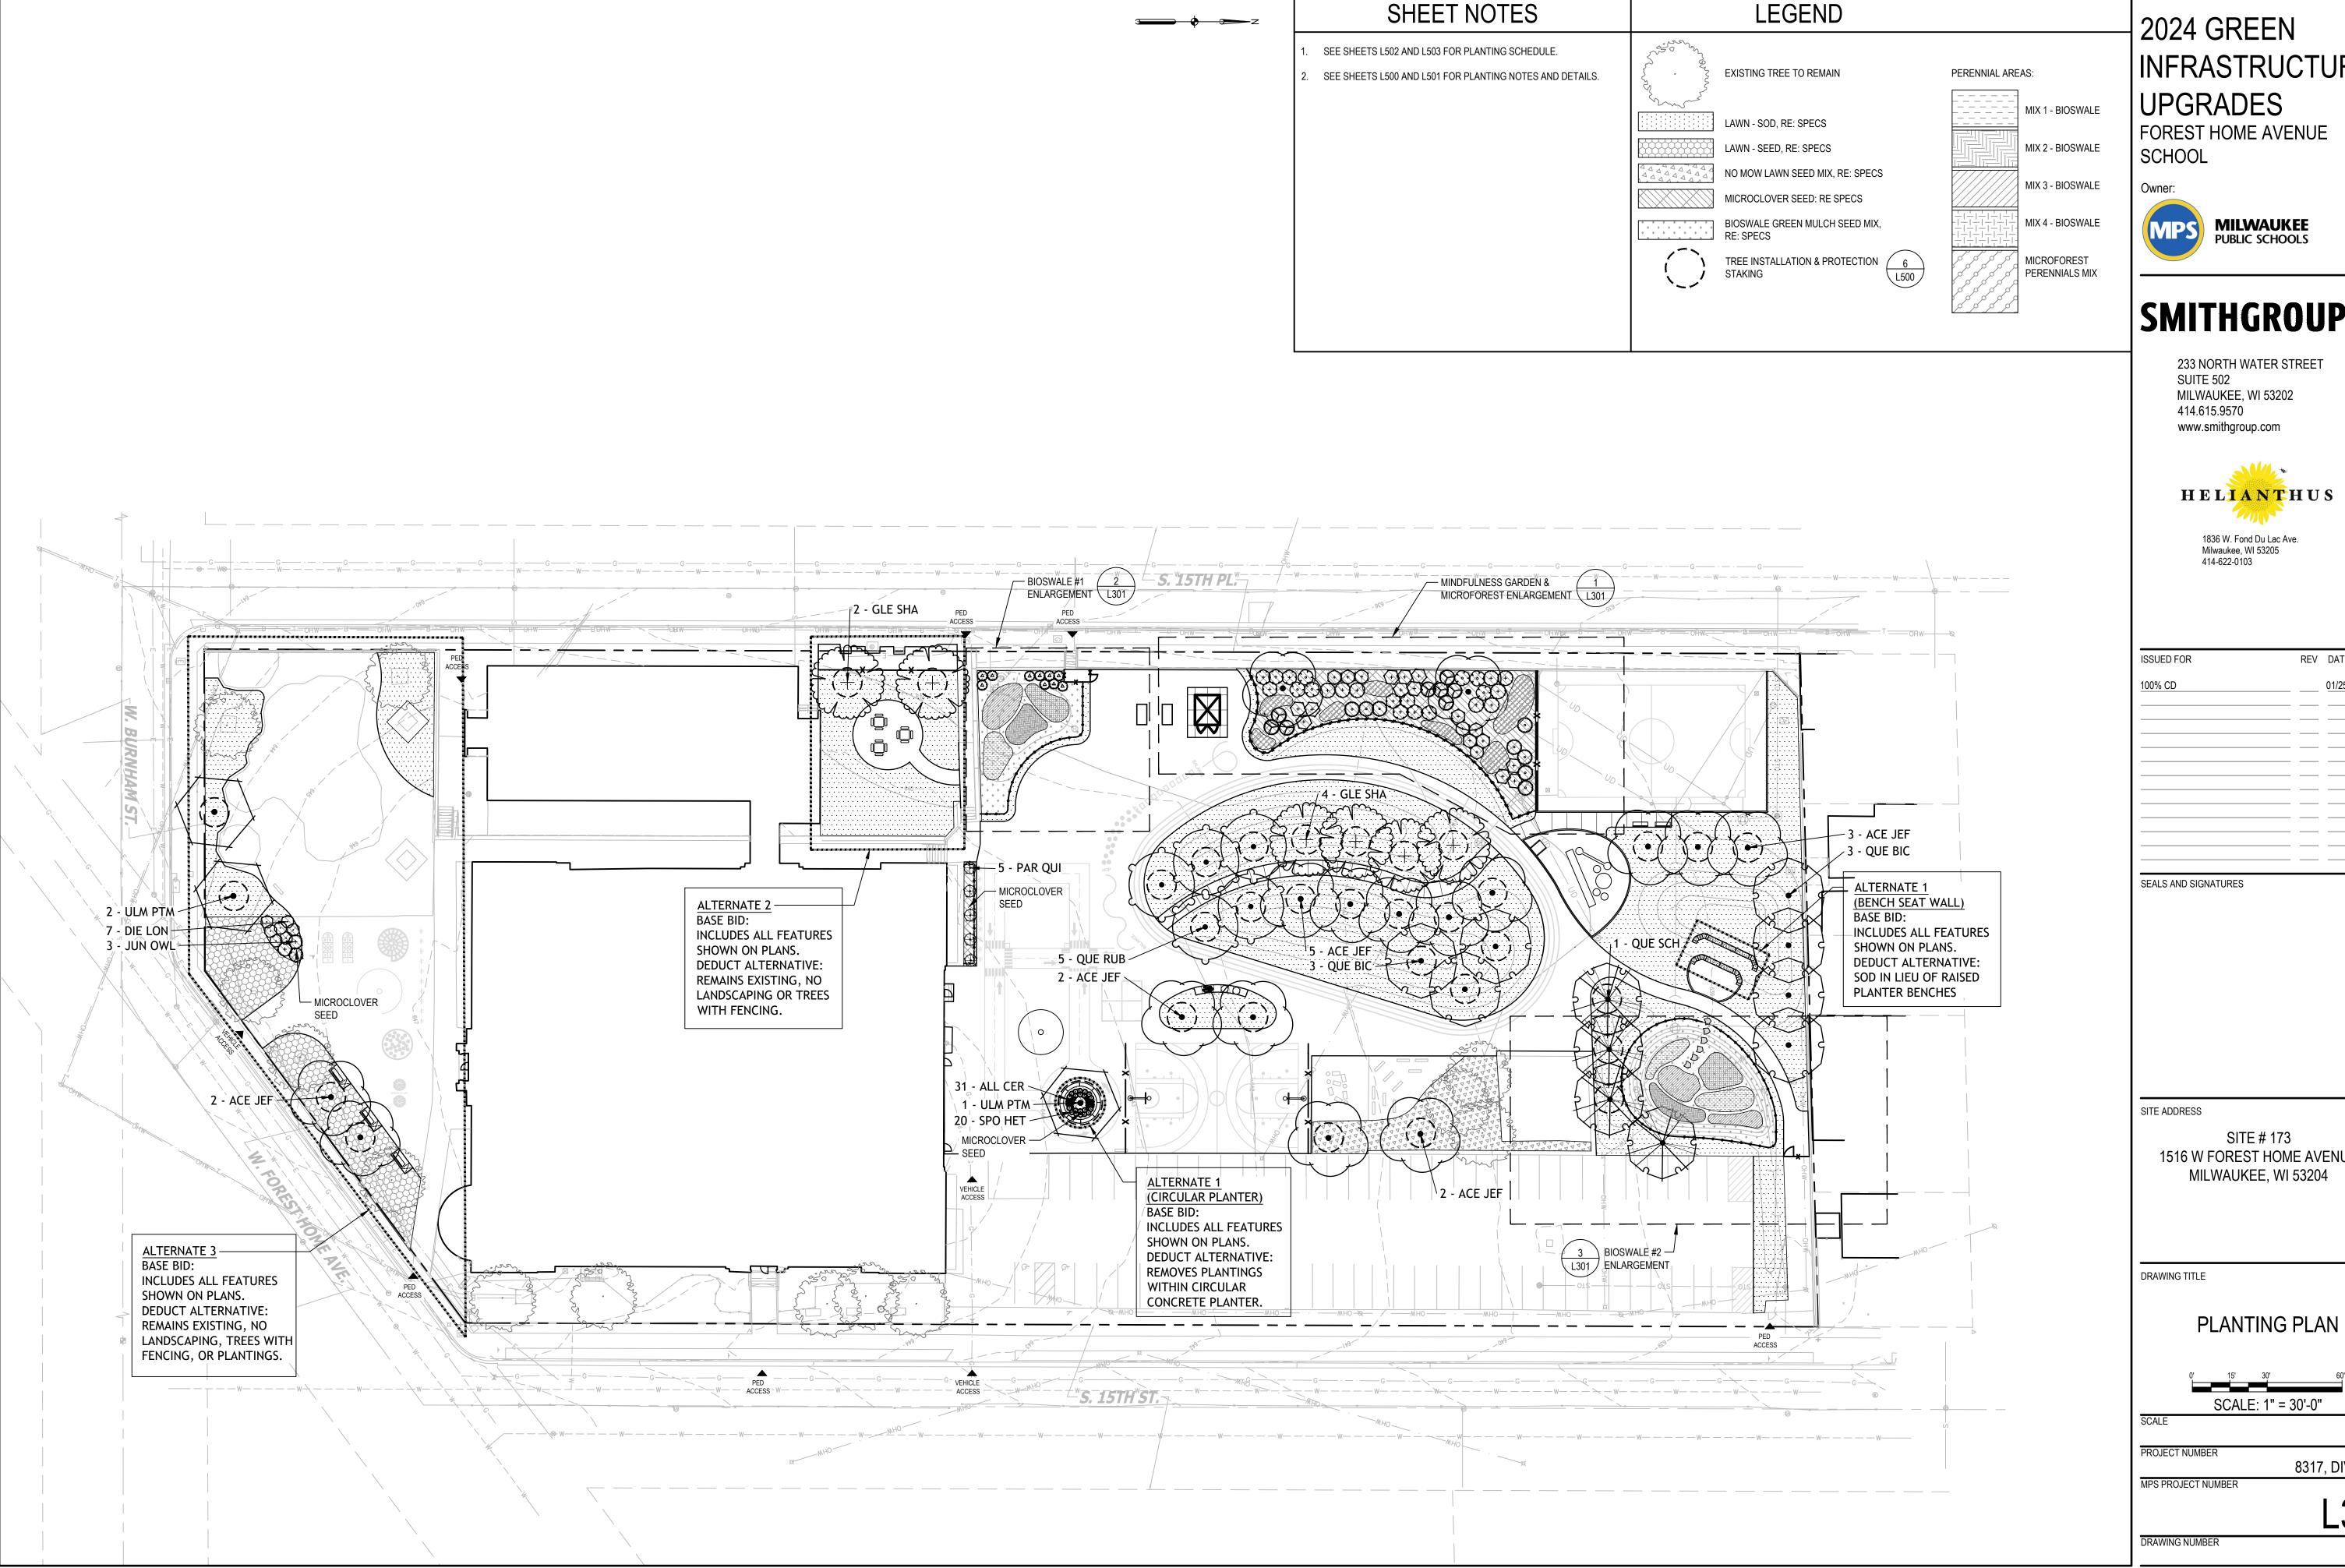

INFRASTRUCTURE

FOREST HOME AVENUE




SMITHGROUP

233 NORTH WATER STREET




ISSUED FOR	KEV	DATE
100% CD		01/25/2024
	_	

1516 W FOREST HOME AVENUE MILWAUKEE, WI 53204

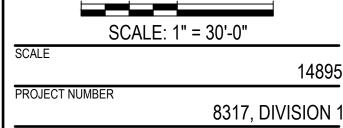

L300

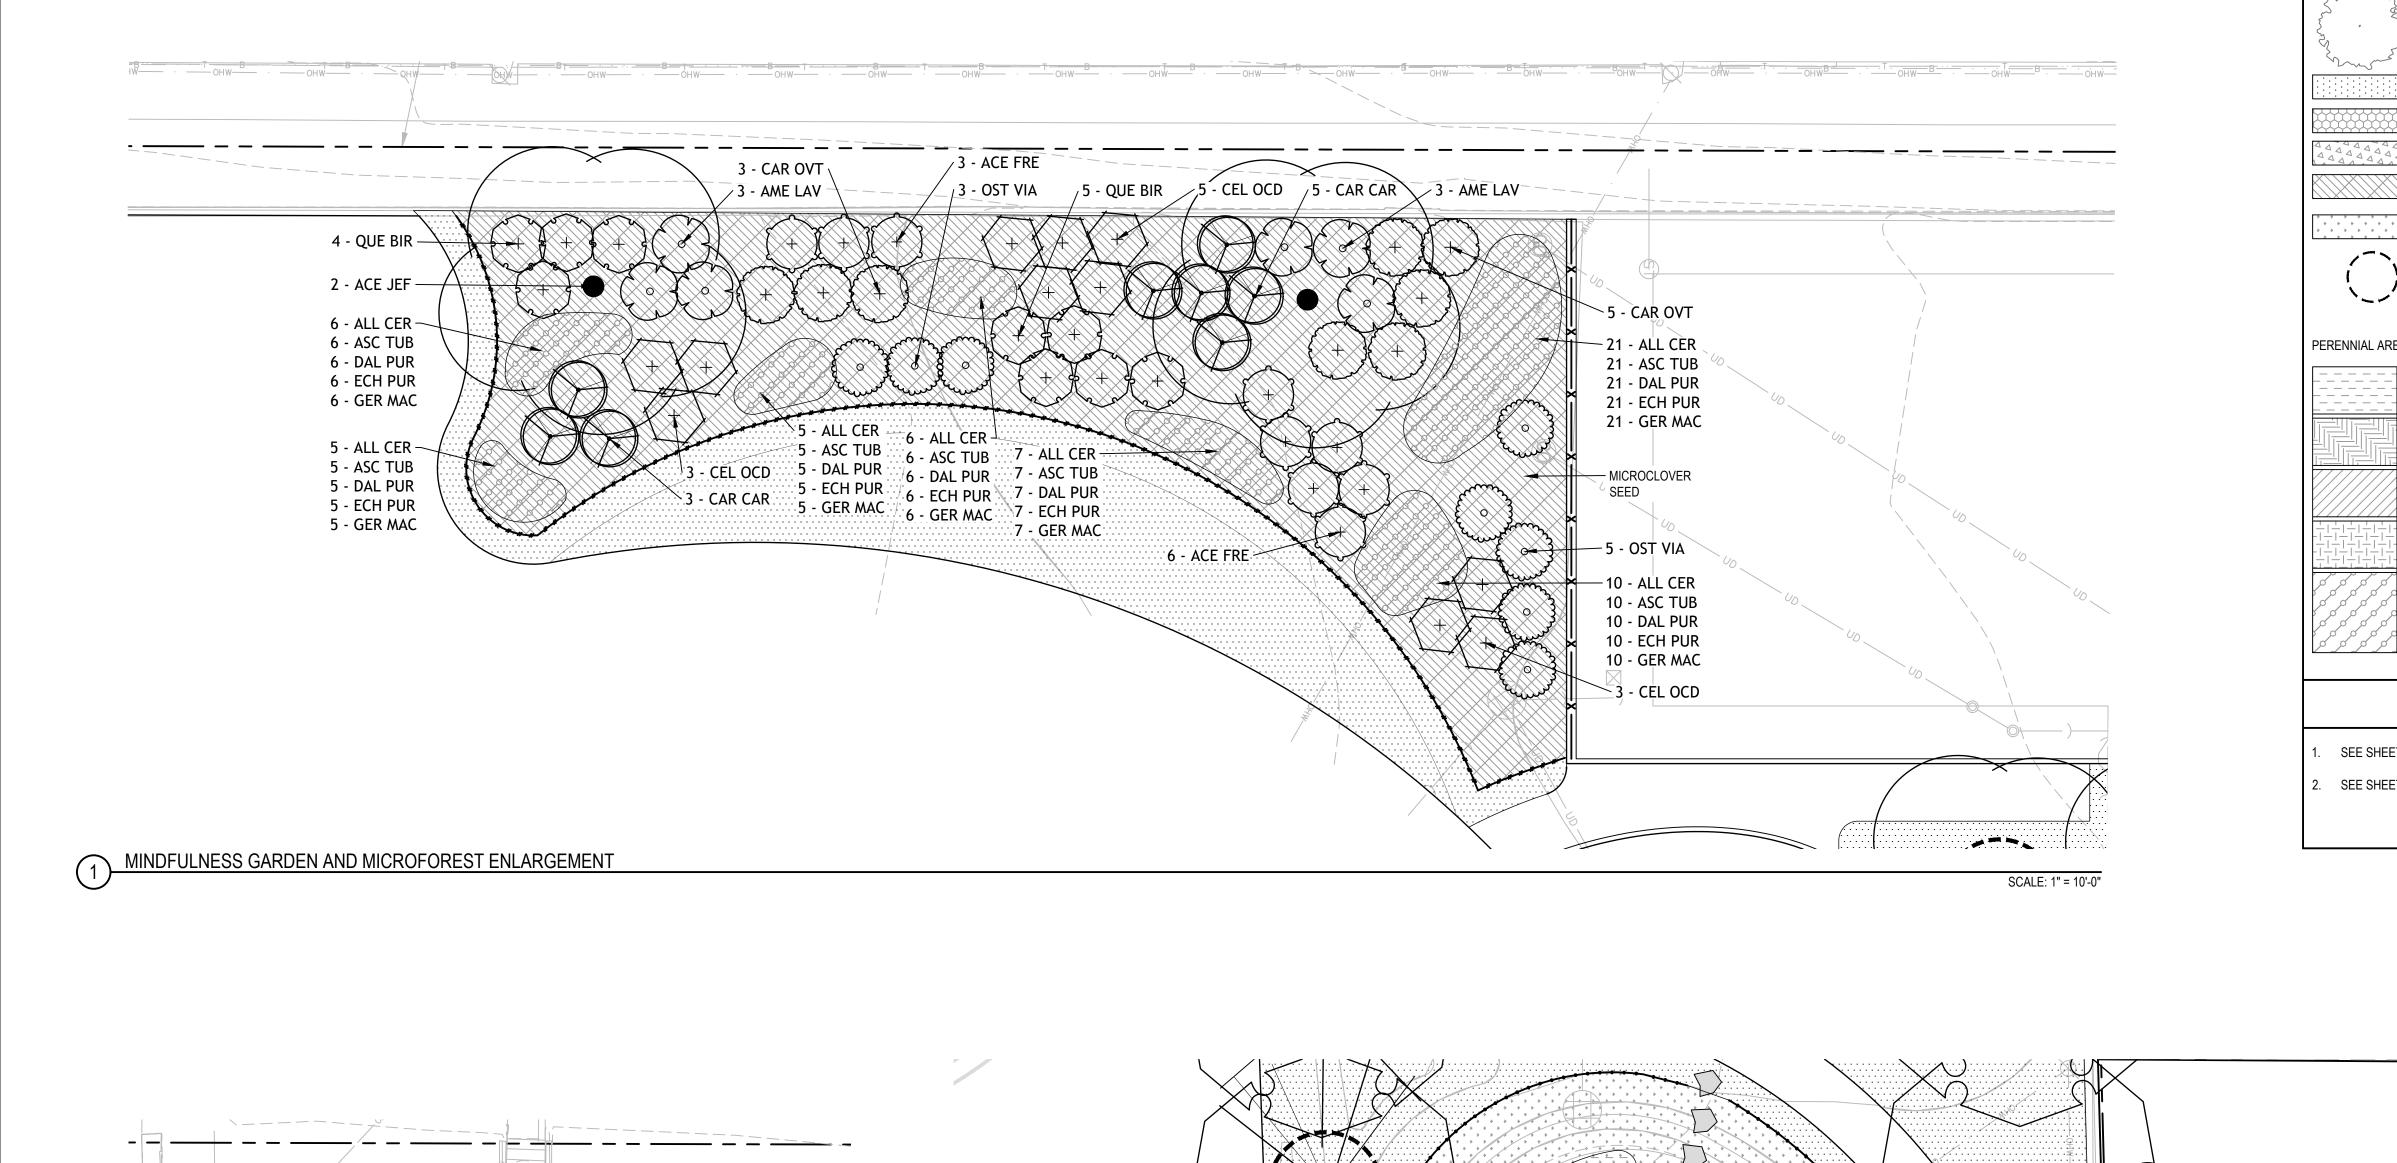

-10 - COR FAR

— 35 - LIA SPI

- BIOSWALE

SEED MIX

[►]48 - SYM NOV 48 - ZIZ AUR

-38 - RUD FUL

38 - TRA OHI

BIOSWALE #1 ENLARGEMENT

35 - PYC VIR

GREEN MULCH

37 - EUP PUR

37 - PEN DIG

LEGEND EXISTING TREE TO REMAIN LAWN - SOD, RE: SPECS LAWN - SEED, RE: SPECS NO MOW LAWN SEED MIX, RE: SPECS MICROCLOVER SEED: RE SPECS BIOSWALE GREEN MULCH SEED MIX, RE: SPECS TREE INSTALLATION & PROTECTION 6 L500 PERENNIAL AREAS: MIX 1 - BIOSWALE MIX 2 - BIOSWALE MIX 3 - BIOSWALE MIX 4 - BIOSWALE MICROFOREST PERENNIALS MIX

SHEET NOTES

SEE SHEETS L502 AND L503 FOR PLANTING SCHEDULE

SCALE: 1" = 10'-0"

SEE SHEETS L500 AND L501 FOR PLANTING NOTES AND DETAILS.

REV DATE ISSUED FOR 100% CD SEALS AND SIGNATURES

2024 GREEN

UPGRADES

SCHOOL

Owner:

FOREST HOME AVENUE

MILWAUKEE PUBLIC SCHOOLS

SMITHGROUP

233 NORTH WATER STREET

HELIANTHUS

1836 W. Fond Du Lac Ave. Milwaukee, WI 53205 414-622-0103

MILWAUKEE, WI 53202

www.smithgroup.com

SUITE 502

414.615.9570

INFRASTRUCTURE

SITE ADDRESS

SITE # 173 1516 W FOREST HOME AVENUE MILWAUKEE, WI 53204

DRAWING TITLE

PLANTING PLAN **ENLARGEMENTS**

SCALE: 1" = 10'-0" SCALE

PROJECT NUMBER 8317, DIVISION 7


MPS PROJECT NUMBER L301

DRAWING NUMBER

— 1 - QUE BIC 3 - QUE SCH / 26 - RUD FUL 26 - TRA OHI ~ 41 - LIA SPI 41 - PYC VIR – 41 - RUD FUL 41 - TRA OHI - BIOSWALE **GREEN MULCH** SEED MIX – 24 - SYM NOV 24 - ZIZ AUR 35 - EUP PUR 35 - PEN DIG [\]38 - SYM NOV 38 - ZIZ AUR 3 BIOSWALE #2 ENLARGEMENT

PLANTING NOTES

- CONTRACTOR SHALL INSPECT THE SITE AND BECOME FAMILIAR WITH EXISTING CONDITIONS RELATED TO THE NATURE AND SCOPE OF WORK.
- 2. CONTRACTOR SHALL VERIFY LOCATION OF UNDERGROUND AND ABOVE GROUND UTILITIES AND PROVIDE THE NECESSARY PROTECTION BEFORE CONSTRUCTION BEGINS.
- CONTRACTOR SHALL VERIFY PLAN LAYOUT AND DIMENSIONS SHOWN AND BRING TO THE ATTENTION OF THE PRIME CONSULTANT DISCREPANCIES WHICH MAY COMPROMISE THE DESIGN AND/OR INTENT OF THE PROJECT'S LAYOUT.
- 4. CONTRACTOR SHALL ASSURE COMPLIANCE WITH APPLICABLE CODES AND REGULATIONS GOVERNING THE WORK AND/OR MATERIALS SUPPLIED.
- CONTRACTOR SHALL PROTECT EXISTING ROADS, CURBS/GUTTERS, TRAILS, SIDEWALKS, TREES, LAWNS AND OTHER SITE ELEMENTS DURING CONSTRUCTION OPERATIONS. DAMAGE TO SAME SHALL BE REPAIRED AT NO ADDITIONAL COST TO THE OWNER.
- CONTRACTOR TO MAINTAIN EXISTING GRADE WITHIN THE TREE CANOPY LINE (MINIMUM) OF TREES TO BE PRESERVED AND PROTECTED UNLESS OTHERWISE INDICATED ON THE PLANS. REFERENCE SPECIFICATIONS FOR ADDITIONAL TREE PROTECTION INFORMATION.
- NO PRUNING SHALL BE PERFORMED ON TREES TO BE PRESERVED EXCEPT BY APPROVED ARBORIST.
- 8. NO EQUIPMENT SHALL OPERATE INSIDE THE DRIP LINE (AT MINIMUM) OF TREES TO BE PRESERVED.
- 9. HAND WORK ONLY AND NO MACHINERY OR MATERIAL STORAGE WITHIN DRIP LINE OF TREES TO BE PRESERVED.
- 10. EXISTING TREES TO REMAIN SHALL BE FERTILIZED AND PRUNED TO REMOVE DEAD WOOD, DAMAGED, AND/OR RUBBING BRANCHES.
- 11. CONTRACTOR SHALL COORDINATE THE PHASES OF CONSTRUCTION AND PLANTING INSTALLATION WITH OTHER CONTRACTORS WORKING ON THE SITE.
- 12. CONTRACTOR TO COMPLETE SOIL PREPARATION PER SPECIFICATIONS.
- 13. CONTRACTOR TO SUPPLY AND INSTALL SOD, TREES, SHRUBS, PERENNIALS, GRASSES, PLUGS, AND GROUNDCOVERS.
- 14. PROPOSED PLANT MATERIAL SHALL COMPLY WITH THE LATEST EDITION OF THE AMERICAN STANDARD FOR NURSERY STOCK, ANSI Z60.1 UNLESS NOTED OTHERWISE. DECIDUOUS SHRUBS SHALL HAVE AT LEAST 5 CANES AT THE SPECIFIED HEIGHT. ORNAMENTAL TREES SHALL HAVE NO "V" CROTCHES AND SHALL BEGIN BRANCHING NO LOWER THAN 3 FEET ABOVE ROOT BALL. SHADE TREES SHALL BEGIN BRANCHING NO LOWER THAN 6' ABOVE FINISHED GRADE.
- 15. ALL PLANTS AND TREES SHALL BE PLANTED PER DETAILS AND SPECS.
- 16. ALL TREES, AS IDENTIFIED ON THE PLANS. SHALL BE STAKED AS SHOWN ON THE PLANTING DETAILS UNLESS NOTED OTHERWISE ON THE PLANS.
- 17. NO PLANTS SHALL BE INSTALLED UNTIL FINAL GRADES AND CONSTRUCTION HAS BEEN COMPLETED IN THE IMMEDIATE AREA.
- 18. WHEN QUANTITIES ARE LISTED THEY ARE FOR THE CONTRACTOR'S CONVENIENCE ONLY. ALL COUNTS MUST BE VERIFIED BY THE CONTRACTOR. IN THE CASE OF A DISCREPANCY BETWEEN THE LEGEND AND THE PLAN, PLANTS INDICATED ON THE PLAN SHALL SUPERCEDE QUANTITIES LISTED IN THE LEGEND. SPECIFICATIONS AND DETAILS TAKE PRECEDENCE OVER NOTES.
- 19. NO PLANT MATERIAL SUBSTITUTIONS WILL BE ACCEPTED UNLESS APPROVAL IS REQUESTED OF THE LANDSCAPE ARCHITECT BY THE LANDSCAPE CONTRACTOR PRIOR TO THE SUBMISSION OF BID AND/OR QUOTATION.
- 20. ADJUSTMENTS IN LOCATION OF PROPOSED PLANT MATERIAL MAY BE NEEDED IN FIELD. PRIME CONSULTANT MUST BE NOTIFIED PRIOR TO THE ADJUSTMENT OF PLANTS.
- 21. CONTRACTOR SHALL VERIFY PLANT QUANTITIES SHOWN ON THE PLAN AND PROVIDE A LIST TO THE CLIENT IDENTIFYING THE SPECIES AND SIZES TO BE USED THROUGHOUT THE PROJECT. THE LANDSCAPE ARCHITECT AND THE OWNER'S REPRESENTATIVE RESERVES THE RIGHT TO REJECT ANY SUBSTANDARD PLANT MATERIAL. REJECTED MATERIAL SHALL BE REMOVED FROM THE PROJECT SITE IMMEDIATELY.

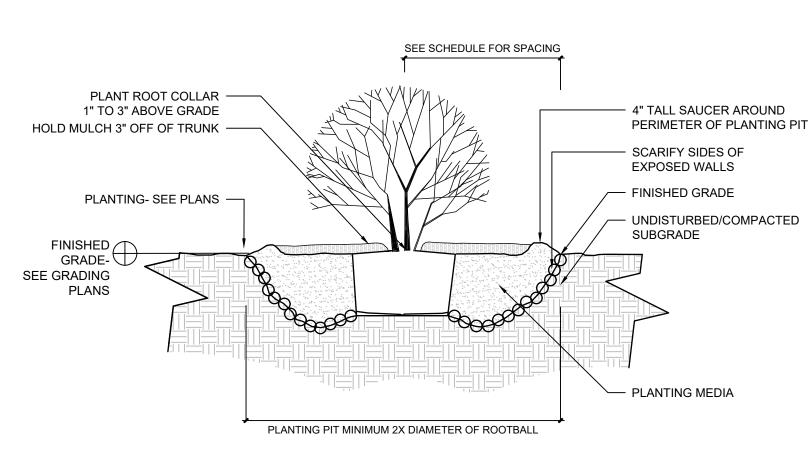


GENERAL NOTES:

- PLANTING SPECIFICATIONS SHALL REFER TO ANY SOIL
- AMENDMENTS REQUIRED PLANTS ARE TO THOROUGHLY WATERED AFTER TRANSPLANTING
- IS COMPLETED- SEE SPECIFICATION FOR FULL WATERING NOTES
- REMOVE BURLAP, WIRE CAGE, AND PLASTIC CONTAINERS (SEE ROOTBALL PREPARATION DETAIL)
- 4. THIS TREE PLANTING DETAIL MEETS THE REQUIREMENTS OUTLINED IN THE WISCONSIN DNR "Developing Planting Specifications'

SHRUB PLANTING

NOT TO SCALE

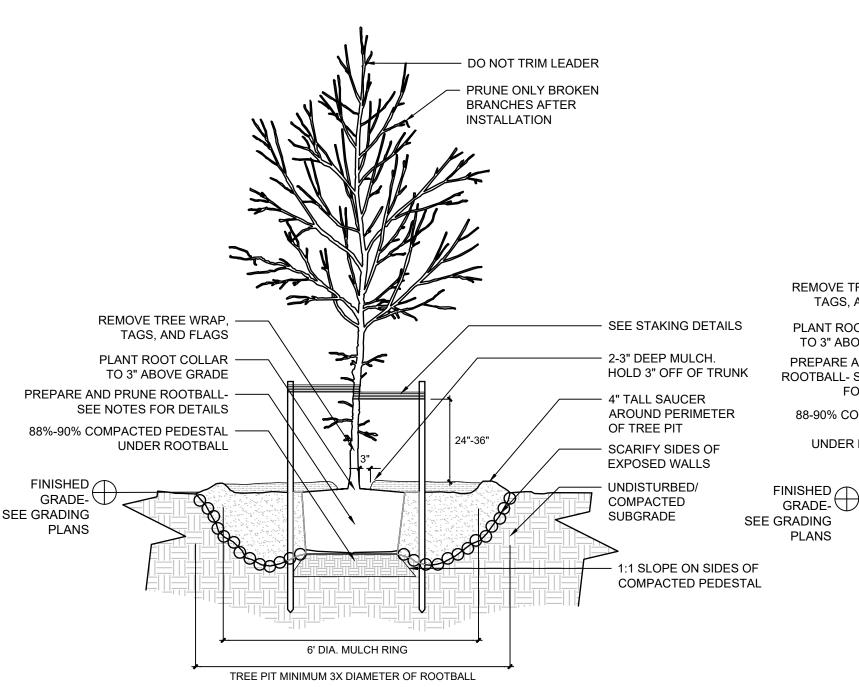

NOT TO SCALE

- PLANTING SPECIFICATIONS SHALL REFER TO ANY SOIL AMENDMENTS REQUIRED
- 2. USE TYPICAL TREE STAKING DETAIL UNLESS DESIGNATED AS "TREE INSTALLATION AND PROTECTION STAKING" ON PLANS 3. PLANTS ARE TO THOROUGHLY WATERED AFTER TRANSPLANTING IS COMPLETED-

DECIDUOUS TREE PLANTING

- SEE SPECIFICATION FOR FULL WATERING NOTES
- 4. REMOVE BURLAP, WIRE CAGE, AND PLASTIC CONTAINERS (SEE ROOTBALL
- PREPARATION DETAIL)
- 5. THIS TREE PLANTING DETAIL MEETS THE REQUIREMENTS OUTLINED IN THE
- WISCONSIN DNR "Developing Planting Specifications' (2006) 6. USE EXISTING SOIL REMOVED FROM HOLE AS BACK FILL. USE 2/3 PARTS EXISTING
- SOIL AND 1/3 IMPORTED TOPSOIL. FERTILIZE WITH A 20-10-5 TREE PLANTING TABLET PER THE MANUFACTURER'S RECOMMENDED RATES. DO NOT PLACE TABLETS IN THE BOTTOM OF THE HOLE

NOT TO SCALE

EQUIDISTANT ↑FINISHED CUT TOP OF POLES TO フGRADE-ALIGN. SET TOP OF SEE GRADING POLES 5' MAX. ABOVE PLANS FINISHED GRADE PLANTING MEDIA. SEE SPEC. - UNDISTURBED/ COMPACTED SUBGRADE **SECTION VIEW** PLANTS TO BE SPACED TRIANGULARLY UNLESS OTHERWISE NOTED BY PLANS PLANT CROWNS MUST MAINTAIN 6" CLEARANCE FROM ANY HARDSCAPE EDGE PLANTS NEXT TO HARDSCAPE TO BE PLANTED AT DISTANCE SHOWN ON SCHEDULE

PLAN VIEW

- **GENERAL NOTES:** 1. IF PLUGS ARE TO BE INSTALLED IN EROSION MATTING- CUT MATTING PRIOR TO PLANTING. SEEDING TO OCCUR PRIOR TO INSTALLING
- **EROSION MATTING** 2. SEE PLANTING SCHEDULE FOR GROUNDCOVER SPECIES AND
- SPACING
- 3. SETTLE SOIL AROUND ROOT BALL AROUND EACH SPECIMEN BY THOROUGHLY WATERING

PLUG PLANTING

NOT TO SCALE

CROWN/ ROOT FLARE

TO FINISHED ELEV.

ROOTBALL BEFORE


OF PLANT TO BE EQUAL

LOOSEN OUTER 25% OF

PLANTING CONTAINER

PLANTS. REMOVE ANY


ENCIRCLING ROOTS.

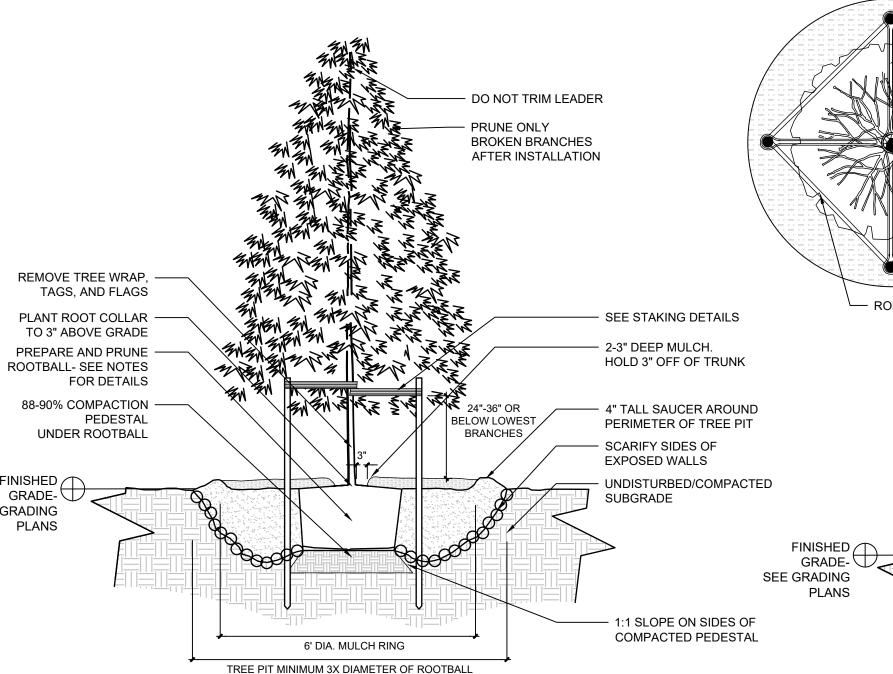

- PLANTING SPECIFICATIONS SHALL REFER TO ANY SOIL AMENDMENTS REQUIRED 2. USE TYPICAL TREE STAKING DETAIL UNLESS DESIGNATED AS "TREE INSTALLATION
- AND PROTECTION STAKING" ON PLANS 3. PLANTS ARE TO THOROUGHLY WATERED AFTER TRANSPLANTING IS COMPLETED-
- SEE SPECIFICATION FOR FULL WATERING NOTES
- 4. REMOVE BURLAP, WIRE CAGE, AND PLASTIC CONTAINERS (SEE ROOTBALL
- PREPARATION DETAIL)
- 5. THIS TREE PLANTING DETAIL MEETS THE REQUIREMENTS OUTLINED IN THE
- WISCONSIN DNR "Developing Planting Specifications' (2006) 6. USE EXISTING SOIL REMOVED FROM HOLE AS BACK FILL. USE 2/3 PARTS EXISTING SOIL AND 1/3 IMPORTED TOPSOIL. FERTILIZE WITH A 20-10-5 TREE PLANTING TABLET PER THE MANUFACTURER'S RECOMMENDED RATES. DO NOT PLACE TABLETS IN THE

CONIFEROUS TREE PLANTING

BOTTOM OF THE HOLE

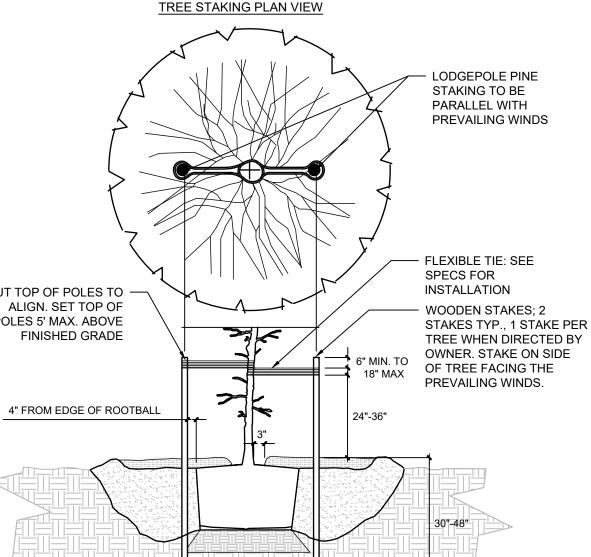


GENERAL NOTES:

- 1. REFER TO TREE PLANTING DETAILS FOR TRANSPLANTING AND PREPARATION
- 2. USE TYPICAL TREE STAKING DETAIL UNLESS DESIGNATED AS "TREE INSTALLATION
- AND PROTECTION STAKING" ON PLANS STAKES SHALL BE LEVEL WITH ANOTHER
- SEE SPECIFICATION FOR STAKING REMOVAL INFORMATION
- DO NOT OVERLY TIGHTEN TIES
- 6. THIS TREE PLANTING DETAIL MEETS THE REQUIREMENTS OUTLINED IN THE WISCONSIN DNR "Developing Planting Specifications' (2006)
- 7. LODGEPOLES TO BE DRIVEN TO DEPTH SUFFICIENT TO WITHSTAND MODERATE FORCE BY AN ADULT PUSHING ON ANY SIDE WITHOUT DEFLECTING MORE THAN 4"

TYPICAL TREE STAKING

NOT TO SCALE

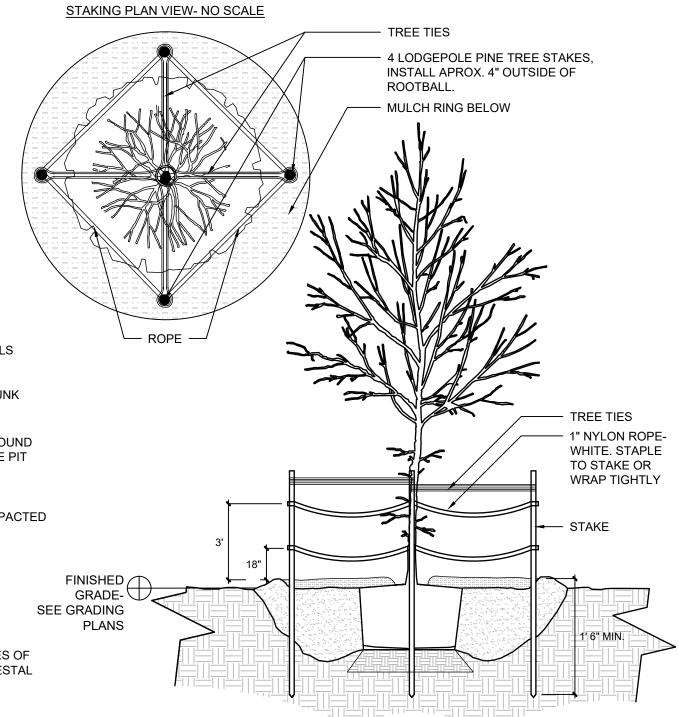

- 1. REFER TO TREE PLANTING DETAILS FOR TRANSPLANTING AND PREPARATION **PROCEDURES**
- 2. USE TYPICAL TREE STAKING DETAIL UNLESS DESIGNATED AS "TREE
- INSTALLATION AND PROTECTION STAKING" ON PLANS 3. STAKES SHALL BE LEVEL WITH ANOTHER
- 4. SEE SPECIFICATION FOR STAKING REMOVAL INFORMATION
- 5. DO NOT OVERLY TIGHTEN NYLON ROPE, 1-4" OF SLACK IS PREFERRED
- 6. THIS TREE PLANTING DETAIL MEETS THE REQUIREMENTS OUTLINED IN THE WISCONSIN DNR "Developing Planting Specifications' (2006) 7. LODGEPOLES TO BE DRIVEN TO DEPTH SUFFICIENT TO WITHSTAND
- MODERATE FORCE BY AN ADULT PUSHING ON ANY SIDE WITHOUT DEFLECTING MORE THAN 4"



DRAWING NUMBER

MPS PROJECT NUMBER

PROJECT NUMBER

2024 GREEN

UPGRADES

SCHOOL

Owner:

FOREST HOME AVENUE

INFRASTRUCTURE

MILWAUKEE

PUBLIC SCHOOLS

SMITHGROUP

233 NORTH WATER STREET

HELIANTHUS

1836 W. Fond Du Lac Ave.

REV DATE

01/25/2024

Milwaukee, WI 53205

414-622-0103

ISSUED FOR

SEALS AND SIGNATURES

SITE ADDRESS

DRAWING TITLE

SCALE

SITE # 173

1516 W FOREST HOME AVENUE

MILWAUKEE, WI 53204

PLANTING NOTES

& DETAILS

100% CD

MILWAUKEE, WI 53202


www.smithgroup.com

SUITE 502


414.615.9570

8317, DIVISION 1

- REMOVE STRUCTURAL ROOTS OUTSIDE OF BURLAP. ROOTS LESS THAN $\frac{1}{4}$ " IN DIAMETER MAY REMAIN

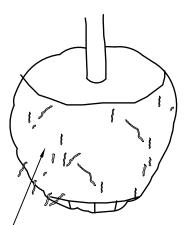

PEEL BACK BURLAP AND FULLY REMOVE OFF SIDES. **CUT WIRE CAGE** AND REMOVE OFF

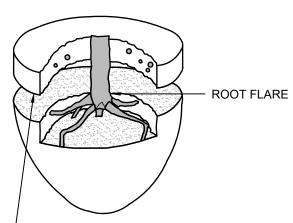

- GENTLY REMOVE SOIL OFF OF ROOTBALL SO THAT THE TOP OF THE ROOT FLARE IS EXPOSED.


GENERAL NOTES

ALL PLANTS MUST HAVE BURLAP AND WIRE CAGE REMOVED FROM THE SIDES OF THE ROOTBALL. 2. FOR CONTAINER PLANTS, PLASTIC CONTAINERS MUST BE FULLY REMOVED.


<u>DNR NOTES:</u> THIS PLANTING DETAIL CONFORMS TO TREE PLANTING GUIDELINES AS SPECIFIED IN DNR DOCUMENT 'DEVELOPING PLANTING SPECIFICATIONS' REVISED 10.25.

ROOT BALL PREPARATION


NOT TO SCALE

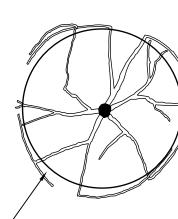

SHAVE ROOT BALL HERE TO REMOVE ALL ROOTS **GROWING ON PERIPHERY**

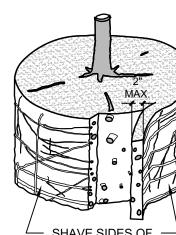

SHAVE SIDES OF ROOTBALL $\frac{1}{2}$ " - 1".

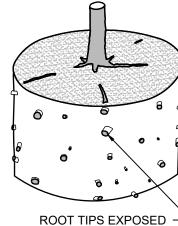

ON SIDES OF ROOT BALL. ALL ROOTS **GROWING AROUND** SIDES TO BE REMOVED

- FINISHED GRADE TO

PAVEMENT.

BE AT GRADE WITH ADJACENT

IS TO BE 3" BELOW ADJACENT

MULCHING, THEN FINISHED GRADE

PAVEMENT IF NO FURTHER


TREATMENT REQUIRED. IF


- 1- SHAVING TO BE CONDUCTED USING A CLEAN, SHARP BLADE OR HANDSAW.
- 2- BLADE MUST BE CLEANED AND STERILIZED BETWEEN ROOT SHAVINGS/ 3- ROOT PRUNING ONLY TO OCCUR AT NURSERY OR IMMEDIATELY PRIOR TO TRANSPLANTING TO FINAL
- LOCATION.
- 4- ONLY SHAVE 15 GAL. CONTAINER PLANTS AND LARGER, INCLUDING BALLED AND BURLAPPED PLANTS. 5- FOR PLANT POTS UNDER 15 GAL., AGITATE ROOTS PRIOR TO PLANTING

DNR NOTES: THIS PLANTING DETAIL CONFORMS TO TREE PLANTING GUIDELINES AS SPECIFIED IN DNR DOCUMENT 'DEVELOPING PLANTING SPECIFICATIONS' REVISED 10.25.

ROOT BALL PRUNING

NOT TO SCALE

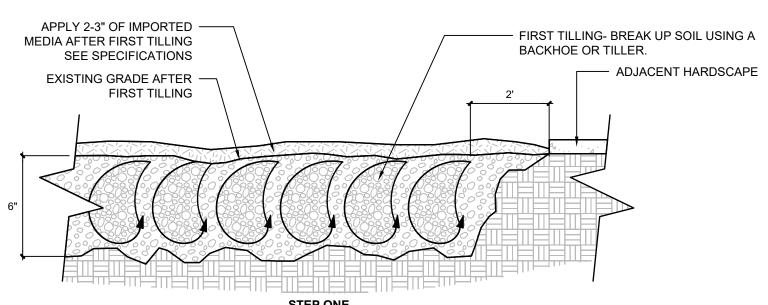

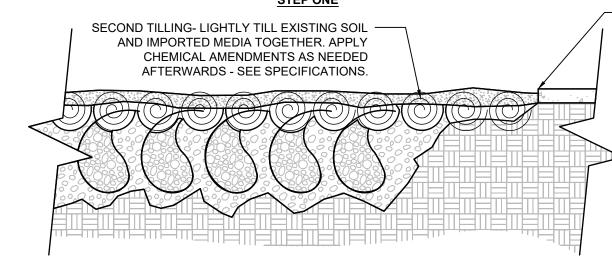


1. IF SOILS ARE AMENDED MORE THAN 1 WEEK PRIOR TO TRANSPLANTING OR

- MULCHING THEN COVER SURFACE WITH FABRIC OR MATTING
- 2. SEE SPECIFICATIONS FOR INFORMATION ON CHEMICAL AMENDMENT AND IMPORTED
- 3. AREAS OF CHEMICAL AMENDMENT AND IMPORTED MEDIA SHOULD BE INDICATED ON
- 4. ALL PLANTS ARE TO BE INSTALLED AFTER SOIL AMENDMENTS

SOIL AMENDMENT

NOT TO SCALE

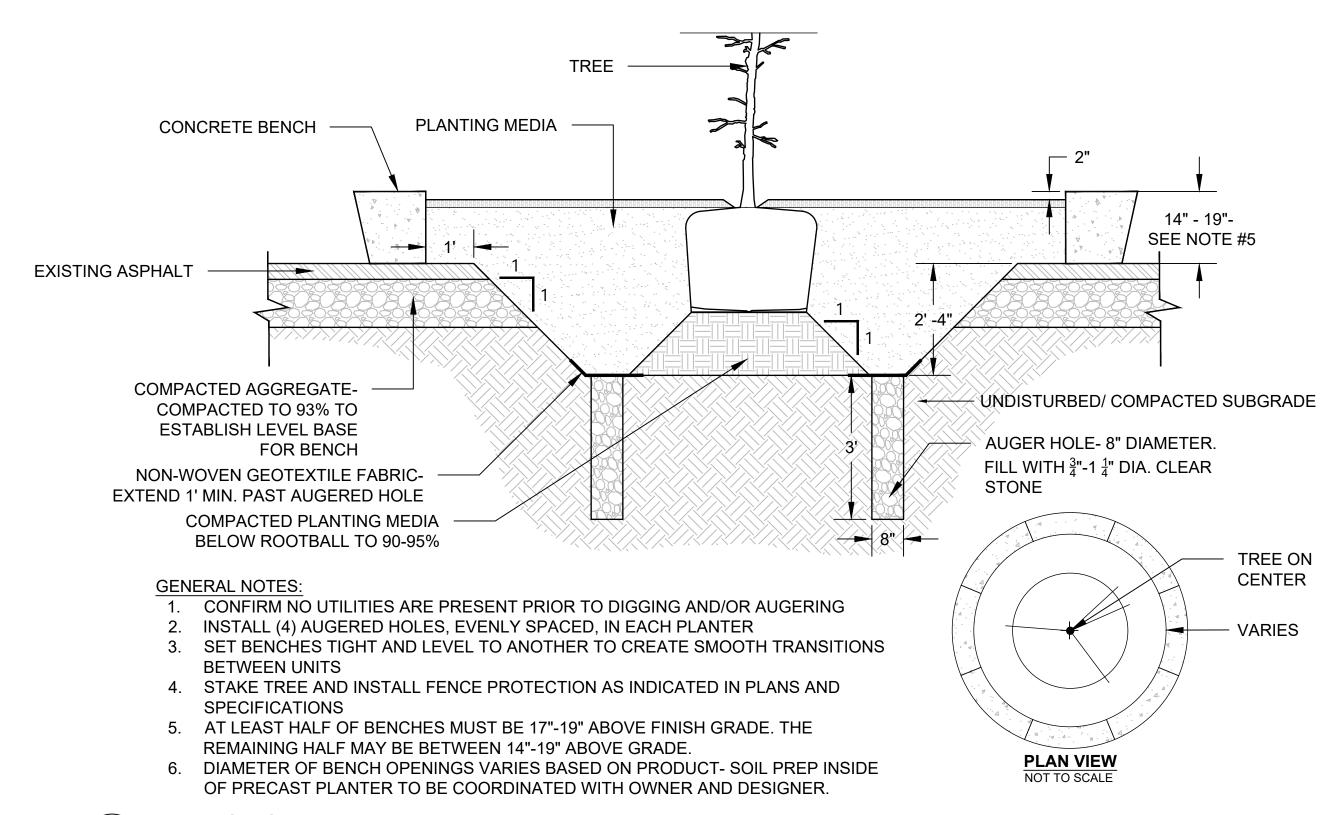

TREE CIRCLE PLANTER

NOT TO SCALE

2024 GREEN INFRASTRUCTURE UPGRADES

FOREST HOME AVENUE SCHOOL

Owner:



SMITHGROUP

233 NORTH WATER STREET SUITE 502 MILWAUKEE, WI 53202 414.615.9570 www.smithgroup.com



1836 W. Fond Du Lac Ave. Milwaukee, WI 53205 414-622-0103

ISSUED FOR	REV	DATE
100% CD		01/25/2024
SEALS AND SIGNATURES		

SITE ADDRESS

SITE # 173 1516 W FOREST HOME AVENUE MILWAUKEE, WI 53204

DRAWING TITLE

DRAWING NUMBER

PLANTING DETAILS

SCALE	
	14895
PROJECT NUMBER	
	8317, DIVISION
MPS PROJECT NUMBER	
	L50′

PLANT SCHEDULE

SYMBOL	CODE	BOTANICAL / COMMON NAME	CONT	PLANTING SIZE	MATURE HT	MATURE SP	QTY
TREES							
+	ACE FRE	Acer x freemanii `Jeffsred` / Autumn Blaze Maple	5 gal	Container	50`	40`	9
	ACE JEF	Acer x freemanii `Jeffsred` / Autumn Blaze Maple	B & B	2.5" Min. Cal.	50`	40`	16
	AME LAV	Amelanchier laevis / Allegheny Serviceberry	5 gal	Container	25`	15`	6
	CAR CAR	Carpinus caroliniana / American Hornbeam	5 gal	Container	30,	30'	8
+	CAR OVT	Carya ovata / Shagbark Hickory	5 gal	Container	80,	60`	8
+	CEL OCD	Celtis occidentalis / Common Hackberry	5 gal	Container	60,	60`	11
£ + 3	GLE SHA	Gleditsia triacanthos inermis 'Shademaster' / Shademaster Honey Locust	B & B	2.5" Min. Cal.	60,	50`	6
£ 0 3	OST VIA	Ostrya virginiana / American Hophornbeam	5 gal	Container	25`	15`	8
+ + +	QUE BIR	Quercus bicolor / Swamp White Oak	5 gal	Container	75`	65`	9
	QUE BIC	Quercus bicolor / Swamp White Oak	B & B	2.5" Min. Cal.	75`	65`	7
	QUE RUB	Quercus rubra / Red Oak	B & B	2.5" Min. Cal.	75`	75`	5
	QUE SCH	Quercus x schuetti / Swamp Bur Oak	B & B	2.5" Min. Cal.	75`	70`	4
•	ULM PTM	Ulmus x 'Morton Glossy' / Triumph™ Elm	B & B	2.5" Min. Cal.	60,	45`	3
SHRUBS							
Exercise S	COR FAR	Cornus sericea 'Farrow' / Arctic Fire® Red Twig Dogwood	3 gal	Container	4`	4`	10
\bigcirc	DIE LON	Diervilla Ionicera / Dwarf Bush Honeysuckle	3 gal	Container	4`	5`	7
+	JUN OWL	Juniperus virginiana `Grey Owl` / Eastern Redcedar	3 gal	Container	3`	6`	3

BIOSWALE GREEN MULCH SEED MIX

* * * * * *

		PLS
Botanical Name	Common Name	Ounces/Acre
Cover Crop:		
Regreen	Regreen Winter Wheat	160
Grasses & Sedges:		
Carex brevior	Plains Oval Sedge	6
Carex bromoides	Brome Hummock Sedge	8
Carex vulpinoidea	Brown Fox Sedge	16
Penstemon digitalis	Foxglove Beardtongue	2
Rudbeckia hirta	Black-eyed Susan	3
Sporobolus heterolepis	Prairie Dropseed	36
	Total	231
	LBS	14.44

2024 GREEN INFRASTRUCTURE UPGRADES

FOREST HOME AVENUE SCHOOL

Owner:



SMITHGROUP

233 NORTH WATER STREET SUITE 502 MILWAUKEE, WI 53202 414.615.9570 www.smithgroup.com



1836 W. Fond Du Lac Ave. Milwaukee, WI 53205 414-622-0103

ISSUED FOR	REV	DATE
100% CD		01/25/2024
		-

SITE ADDRESS

SEALS AND SIGNATURES

SITE # 173 1516 W FOREST HOME AVENUE MILWAUKEE, WI 53204

DRAWING TITLE

DRAWING NUMBER

PLANTING SCHEDULE

	L502
IPS PROJECT NUMBER	
ROJECT NUMBER	8317, DIVISION 1
CALE	14895

PLANT SCHEDULE

PERENNIA	ALS & GR	ASSES						
$\langle \circ \rangle$	ALL CER	Allium cernuum / Nodding Wild Onion	PLUG	32-CELL FLAT OR EQUIVALENT	1`	1`		31
Land A	SPO HET	Sporobolus heterolepis / Prairie Dropseed	PLUG	32-CELL FLAT OR EQUIVALENT	3,	2`		20
VINES								
	PAR QUI	Parthenocissus quinquefolia / Virgina Creeper	1 gal	Pot				5
SYMBOL	CODE	BOTANICAL / COMMON NAME	CONT	PLANTING SIZE	MATURE HT	MATURE SP	SPACING	QTY
PERENNIA	AL AREAS	<u>S</u>						
		MIX 1 - BIOSWALE						455 sf
	RUD FUL TRA OHI	Rudbeckia fulgida / Coneflower Tradescantia ohiensis / Spiderwort	PLUG PLUG	32-CELL FLAT OR EQUIVALENT 32-CELL FLAT OR EQUIVALENT	3` 2`	2` 1.5`	50% @ 18" o.c. 50% @ 18" o.c.	105 105
	-	MIX 2 - BIOSWALE						310 sf
	EUP PUR PEN DIG	Eupatorium purpureum / Savannah Joe-Pye Weed Penstemon digitalis / Beard-tongue	PLUG PLUG	32-CELL FLAT OR EQUIVALENT 32-CELL FLAT OR EQUIVALENT	6` 3`	2` 1.5`	50% @ 18" o.c. 50% @ 18" o.c.	72 72
		MIX 3 - BIOSWALE						473 sf
	SYM NOV ZIZ AUR	Symphyotrichum novae-angliae / New England Aster Zizia aurea / Golden Alexander	PLUG PLUG	32-CELL FLAT OR EQUIVALENT 32-CELL FLAT OR EQUIVALENT	5` 2`	3` 2`	50% @ 18" o.c. 50% @ 18" o.c.	110 110
	-	MIX 4 - BIOSWALE						332 sf
	LIA SPI PYC VIR	Liatris spicata / Blazing Star Pycnanthemum virginianum / Mountain Mint	PLUG PLUG	32-CELL FLAT OR EQUIVALENT 32-CELL FLAT OR EQUIVALENT	3` 2`	1` 2`	50% @ 18" o.c. 50% @ 18" o.c.	76 76
		MICROFOREST - PERENNIALS						638 sf
	ALL CER ASC TUB DAL PUR ECH PUR	Allium cernuum / Nodding Wild Onion Asclepias tuberosa / Butterfly Milkweed Dalea purpurea / Purple Prairie Clover Echinacea purpurea / Coneflower	PLUG PLUG PLUG PLUG	32-CELL FLAT OR EQUIVALENT 32-CELL FLAT OR EQUIVALENT 32-CELL FLAT OR EQUIVALENT 32-CELL FLAT OR EQUIVALENT	1` 2` 2` 3`	1` 2` 1` 2`	20% @ 18" o.c. 20% @ 18" o.c. 20% @ 18" o.c. 20% @ 18" o.c.	60 60 60
V ~ ~ ~ ~	☑ GER MAC	Geranium maculatum / Spotted Geranium	PLUG	32-CELL FLAT OR EQUIVALENT	2`	2`	20% @ 18" o.c.	60

2024 GREEN INFRASTRUCTURE UPGRADES

FOREST HOME AVENUE SCHOOL



SMITHGROUP

233 NORTH WATER STREET SUITE 502 MILWAUKEE, WI 53202 414.615.9570 www.smithgroup.com



1836 W. Fond Du Lac Ave. Milwaukee, WI 53205 414-622-0103

ISSUED FOR	REV	DATE
100% CD		01/25/2024

SITE ADDRESS

SEALS AND SIGNATURES

SITE # 173 1516 W FOREST HOME AVENUE MILWAUKEE, WI 53204

DRAWING TITLE

PLANTING SCHEDULE

	148
PROJECT NUMBER	8317, DIVISIO
MPS PROJECT NUMBER	

L503

DRAWING NUMBER