2024 Green Infrastructure Upgrades STORY ELEMENTARY SCHOOL, SITE #343

3815 W Kilbourn Avenue Milwaukee, WI 53208

JANUARY 25, 2024 100% CONSTRUCTION DOCUMENTS

MPS Project Number: 8321 SmithGroup Project Number:14895

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Prepared for:



Milwaukee Public Schools 5225 W. Vliet Street Milwaukee, WI 53208 Switchboard: (414) 475-8393

Prepared by:

SMITHGROUP

MILWAUKEE, WI 53202 www.smithgroup.com



1836 W. FOND DU LAC AVE. MILWAUKEE, WI 53205 414.622.0103

DEDUCT ALTERNATES

DEDUCT ALTERNATE 1 - ADJUSTABLE BASKETBALL HOOP BASE BID INCLUDES THE REMOVAL OF AN EXISTING BASKETBALL HOOP WITH ASPHALT PATCH, NEW ADJUSTABLE BASKETBALL HOOP, AND PAINTED PLAY AS INDICATED ON THE PLANS. DEDUCT ALTERNATE INCLUDES: NO REMOVAL OF THE EXISTING BASKETBALL HOOP, NO NEW BASKETBALL HOOP, AND NO NEW PAVEMENT MARKINGS. AREA TO REMAIN AS EXISTING.

DEDUCT ALTERNATE 2 - PAVERS

BASE BID INCLUDES THE PREPARATION AND INSTALLATION OF PAVERS AND CURB AS INDICATED ON THE PLANS. DEDUCT ALTERNATE INCLUDES: NO REMOVAL OF ASPHALT, NO CURB, NO PAVERS, NO RE-GRADING UNDER EXISTING SHADE STRUCTURE. AREA TO REMAIN THE SAME. LAWN AREAS TO MATCH EXISTING GRADES.

DEDUCT ALTERNATE 3 - NATURE PLAY


BASE BID INCLUDES THE FULL INSTALLATION OF NATURE PLAY AREA AS INDICATED ON THE PLANS. DEDUCT ALTERNATE INCLUDES: INSTALLATION OF CONCRETE CURB, ENGINEERED WOOD FIBER, ADA RAMP PRODUCT, AND UNDERDRAIN ONLY. NO INSTALLATION OF NATURE PLAYGROUND PLAY FEATURES.




PROJECT VICINITY MAP





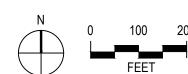

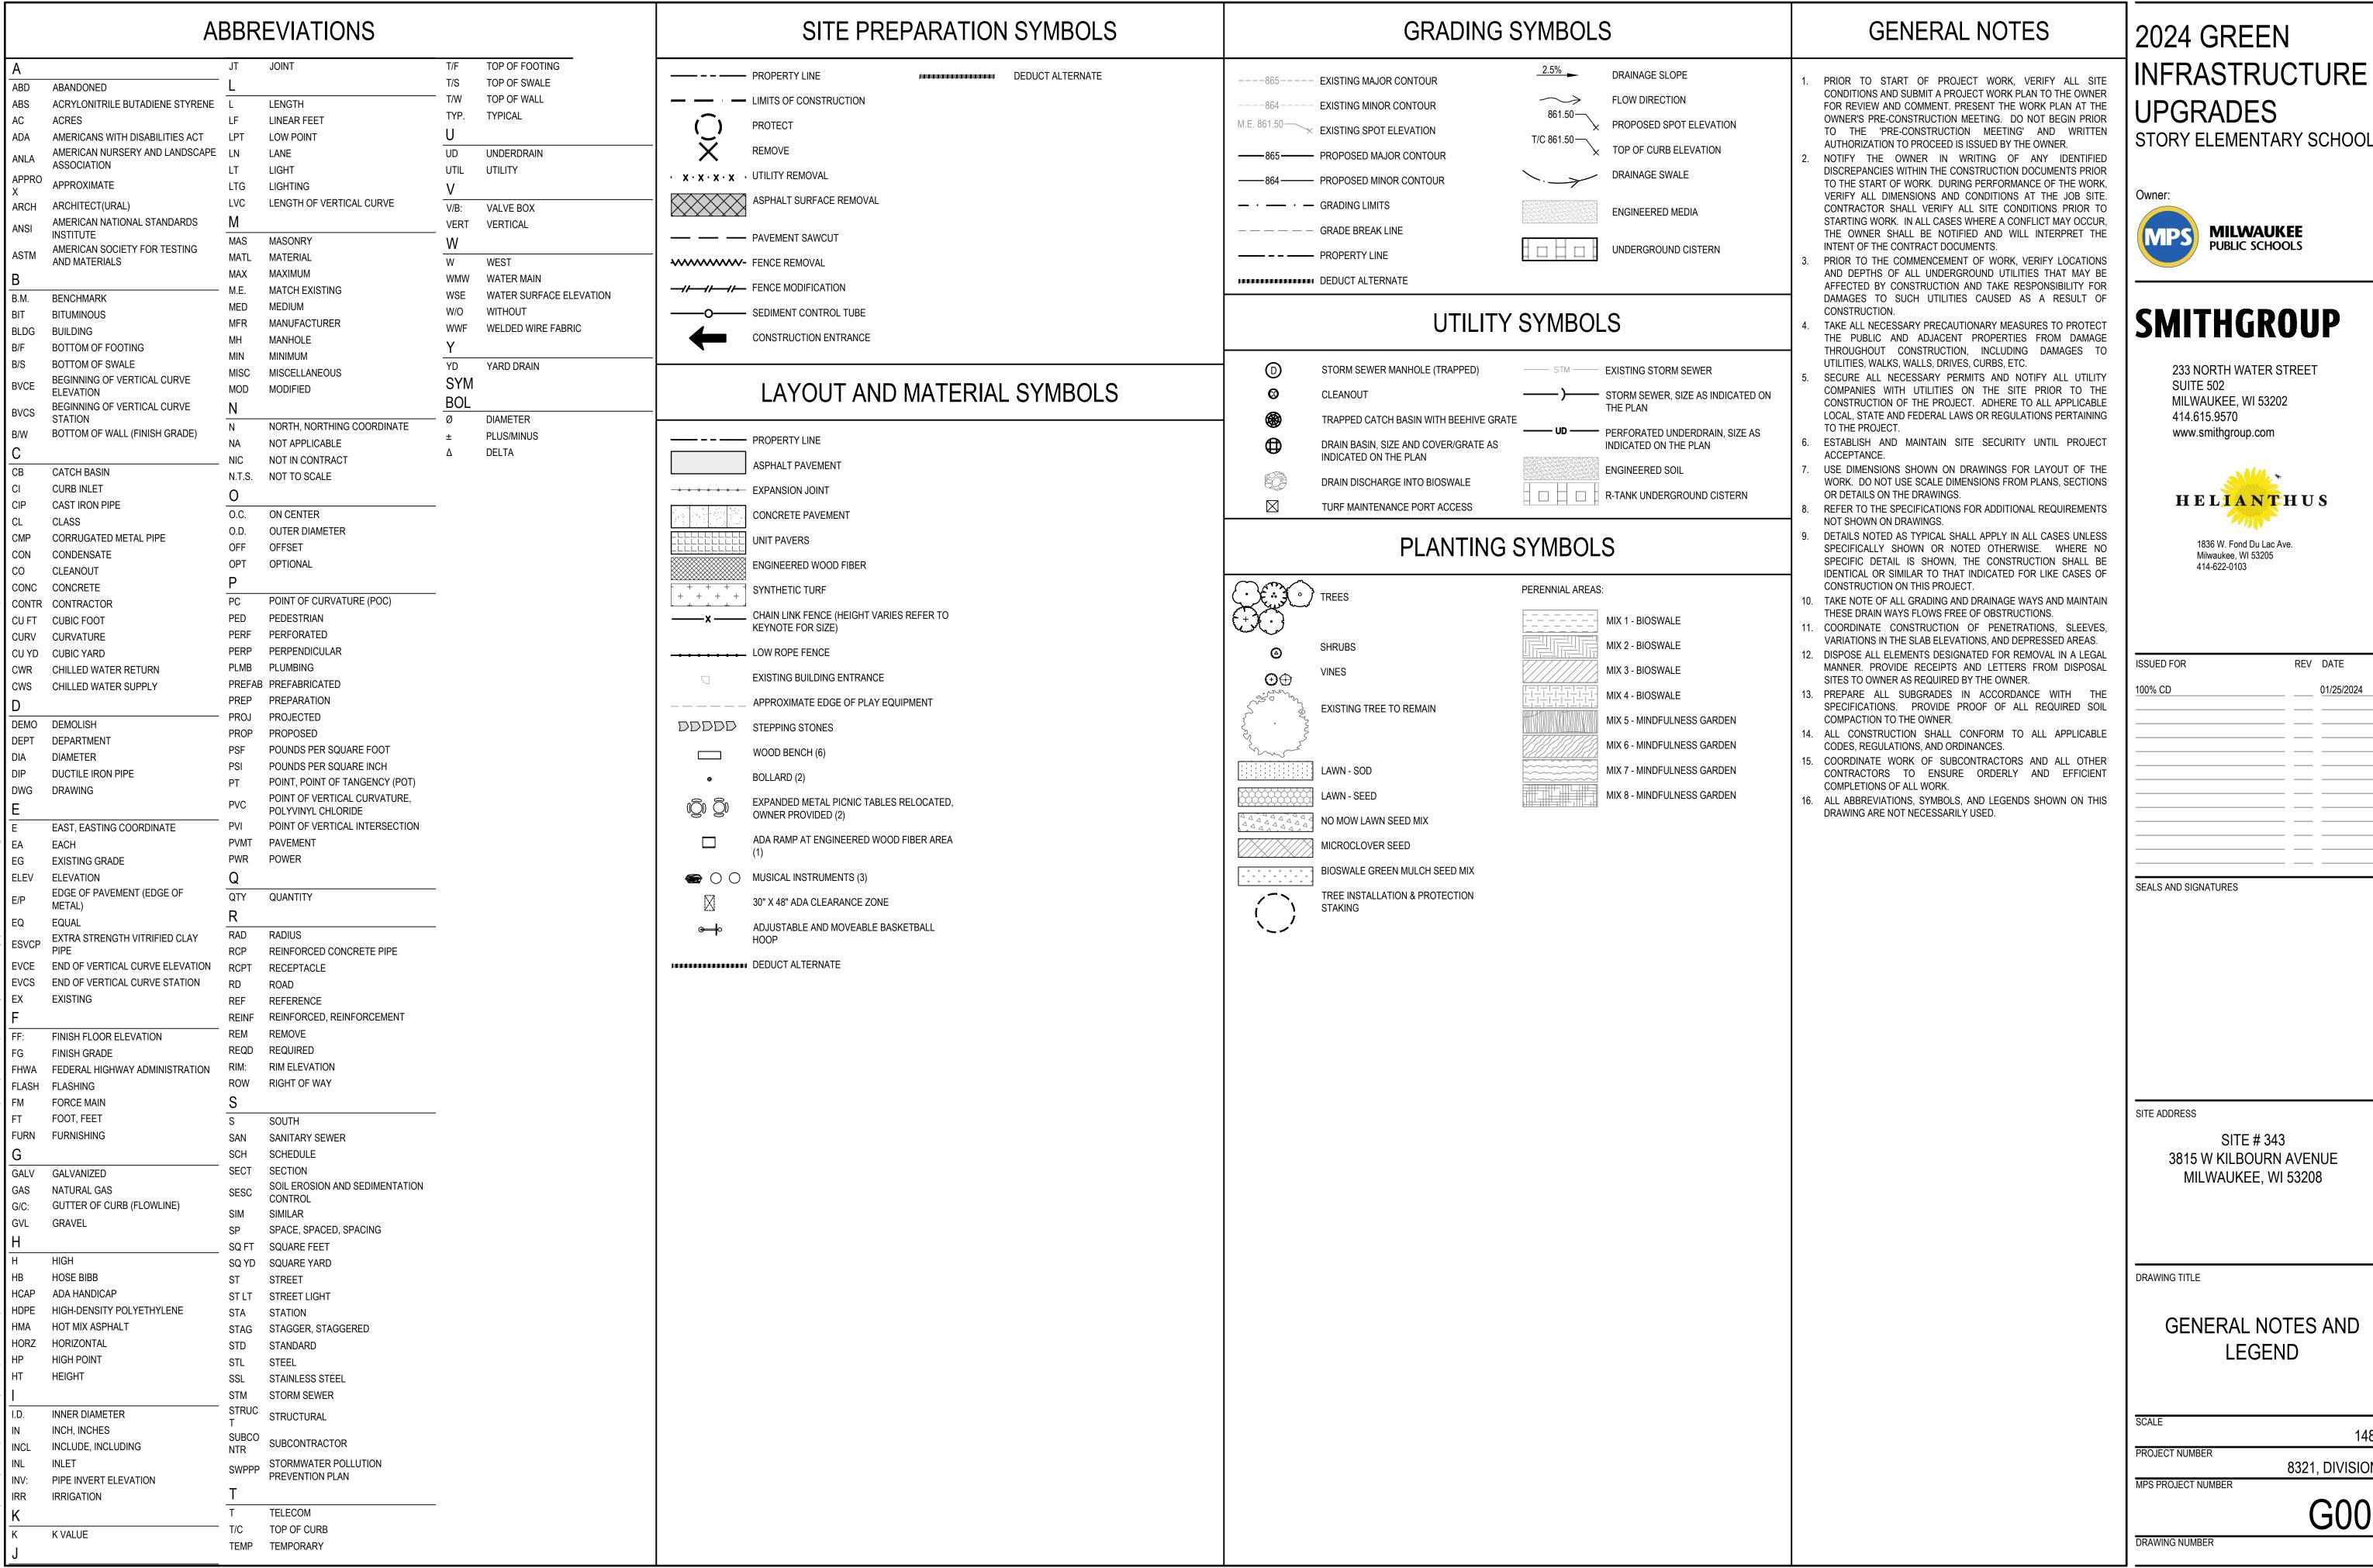

2024 GREEN INFRASTRUCTURE **UPGRADES**



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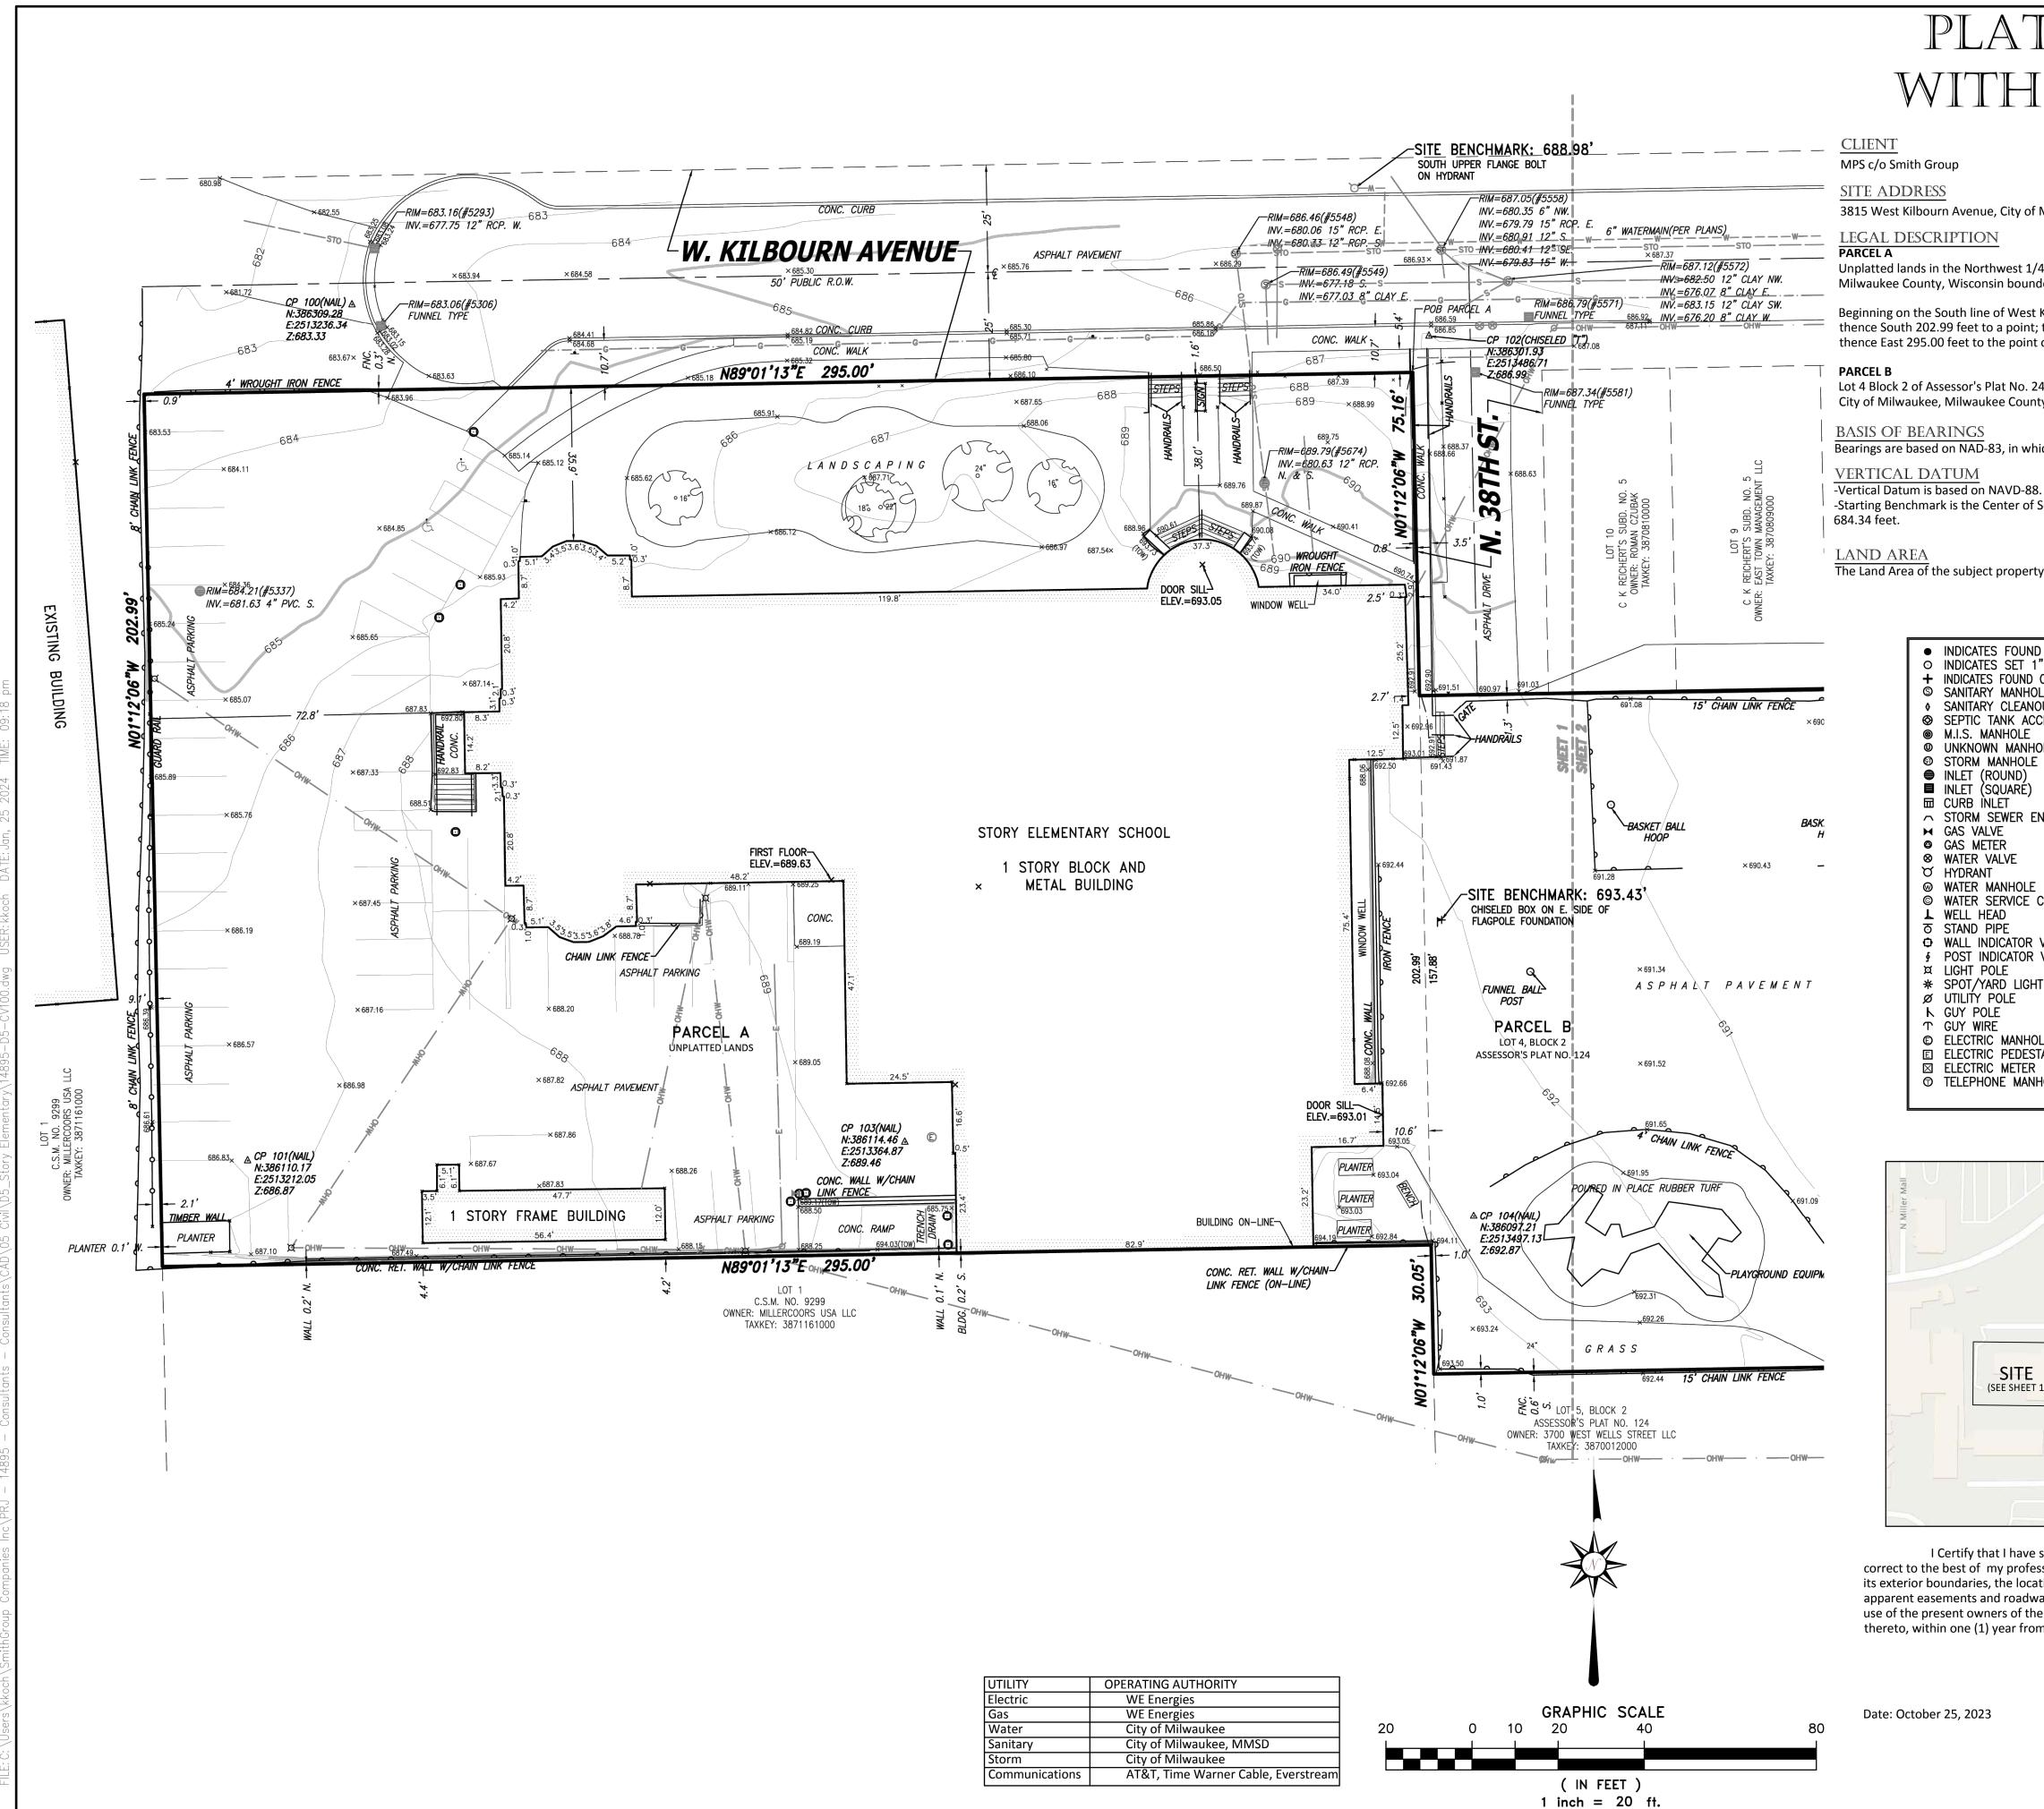
SITE ADDRESS

SITE # 343 3815 W KILBOURN AVENUE MILWAUKEE, WI 53208

DRAWING TITLE

GENERAL NOTES AND LEGEND

	14895
PROJECT NUMBER	8321, DIVISION 5
MPS PROJECT NUMBER	
	G002



PLAT OF SURVEY WITH TOPOGRAPHY

CLIENT

MPS c/o Smith Group

SITE ADDRESS

3815 West Kilbourn Avenue, City of Milwaukee, County of Milwaukee, Wisconsin

LEGAL DESCRIPTION

Unplatted lands in the Northwest 1/4 of Section 25, Township 7 North, Range 21 East, in the City of Milwaukee, Milwaukee County, Wisconsin bounded and described as follows:

Beginning on the South line of West Kilbourn Avenue and 374.74 feet West of the West line of North 37th Street; thence South 202.99 feet to a point; thence West 295.00 feet to a point; thence North 202.99 feet to a point; thence East 295.00 feet to the point of beginning.

Lot 4 Block 2 of Assessor's Plat No. 24 in the Northwest 1/4 of Section 25, Township 7 North, Range 21 East, in City of Milwaukee, Milwaukee County, Wisconsin. Excepting therefrom the East 47.00 feet for street purposes

BASIS OF BEARINGS

Bearings are based on NAD-83, in which the South line of W. Kilbourn Ave. bears North 89°01'13" East.

VERTICAL DATUM

-Starting Benchmark is the Center of Section 25, Township 7 North, Range 21 East, having an Elevation of

LAND AREA

The Land Area of the subject property is 119,027 square feet or 2.7325 acres.

LEGEND INDICATES FOUND 1" IRON PIPE □ TELEPHONE PEDESTAL O INDICATES SET 1" IRON PIPE CABLE PEDESTAL + INDICATES FOUND CHISELED CROSS □ CONTROL BOX S SANITARY MANHOLE FIBER OPTIC PEDESTAL/SIGN SANITARY CLEANOUT OR VENT ф TRAFFIC LIGHT SEPTIC TANK ACCESS COVER © COMMUNICATION MANHOLE ■ M.I.S. MANHOLE BOLLARD UNKNOWN MANHOLE + SOIL BORING/MONITORING WELL STORM MANHOLE WATER SURFÁCE ■ INLET (ROUND) WETLANDS FLAG ■ INLET (SQUARÉ) MARSH CURB INLET ► FLAGPOLE PARKING METER GAS VALVE GAS METER MAILBOX ⊗ WATER VALVE RAILROAD CROSSING SIGNAL M HYDRANT & HANDICAP SPACE * CONIFEROUS TREE © WATER SERVICE CURB STOP DECIDUOUS TREE ★ WELL HEAD ਰ STAND PIPE § POST INDICATOR VALVE ¤ LIGHT POLE * SPOT/YARD LIGHT Ø UTILITY POLE OVERHEAD WIRES k GUY POLE MARKED TELEPHONE

VICINITY MAP

FO- MARKED FIBER OPTIC

BURIED ELECTRIC SERVICE

------ BOARD FENCE

——— CHAIN LINK FENCE —×——×— WIRE FENCE

© ELECTRIC MANHOLE


ELECTRIC PEDESTAL

TELEPHONE MANHOLE



I Certify that I have surveyed the above described property (Property), and the above map is correct to the best of my professional knowledge and belief and shows the size and location of the Property, its exterior boundaries, the location and dimensions of all visible structures thereon, boundary fences, apparent easements and roadways and visible encroachments, if any. This survey is made for the exclusive use of the present owners of the Property, and also those who purchase, mortgage, or guarantee the title thereto, within one (1) year from date hereof.

Date: October 25, 2023

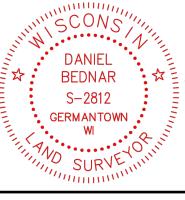

Daniel E. Bednar Professional Land Surveyor Registration Number S-2812

2024 GREEN INFRASTRUCTURE UPGRADES

STORY ELEMENTARY SCHOOL





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SEALS AND SIGNATURES		


SITE ADDRESS

SITE # 343 3815 W KILBOURN AVENUE MILWAUKEE, WI 53208

DRAWING TITLE

EXISTING CONDITIONS

8321, DIVISION 5
14895

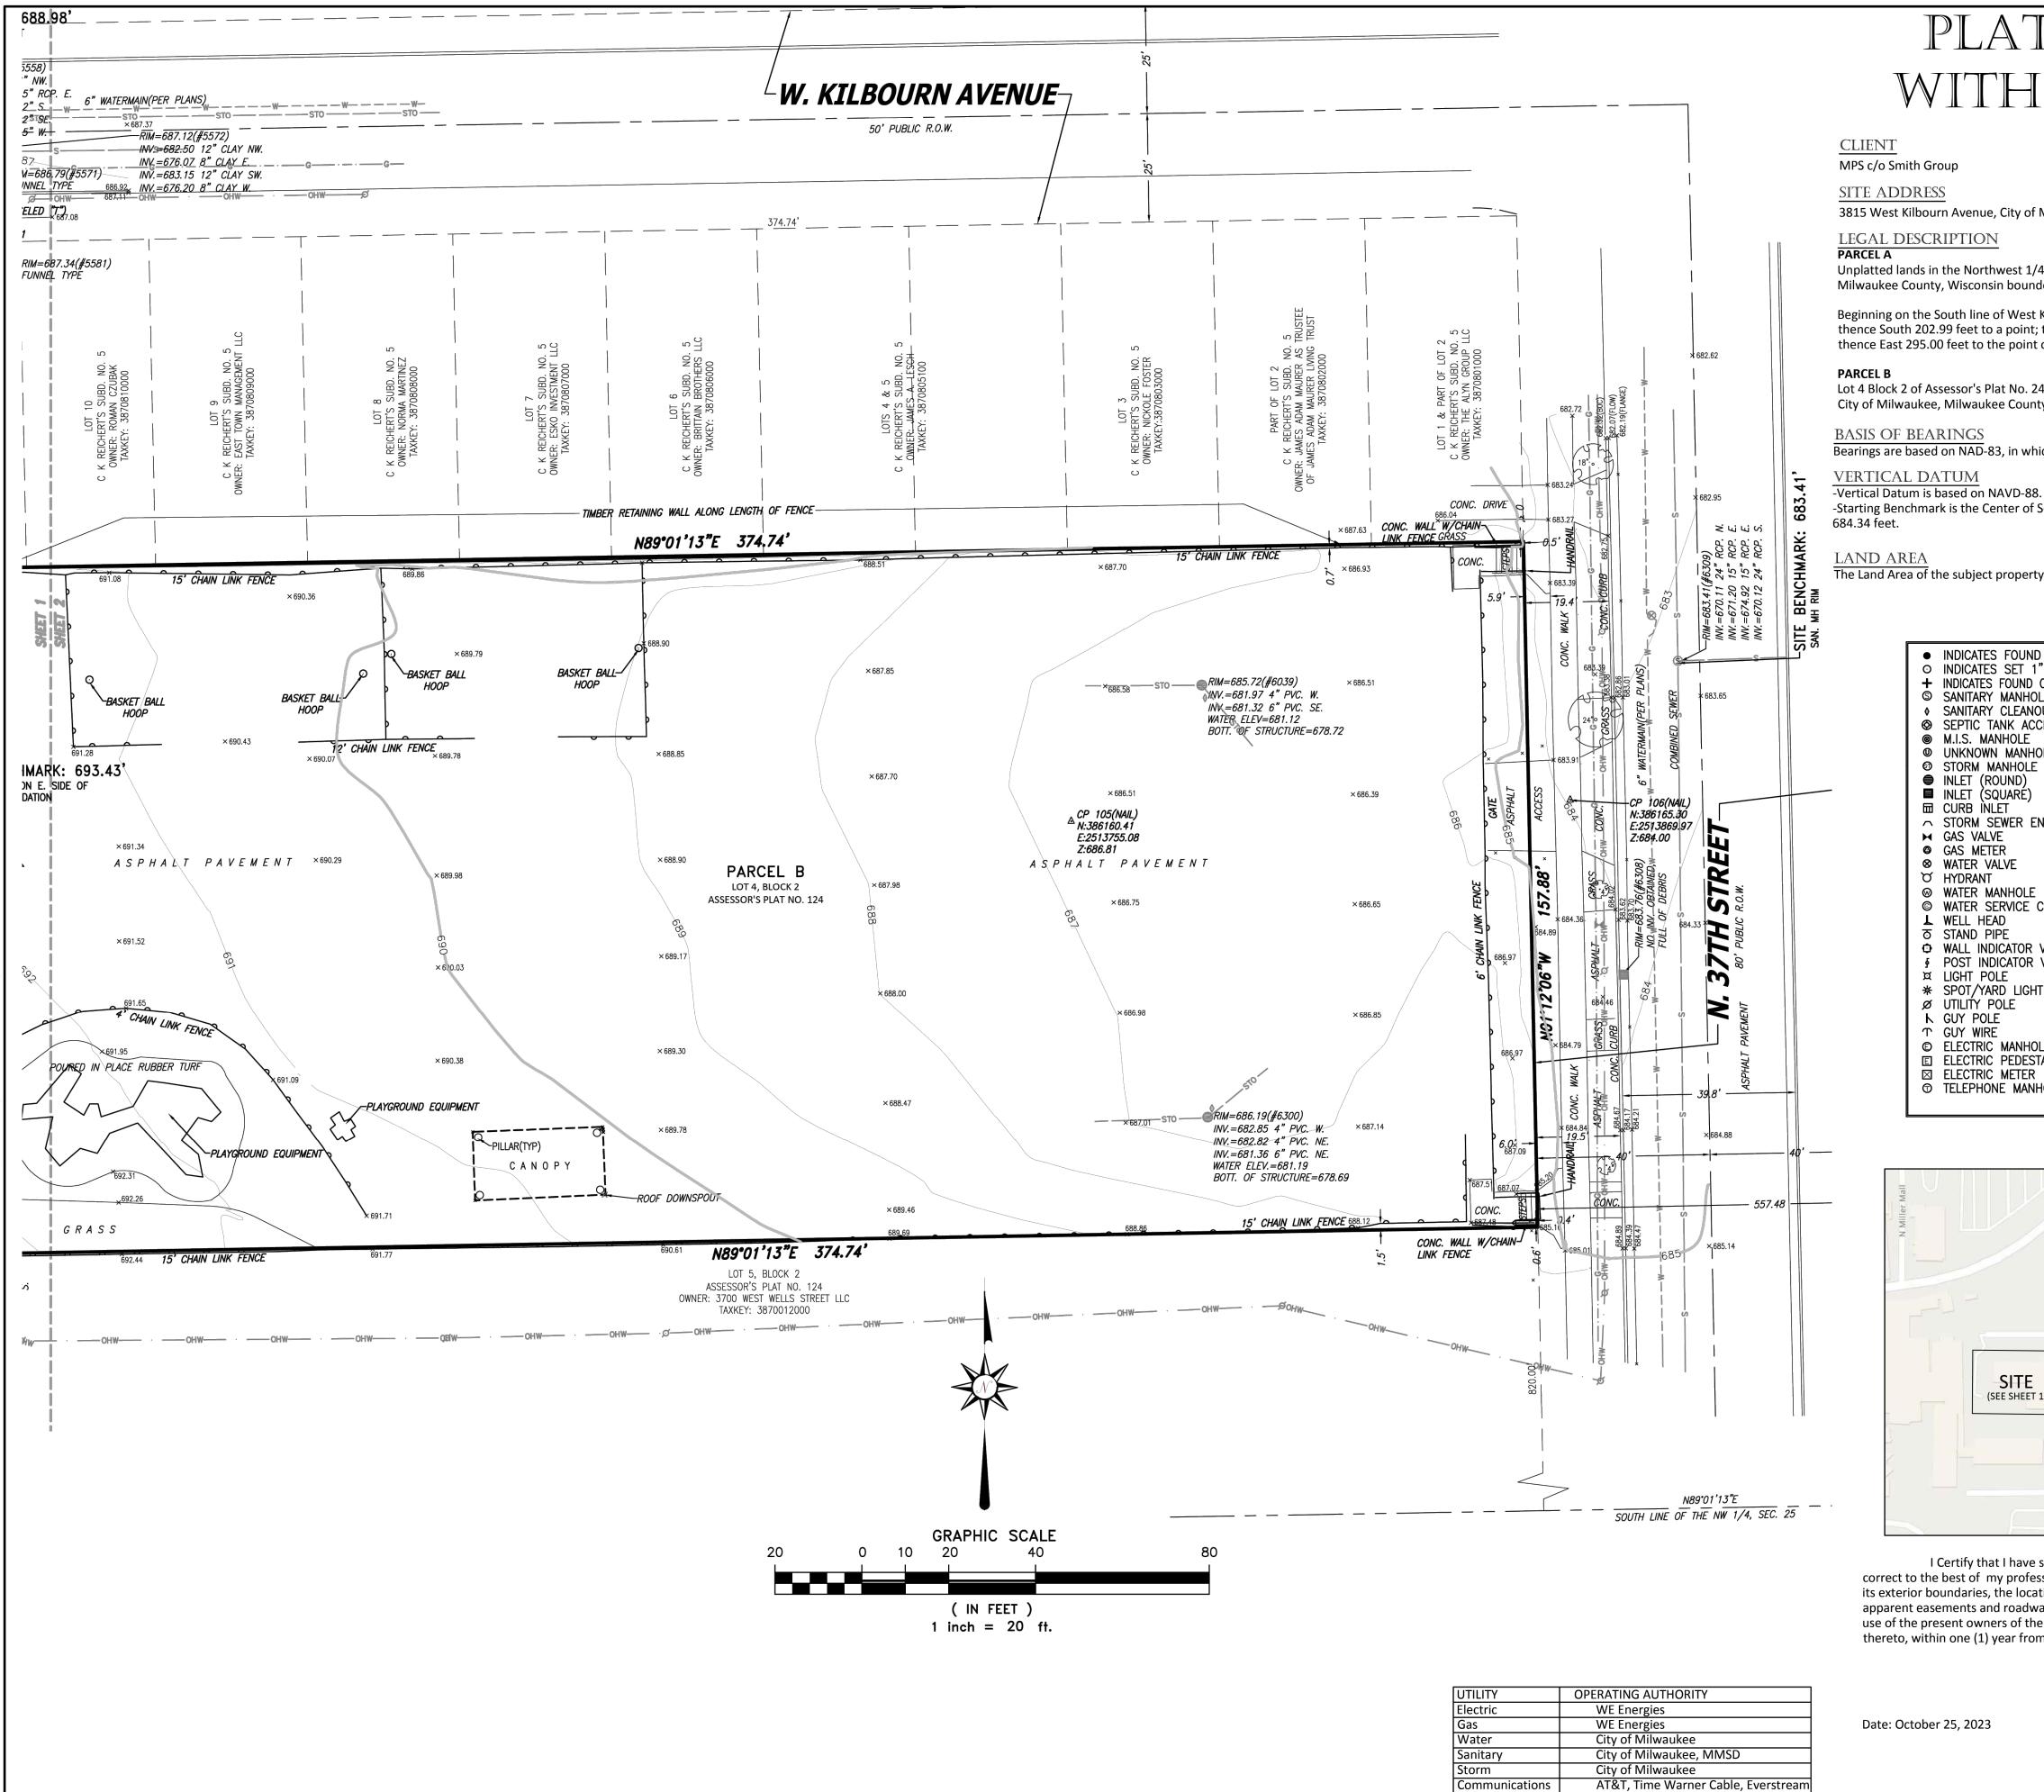

PLAT OF SURVEY WITH TOPOGRAPHY

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- CURB INLET GAS VALVE GAS METER
- ⊗ WATER VALVE M HYDRANT © WATER SERVICE CURB STOP
- ★ WELL HEAD ਰ STAND PIPE WALL INDICATOR VALVE § POST INDICATOR VALVE ¤ LIGHT POLE * SPOT/YARD LIGHT
- Ø UTILITY POLE k GUY POLE © ELECTRIC MANHOLE E ELECTRIC PEDESTAL **TELEPHONE MANHOLE**

□ TELEPHONE PEDESTAL CABLE PEDESTAL □ CONTROL BOX FIBER OPTIC PEDESTAL/SIGN ф TRAFFIC LIGHT © COMMUNICATION MANHOLE BOLLARD + SOIL BORING/MONITORING WELL ₹ WATER SURFACE WETLANDS FLAG MARSH ► FLAGPOLE PARKING METER ➡ MAILBOX * RAILROAD CROSSING SIGNAL & HANDICAP SPACE * CONIFEROUS TREE DECIDUOUS TREE

------ BOARD FENCE

···-—_____T—— MARKED TELEPHONE

FO- MARKED FIBER OPTIC

BURIED ELECTRIC SERVICE

—— CHAIN LINK FENCE

VICINITY MAP



I Certify that I have surveyed the above described property (Property), and the above map is correct to the best of my professional knowledge and belief and shows the size and location of the Property, its exterior boundaries, the location and dimensions of all visible structures thereon, boundary fences, apparent easements and roadways and visible encroachments, if any. This survey is made for the exclusive use of the present owners of the Property, and also those who purchase, mortgage, or guarantee the title thereto, within one (1) year from date hereof.

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STORY ELEMENTARY SCHOOL

Owner:



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SEALS AND SIGNATURES		

SITE ADDRESS


SITE # 343 3815 W KILBOURN AVENUE MILWAUKEE, WI 53208


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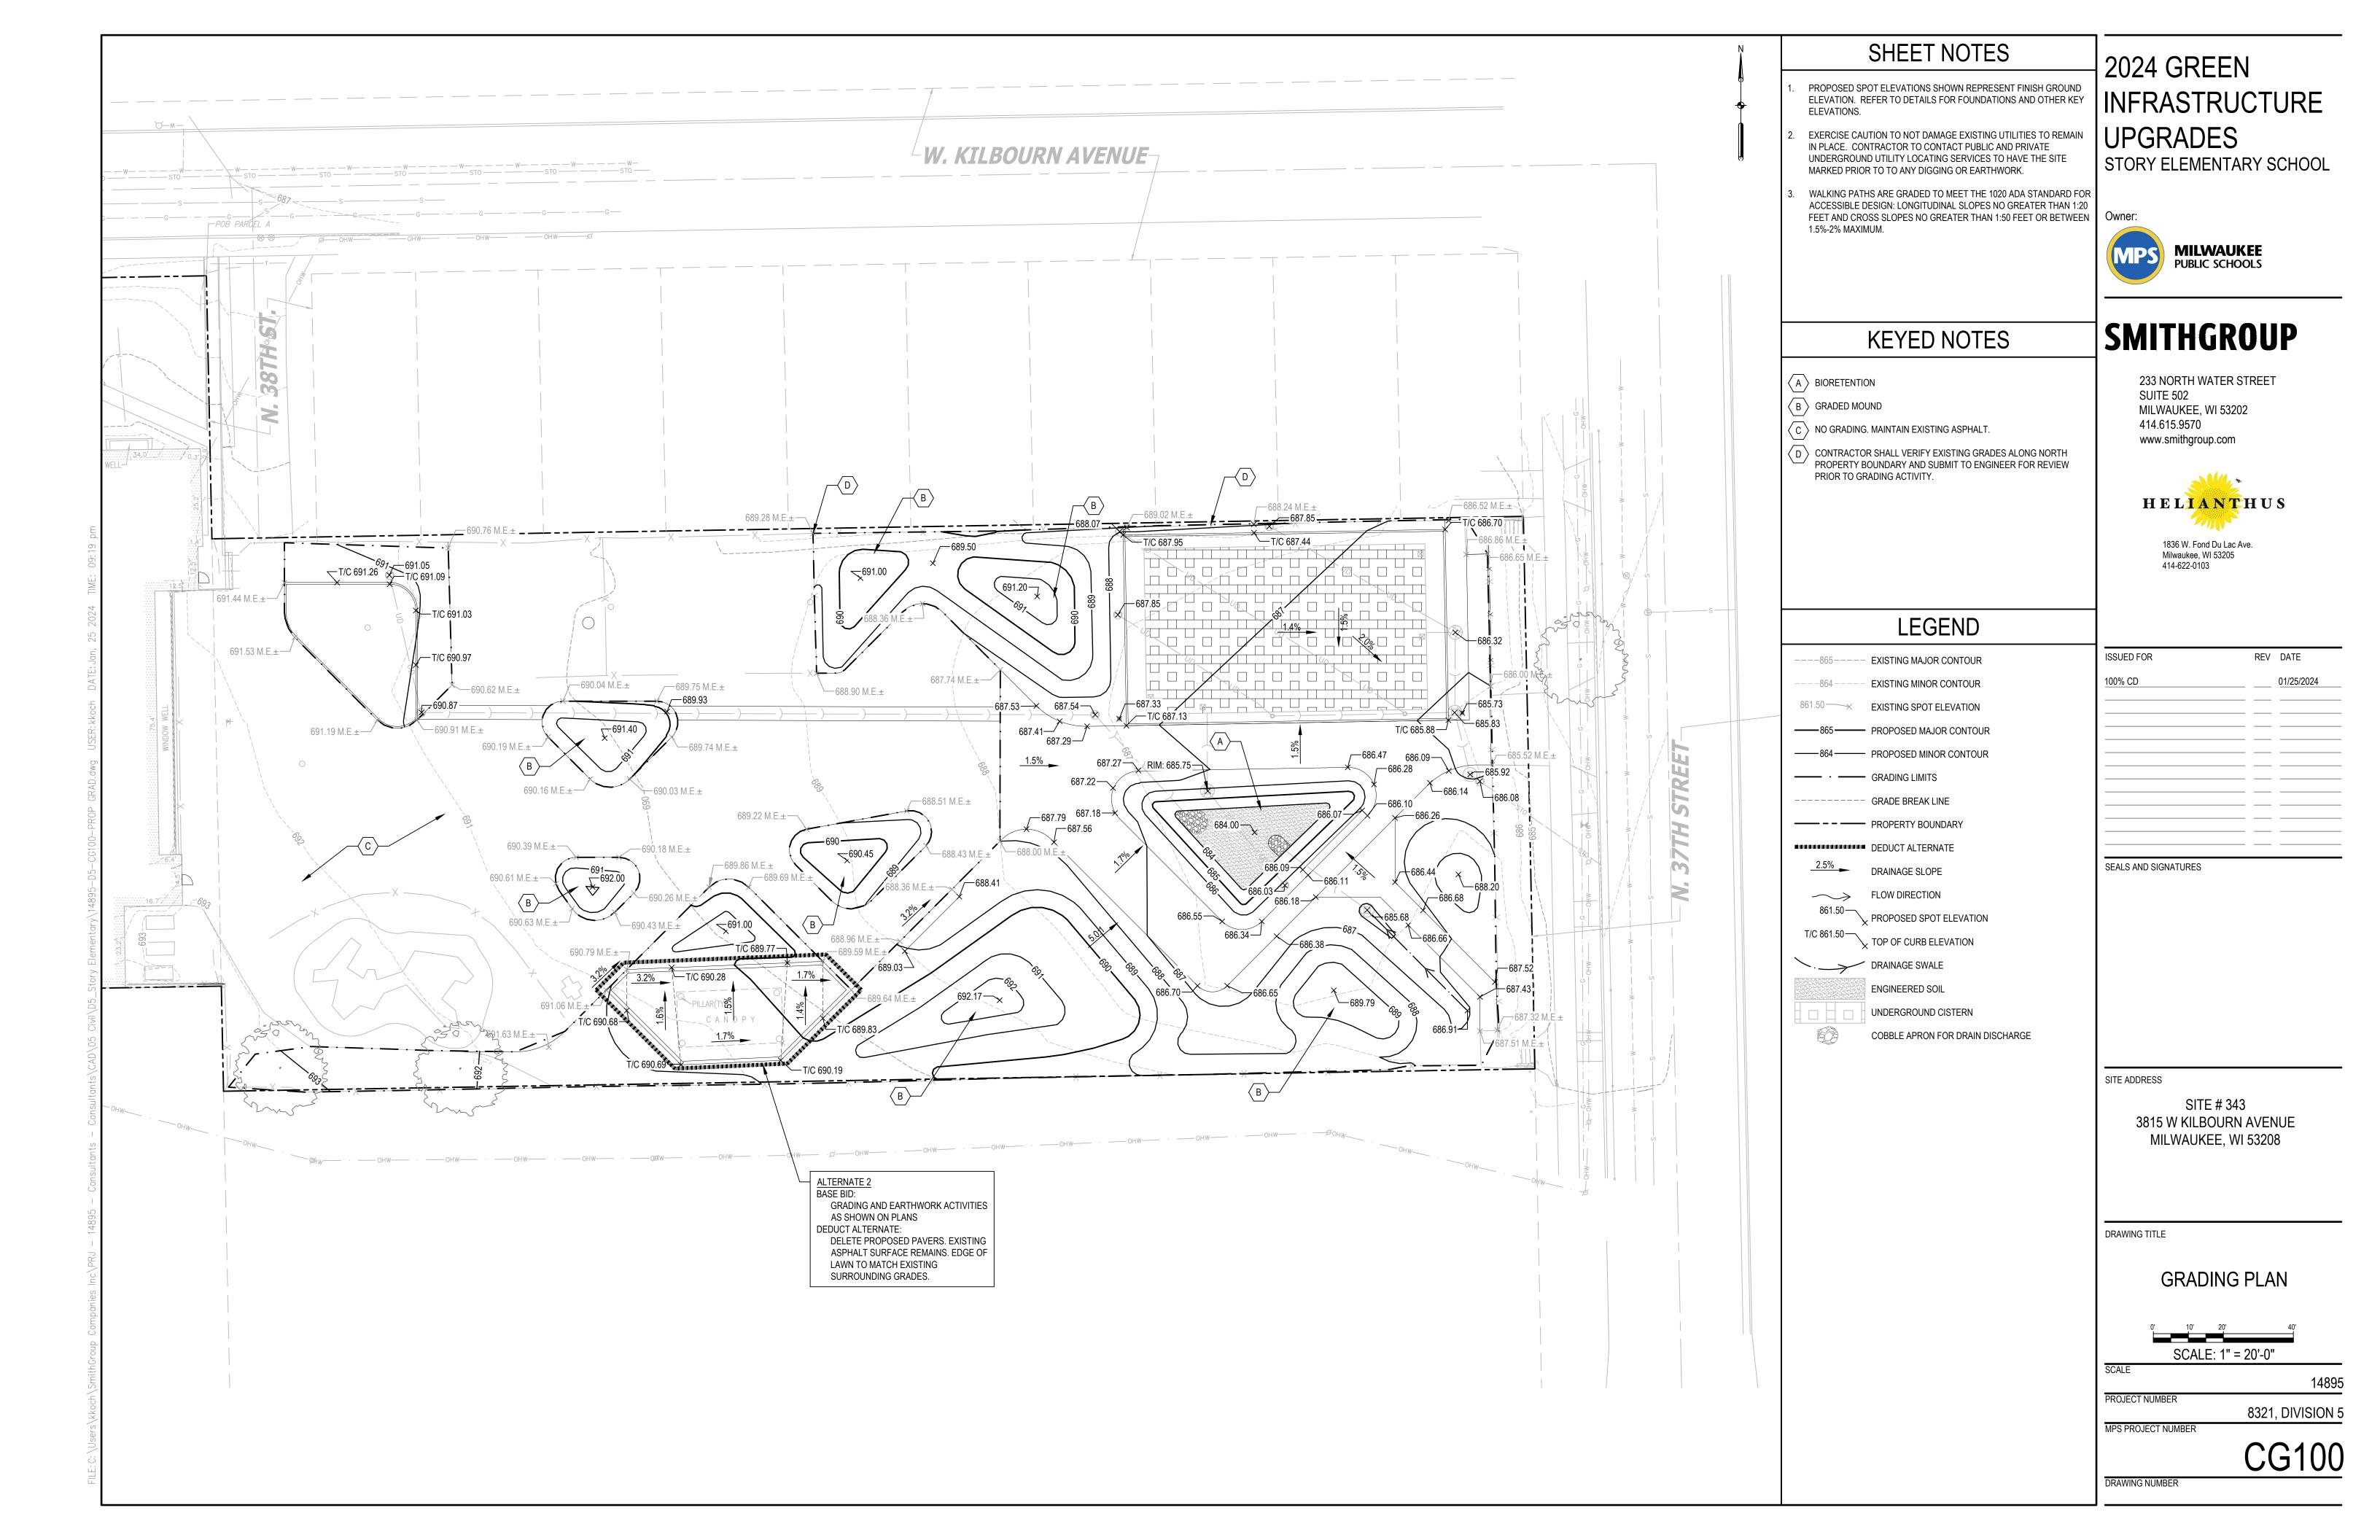
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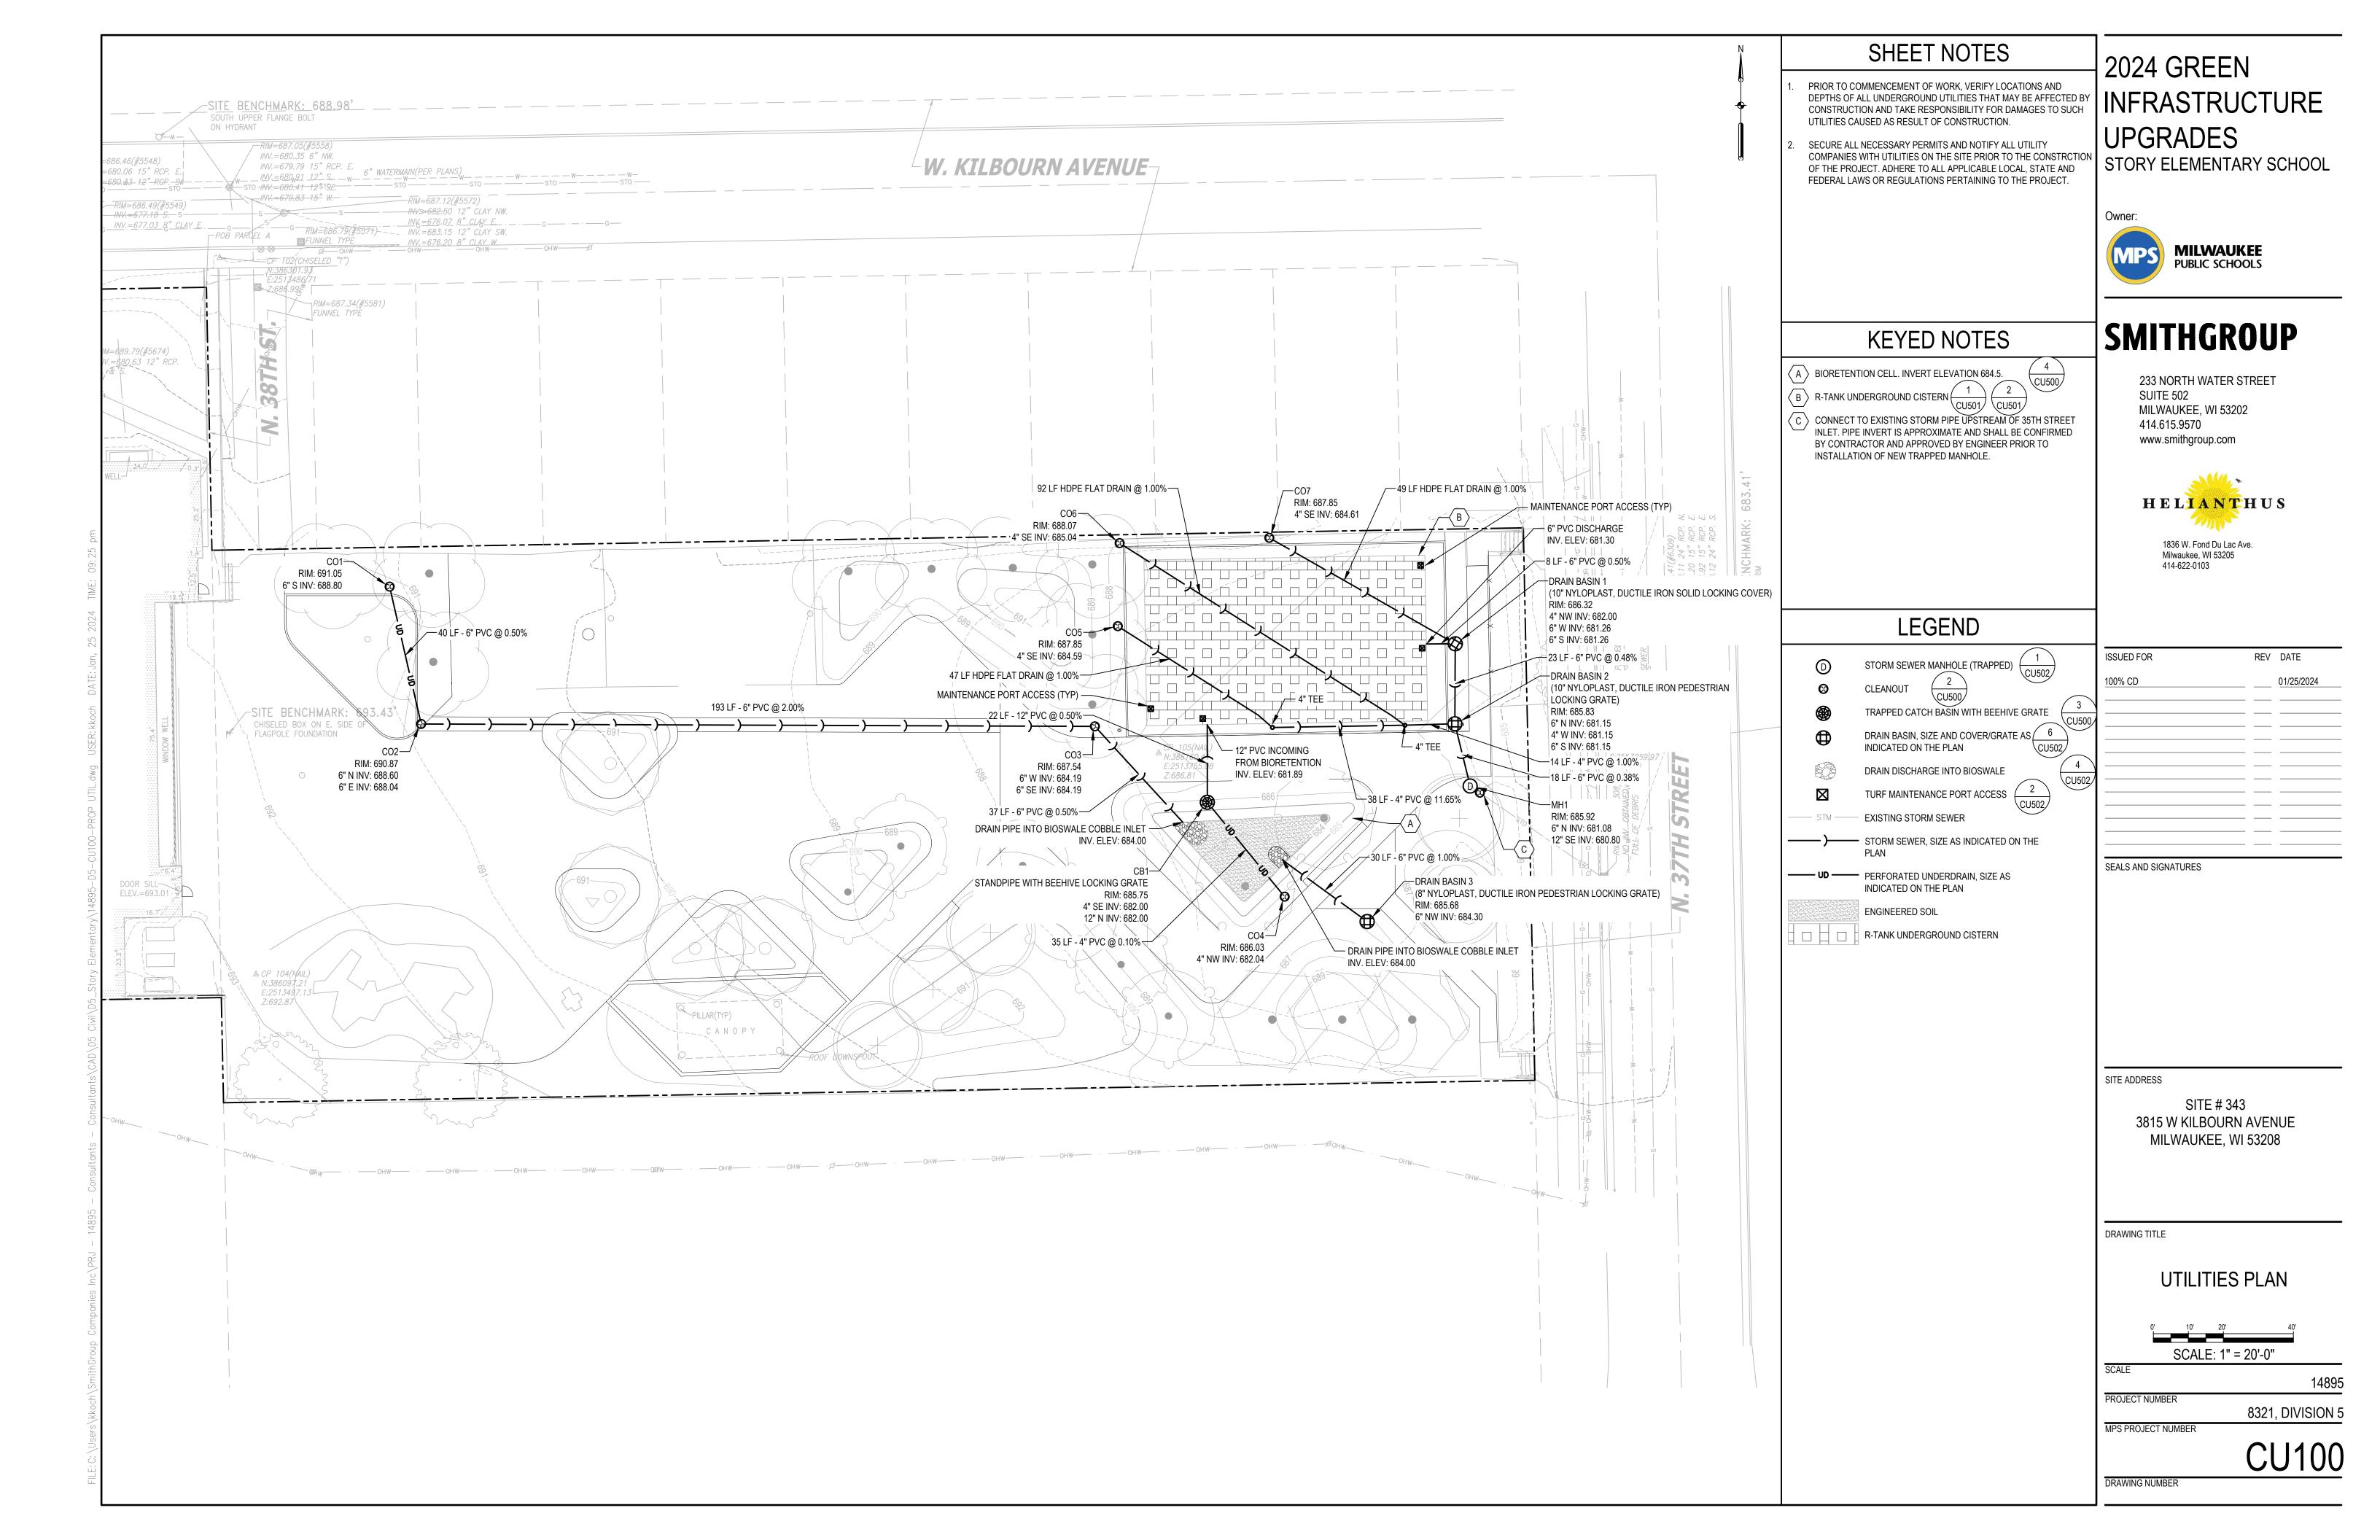
EXISTING CONDITIONS


SCALE PROJECT NUMBER 8321, DIVISION 5 MPS PROJECT NUMBER






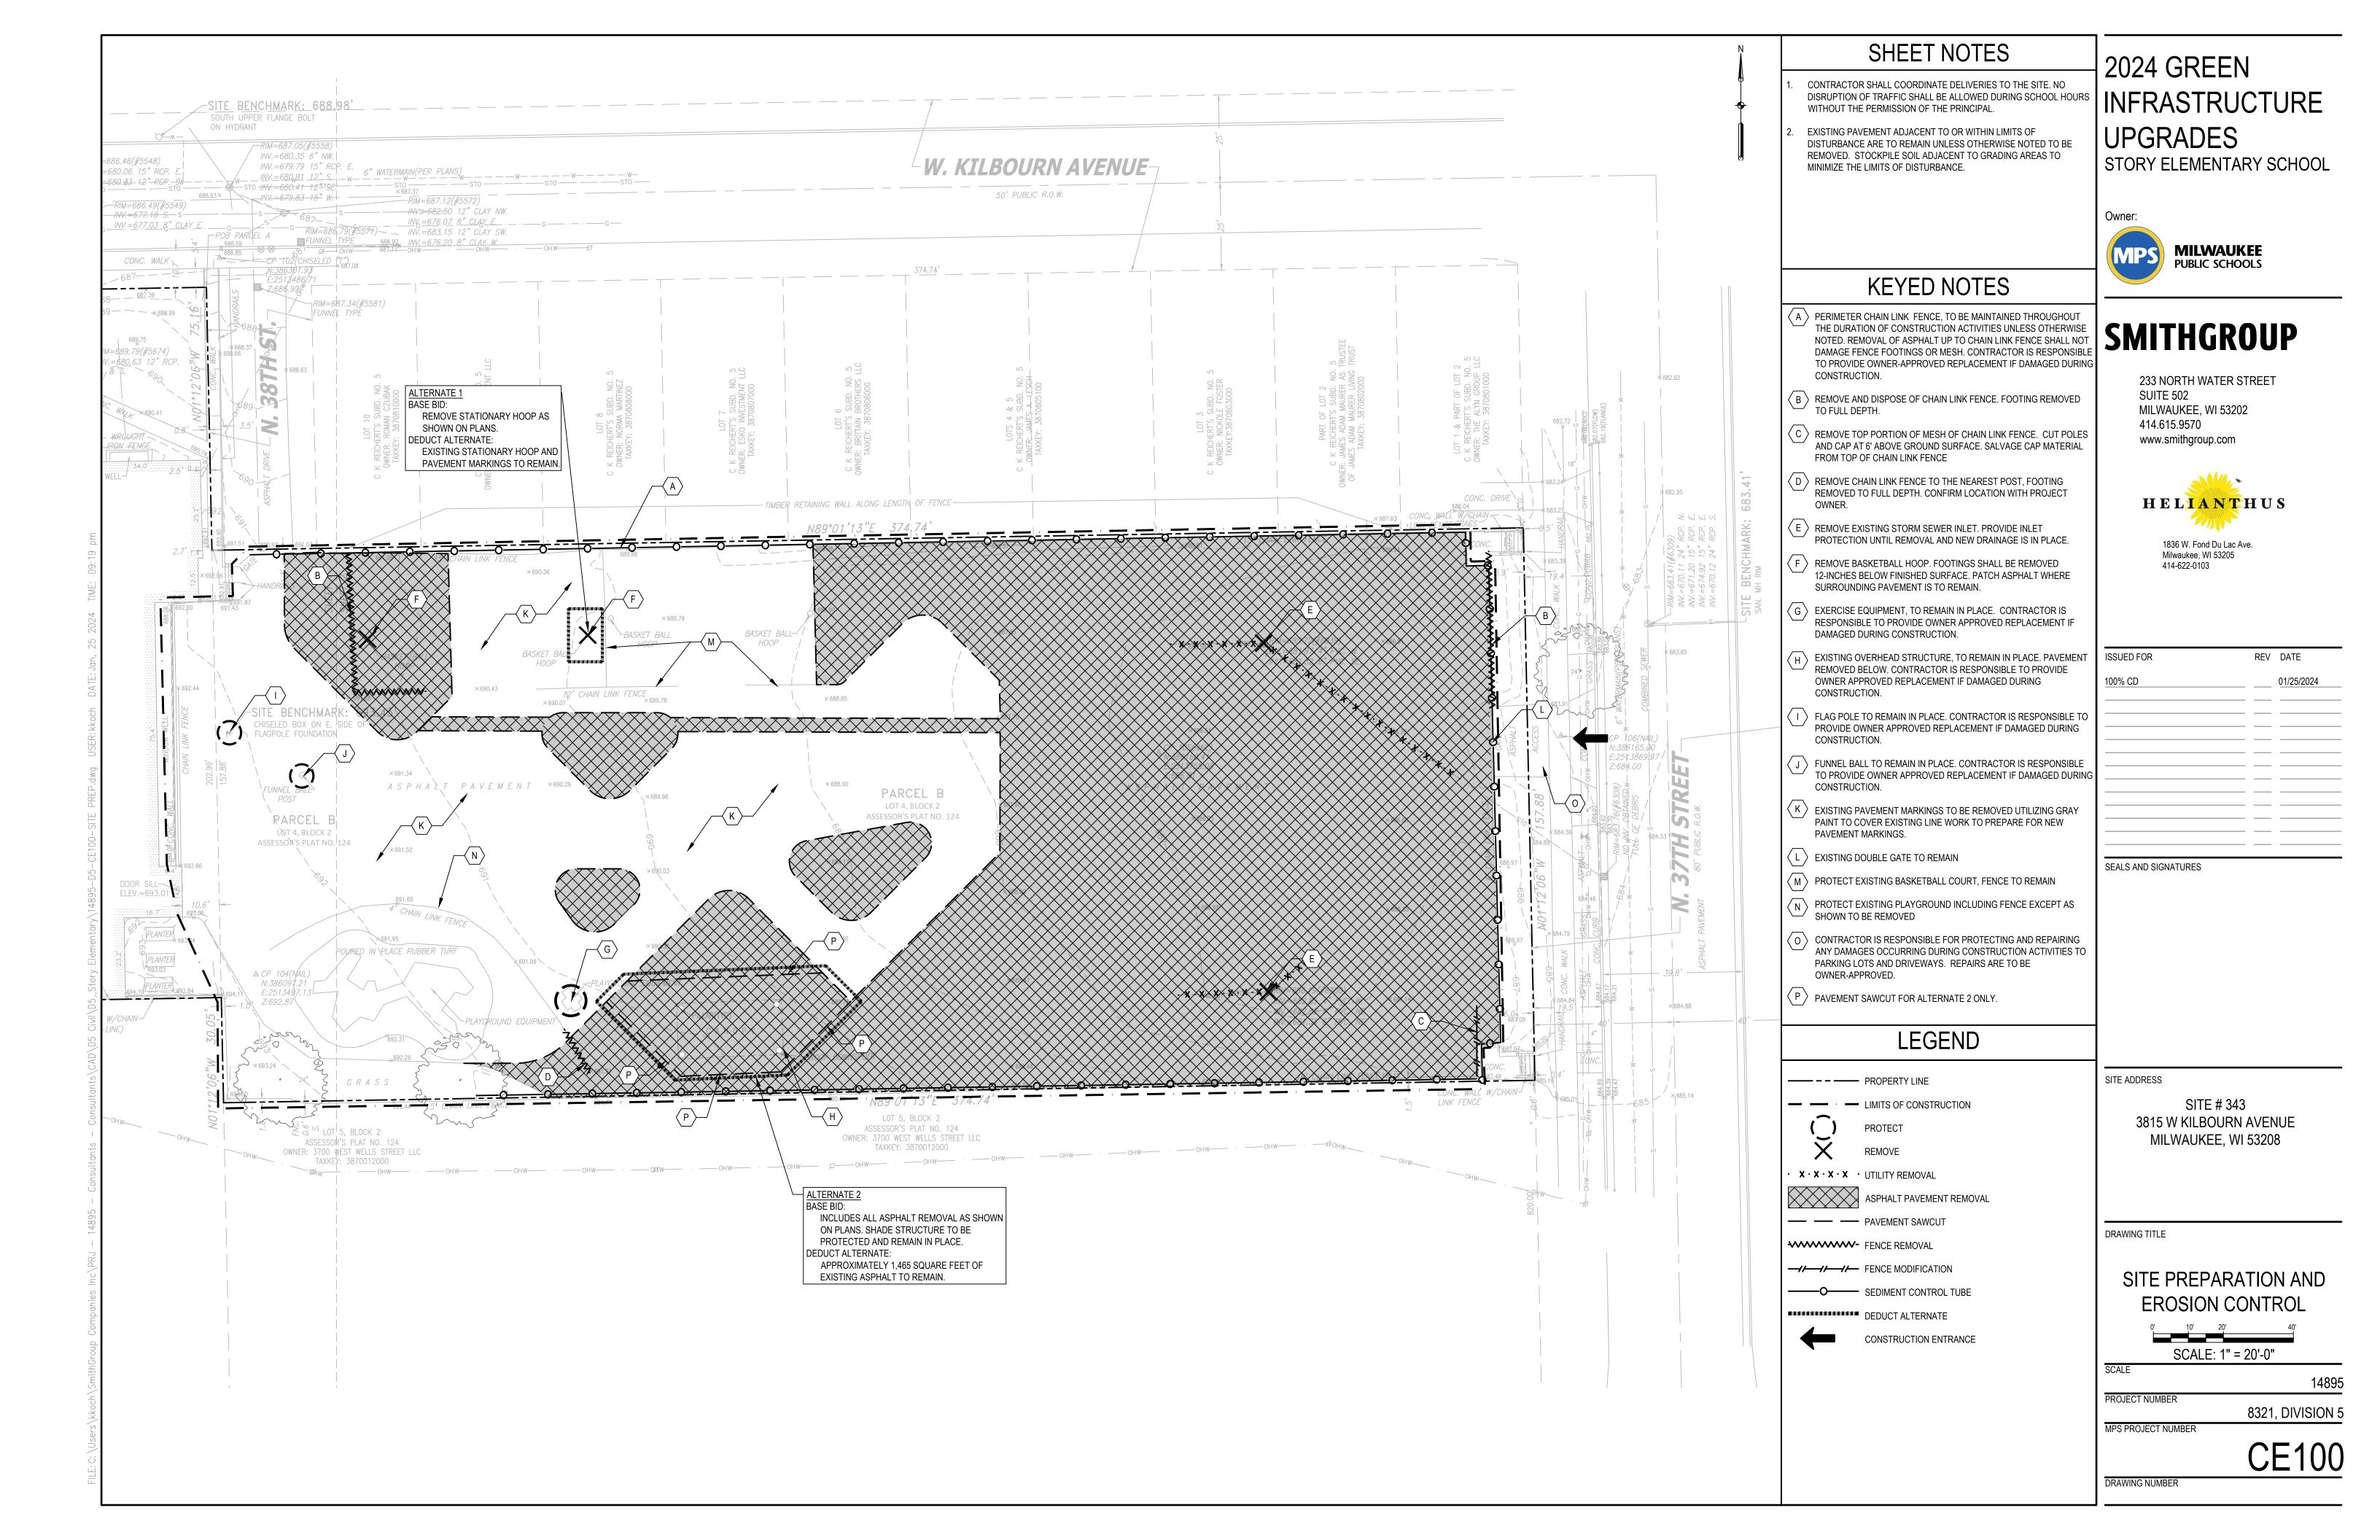

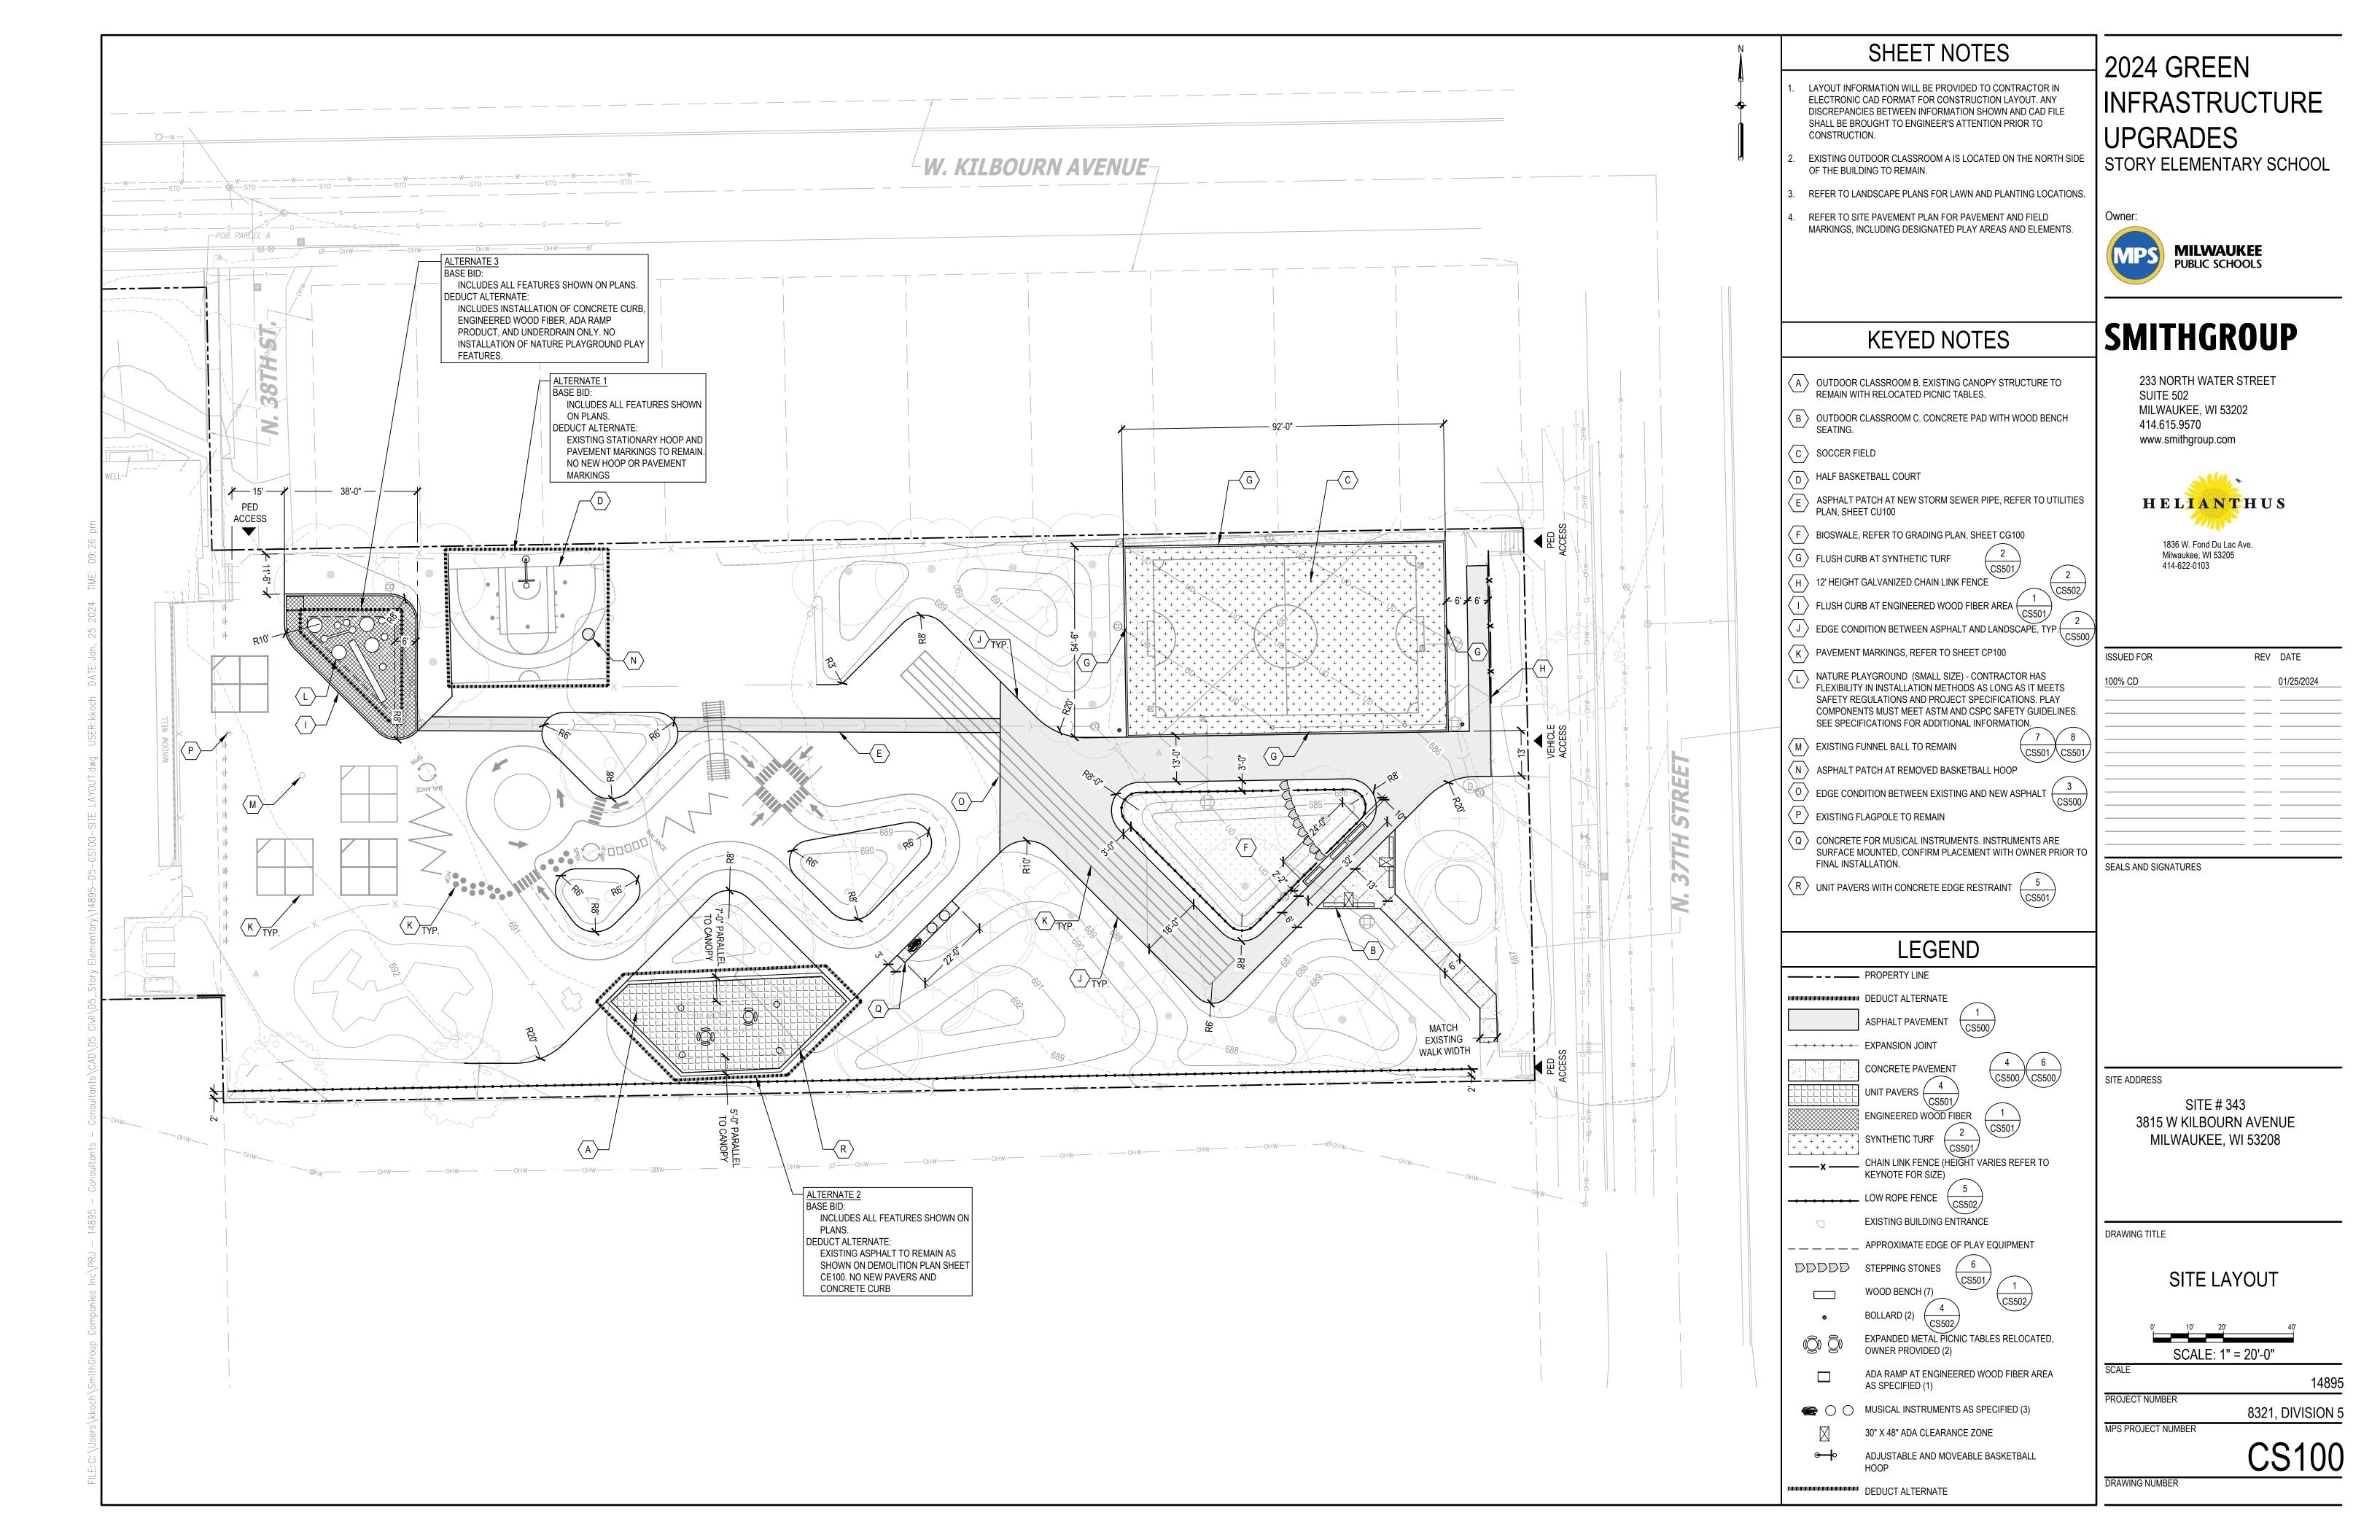

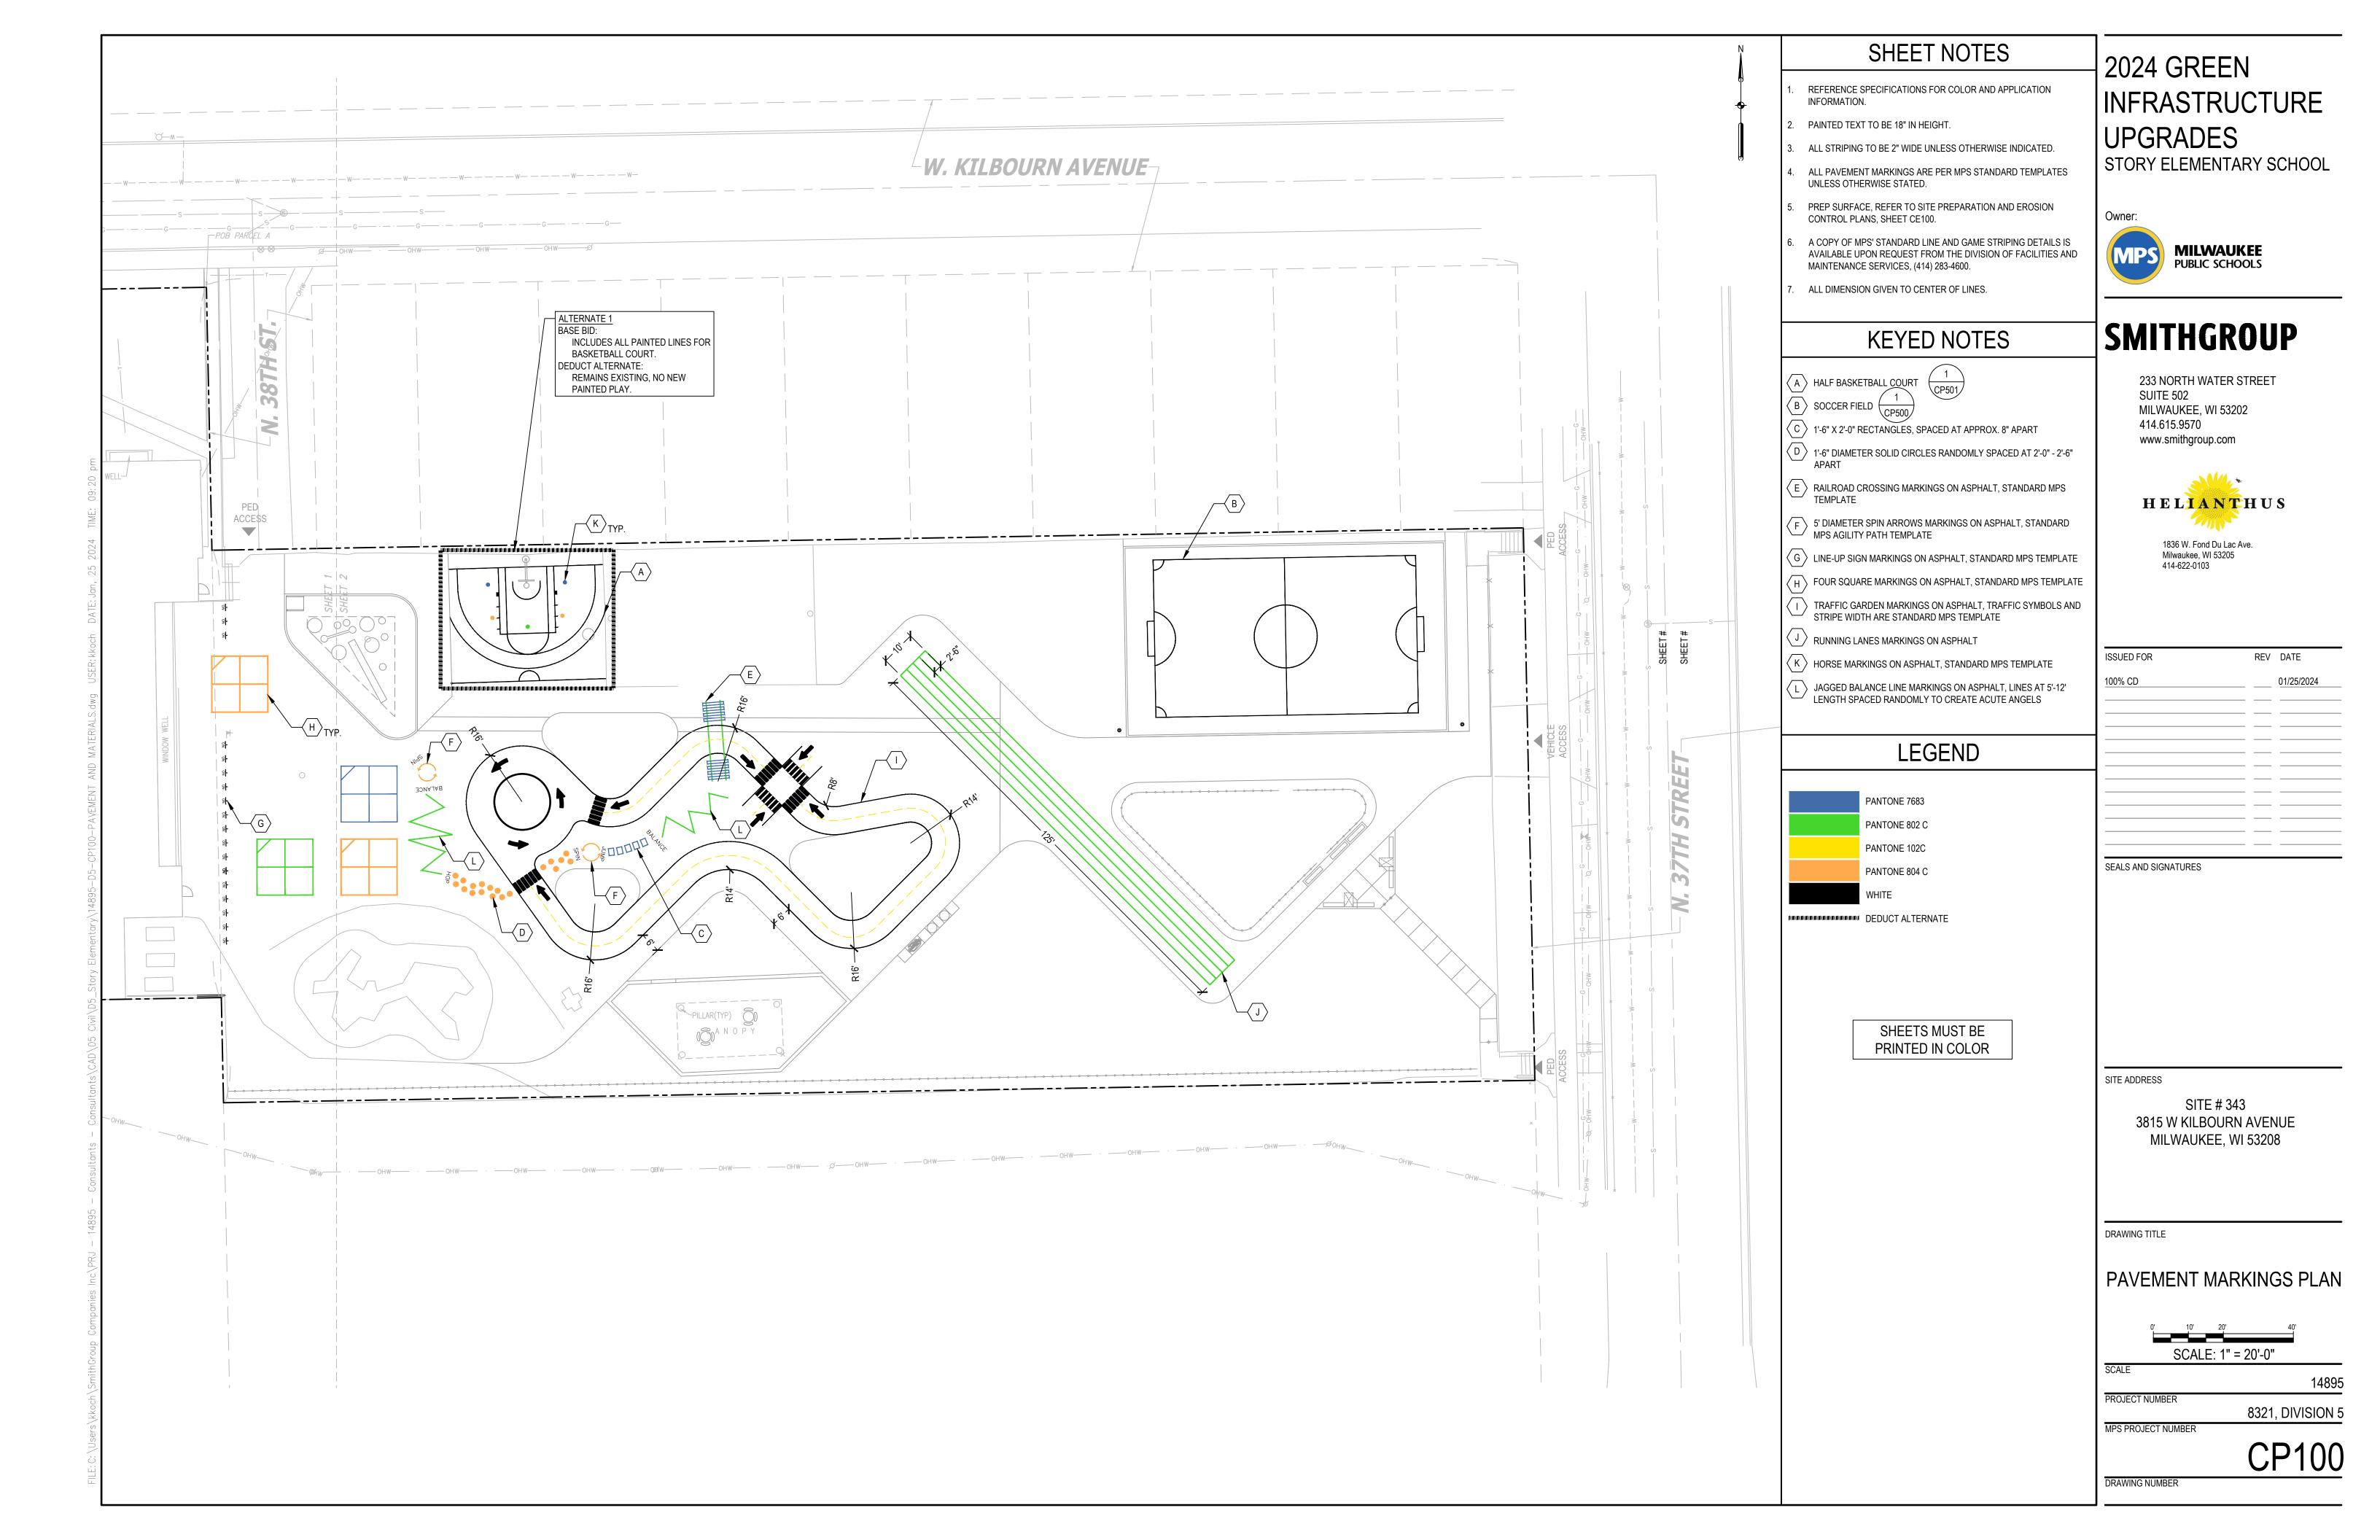


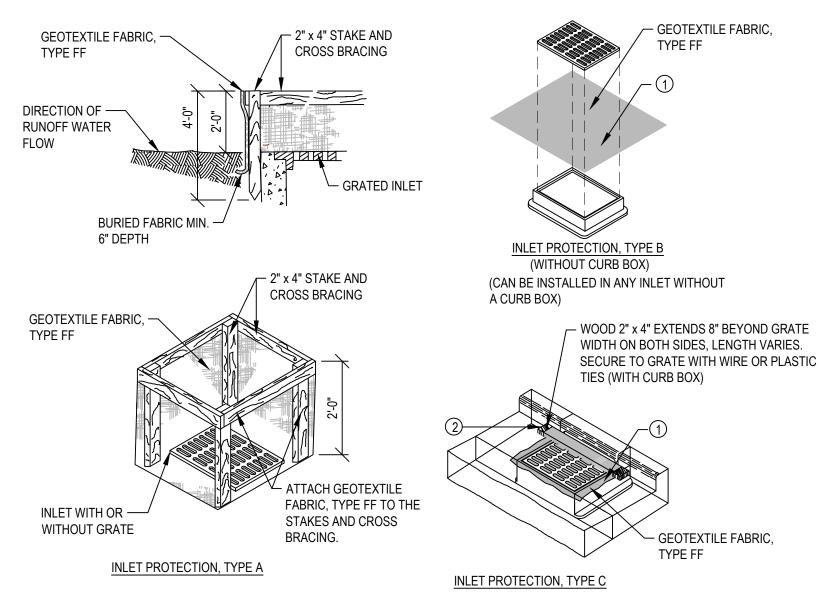

GENERAL NOTES:

MANUFACTURED ALTERNATIVES APPROVED AND LISTED ON THE DEPARTMENT'S EROSION CONTROL PRODUCT ACCEPTABILITY LIST MAY BE SUBSTITUTED. WHEN REMOVING OR MAINTAINING INLET PROTECTION, CARE SHALL BE TAKEN SO THAT THE SEDIMENT TRAPPED ON THE GEOTEXTILE FABRIC DOES NOT FALL INTO THE INLET. ANY MATERIAL FALLING INTO THE INLET SHALL BE REMOVED IMMEDIATELY.

- 1. FINISHED SIZE, INCLUDING FLAP POCKETS WHERE REQUIRED, SHALL EXTEND A MINIMUM OF 10" AROUND THE PERIMETER TO FACILITATE MAINTENANCE OR REMOVAL.
- FOR INLET PROTECTION, TYPE C (WITH CURB BOX), AN ADDITIONAL 18" OF FABRIC IS WRAPPED AROUND THE WOOD AND SECURED WITH STAPLES. THE WOOD SHALL NOT BLOCK THE ENTIRE HEIGHT OF THE CURB BOX OPENING.
- 3. FLAP POCKETS SHALL BE LARGE ENOUGH TO ACCEPT WOOD 2x4.

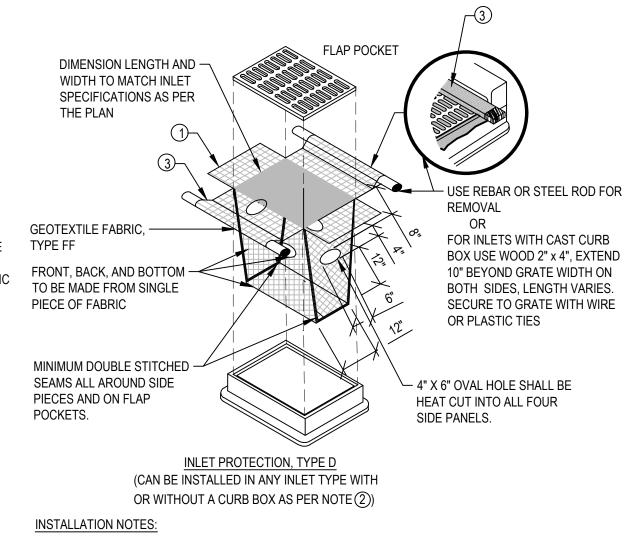


TYPE B & C

TRIM EXCESS FABRIC IN THE FLOW LINE TO WITHIN 3" OF THE GRATE. THE CONTRACTOR SHALL DEMONSTRATE A METHOD OF MAINTENANCE, USING A SEWN FLAP, HAND HOLDS OR OTHER METHOD TO PREVENT ACCUMULATED SEDIMENT FROM ENTERING THE INLET.

DO NOT INSTALL INLET PROTECTION TYPE D IN INLETS SHALLOWER THAN 30", MEASURED FROM THE BOTTOM OF THE INLET TO THE TOP OF THE GRATE. TRIM EXCESS FABRIC IN THE FLOW LINE TO WITHIN 3" OF THE GRATE. THE INSTALLED BAG SHALL HAVE A MINIMUM SIDE CLEARANCE, BETWEEN THE INLET WALLS AND THE BAG, MEASURED AT THE BOTTOM OF THE OVERFLOW HOLES, OF 3". WHERE NECESSARY THE CONTRACTOR SHALL CINCH THE BAG, USING PLASTIC ZIP TIES, TO ACHIEVE THE 3" CLEARANCE. THE TIES SHALL BE PLACED AT A MAXIMUM OF 4" FROM THE BOTTOM OF THE BAG.

__ 2" x 2" x 36" WOOD STAKES BACK-GROUT W/ TUBE — AT 10'-0" O.C. (MIN.) FILLER MATERIAL DRIVE STAKE 12" MIN. —— , 2'-0" OVERLAP — 12" DIA. TUBE

PLAN VIEW - FLOW 45 TO 90° TO TUBE

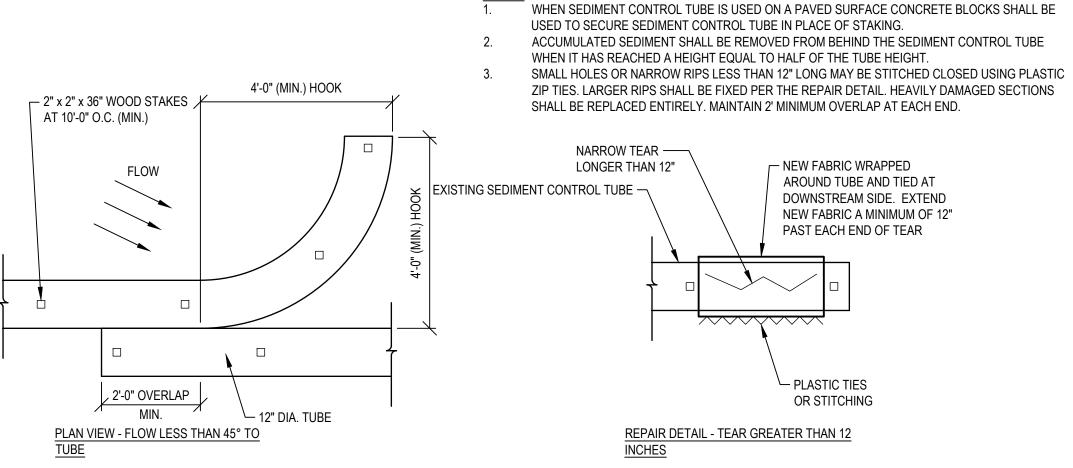

SEDIMENT CONTROL TUBE

INFRASTRUCTURE UPGRADES STORY ELEMENTARY SCHOOL

Owner: **MILWAUKEE PUBLIC SCHOOLS**

2024 GREEN

__ 2" x 2" x 36" WOOD STAKES AT 10'-0" O.C. (MIN.)

─ 12" DIA. TUBE

SECTION VIEW

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SEALS AND SIGNATURES

SCALE: 1"=2'

SITE # 343 3815 W KILBOURN AVENUE

EROSION CONTROL DETAILS


SCALE 8321, DIVISION 5 MPS PROJECT NUMBER

SCALE: 1"=2'

SITE ADDRESS

MILWAUKEE, WI 53208

DRAWING TITLE

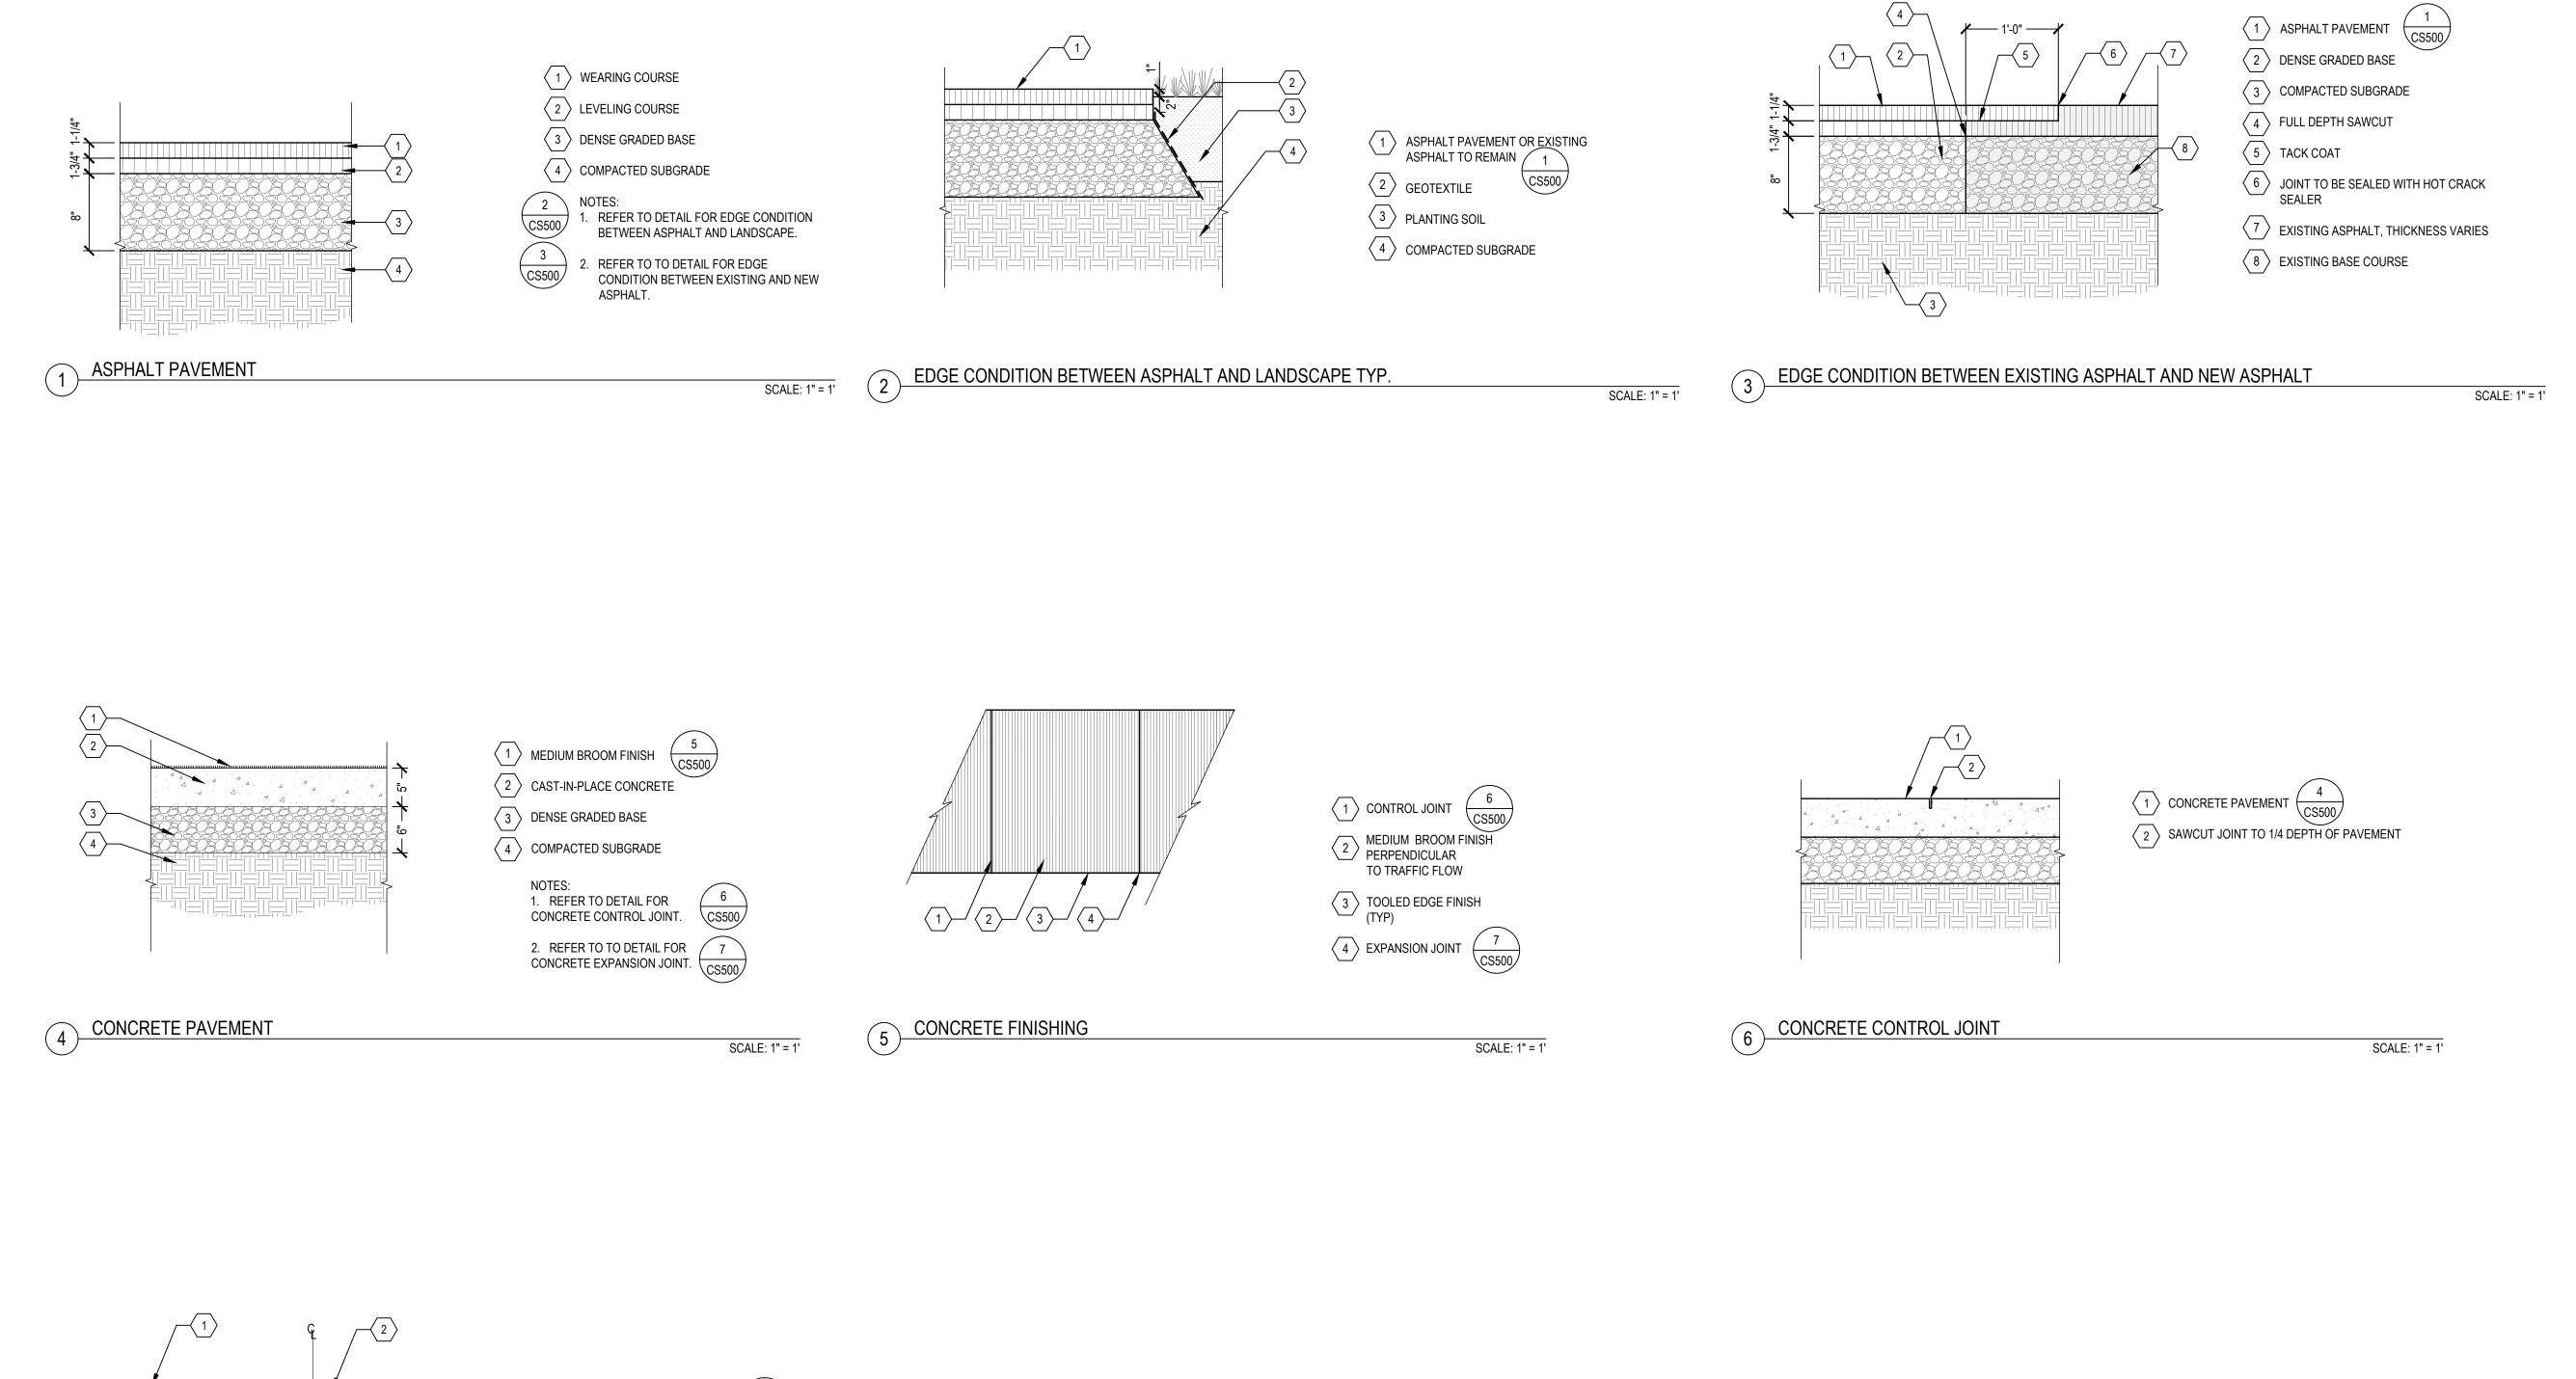

2024 GREEN INFRASTRUCTURE UPGRADES

STORY ELEMENTARY SCHOOL

Owner:



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DRAWING TITLE

DRAWING NUMBER

SITE DETAILS


SCALE	
SCALE	14895
PROJECT NUMBER	
	8321, DIVISION 5
MPS PROJECT NUMBER	
	CS500

CONCRETE EXPANSION JOINT

SCALE: 1" = 1'

1 TOP OF PAVEMENT $\begin{pmatrix} 4 \\ CS500 \end{pmatrix}$

3 PREFORMED EXPANSION JOINT MATERIAL

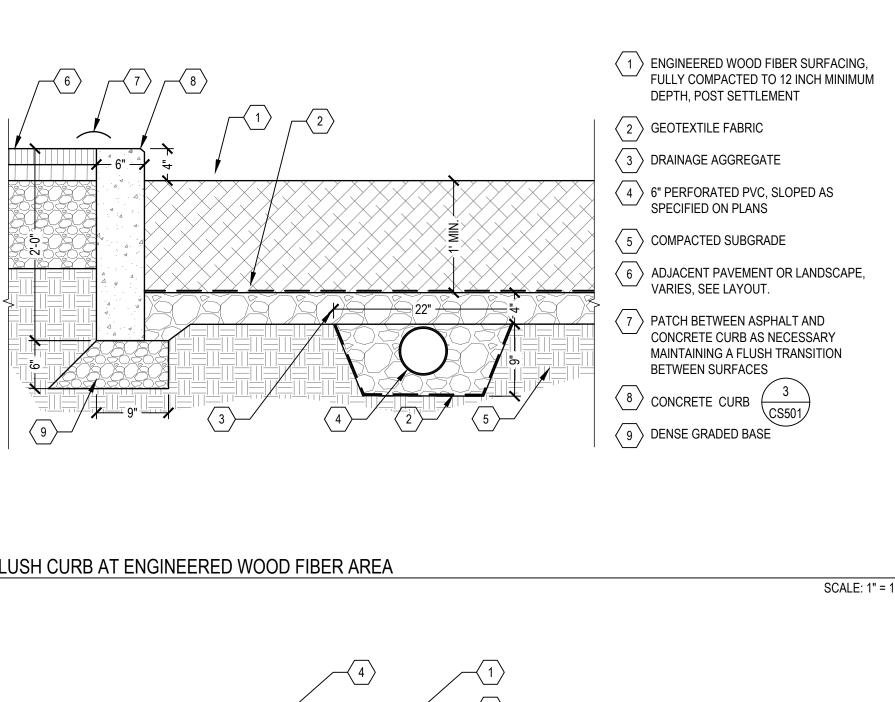

UNIT PAVERS

PERMEABLE BEDDING COURSE: 1" THICK OF ¹/₄" CLEAR OPEN GRADED CHIP

PERMEABLE BASE: OPEN GRADED STONE COMPACTED TO ACHIEVE FULL

JOINTING MATERIAL AND JOINT STABILIZATION: CLEAR STONE CHIP (ASTM


STONE (ASTM NO. 8) SCREEDED OVER BASE

PARTICLE LOCK-UP AND CONSOLIDATION

STABILIZATION GRID BETWEEN SUBGRADE AND BASE

NO. 9) SWEPT IN AS JOINTING INFILL.

COMPACTED SUBGRADE

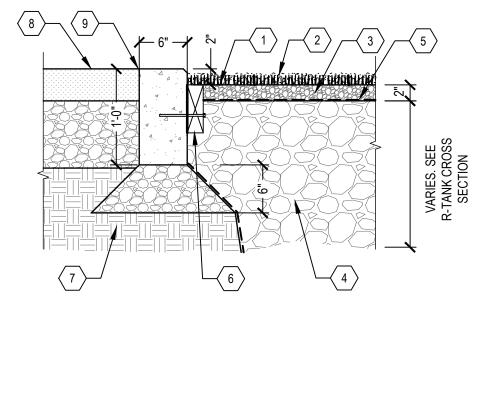


WIDTH VARIES, SEE PLAN AND RELEVANT DETAILS (1) SYNTHETIC TURF 2 2" TURF INFILL MATERIAL 3 CHOKER STONE 4 DRAINAGE AGGREGATE ⟨ 5 ⟩ GEOTEXTILE FABRIC, TYPE DF 6 2 X 6 NAILER BOARD FASTENED WITH 3/8" X 6" BOLT EMBEDDED AND EPOXY GLUED MIN. 2 1 INTO CURB, SPACED 3'-0" O.C. HORIZONTALLY $\langle 7 \rangle$ COMPACTED SUBGRADE 8 ADJACENT PAVEMENT OR LAWN, VARIES, SEE PLAN (9) CONCRETE CURB (

(1) UNIT PAVERS

2 CONCRETE CURB

3 DENSE GRADED BASE

4 COMPACTED SUBGRADE

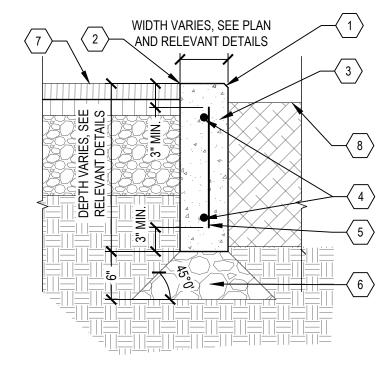

1 1/2' CHAMFER AT 45° WHEN NOT FLUSH WITH ADJACENT PAVEMENT

2 FLUSH WITH ADJACENT PAVEMENT

3 CONCRETE CURB

 $\sqrt{4}$ #4 HORIZONTAL REBAR EPOXY COATED, CONTINUOUS CENTERED IN CURB WIDTH

 $\langle 5 \rangle$ #4 REBAR EPOXY COATED AT 18" O.C.

6 DENSE GRADED BASE

7 ADJACENT PAVEMENT, VARIES, SEE PLAN AND RELEVANT DETAILS

8 ADJACENT MATERIAL, VARIES, SEE PLAN AND RELEVANT DETAILS

NOTES:

1. LIGHTLY BROOM CURB SURFACE WITH GRAIN PERPENDICULAR TO DIRECTION OF

FLUSH CURB AT ENGINEERED WOOD FIBER AREA

FLUSH CURB AT SYNTHETIC TURF

SCALE: 1" = 1'

TYPICAL CURB DETAIL SCALE: 1" = 1'

SCALE: 1" = 1

HELIANTHUS

SUITE 502

414.615.9570

Milwaukee, WI 53205 414-622-0103

2024 GREEN

UPGRADES

Owner:

INFRASTRUCTURE

STORY ELEMENTARY SCHOOL

MILWAUKEE

PUBLIC SCHOOLS

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1836 W. Fond Du Lac Ave.

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UNIT PAVERS

UNIT PAVERS WITH CONCRETE EDGE RESTRAINT

- DENSE GRADED BASE

SCALE: 1" = 1'

3" SCREWS (VARIOUS LENGTHS), HEAD SUNK PAST SURFACE OF LOG, THREADS SUNK MINIMUM 3" — NATURE PLAY FOOTING INTO SUPPORT POSTS — E.W.F. SURFACING CONCRETE FOOTING -INSTALL TWO PIECES —— OF 3" REBAR INTO EACH POST AT ROUGHLY $\frac{1}{3}$ OF THE HEIGHT OF THE FOOTING BEFORE SETTING IN CONC. CONCRETE BLOCKS -OR BRICKS

ALL DEPTHS MUST MEET MANUFACTURER'S SPECIFICATIONS, OR MPS SPECIFICATIONS, WHICHEVER IS GREATER.

2. MAKE FOOTINGS BETWEEN 18"-24" DEEP AND MAKE SURE THERE IS A MINIMUM OF 6" OF CONCRETE AROUND THE SUPPORT

3. ONE SUPPORT POST MUST BE POSITIONED DIRECTLY UNDER THE LOG TO SUPPORT THE WEIGHT, WHILE THE OTHER WILL

- ENGINEERED WOOD FIBER SURFACING CONCRETE REINFORCED WITH MESH — DENSE GRADED BASE

1. ALL DEPTHS MUST MEET MANUFACTURER'S SPECIFICATIONS, OR MPS SPECIFICATIONS,

WHICHEVER IS GREATER.

2. STUMP JUMPERS TO BE INSTALLED AS A STRIP FOOTING. 3. MAKE TRENCH 15"-16" DEEP; 12" OF CONCRETE AND 3"-4" OF COMPACTED GRAVEL, AND MAKE SURE THERE IS A MINIMUM OF 6" OF CONCRETE AROUND THE SIDES OF THE JUMPERS.

4. INSTALL TWO PIECES OF $\frac{2}{8}$ " REBAR INTO EACH SUPPORT JUMPER AT ROUGHLY $\frac{1}{3}$ OF THE HEIGHT OF THE FOOTING BEFORE SETTING IN CONCRETE.

5. LENGTH OF STUMP JUMPERS VARIES DEPENDING ON DESIRED HEIGHT AND AGE GROUP, 4 STANDARD LENGTHS ARE PROVIDED; 32", 42", 48", AND 52", BUT THEY CAN BE CUT TO CUSTOM

6. STUMP JUMPERS MUST BE A MIN. OF 10" IN DIAMETER

7. STUMP JUMPERS MUST NOT BE HIGHER THAN 20" FROM PROTECTIVE SURFACING WHEN

INTENDED FOR 2-5 YEAR OLDS, AND 30" FOR 5-12 YEAR OLDS.

ROUND ALL EXPOSED EDGES AND REMOVE SAW MARKS WITH A SANDER OR GRINDER. 9. INSTALLER TO PROVIDE PERMANENT HIGH AND LOW MARKS (AT LEAST 3 VERTICALS) FOR ENGINEER WOOD FIBER SAFETY SURFACING.

SITE DETAILS

SITE # 343

3815 W KILBOURN AVENUE

MILWAUKEE, WI 53208

SITE ADDRESS

DRAWING TITLE

SCALE

DRAWING NUMBER

PROJECT NUMBER 8321, DIVISION 5 MPS PROJECT NUMBER

STEPPING STONES SCALE: 1" = 1'

NATURE PLAY FOOTINGS (MPS STANDARD DETAIL)

BEYOND THE SURFACE OF THE LOG TO PREVENT POTENTIAL ENTANGLEMENTS HAZARDS.

STUMP JUMPERS FOOTING (MPS STANDARD DETAIL)

NOT TO SCALE

1. PLACE STEPPING STONES TO CONFIGURATIONS AND LOCATION AS SHOWN ON PLAN.

SECTION OF STEPPING STONES

2. SELECT AND PLACE STEPPING STONES SO THAT A MINIMUM OF EXCAVATION SCARS ARE VISIBLE. 3. STEPPING STONES TO BE APPROVED BY OWNER'S PROJECT REPRESENTATIVE PRIOR TO

PLACEMENT. 4. DO NOT FRACTURE STEPPING STONES DURING PLACEMENT, SUCH ACTION WILL BE CAUSE FOR

AFTER PLACEMENT.

REJECTION. 5. WASH OFF STEPPING STONES COMPLETELY

✓ WIDTH OF STONE A

 \langle A \rangle WIDTH OF STONE - 18" TO 24"

 \langle B \rangle LENGTH OF STONE- 24" TO 30" \langle C \rangle HEIGHT OF STONE- 18" TO 24" HEIGHT

STONE STEPPERS DIMENSIONS:

 \langle D \rangle HEIGHT ABOVE FINISHED GRADE - 2" TO 4"

WHEN PLACED ON A SLOPE, THE TOP OF THE STONE SHOULD BE LEVEL. MAINTAIN THE MINIMUM HEIGHT OF 2" ABOVE FINISHED GRADE AT THE STONE'S HIGHER ⟨ 1 ⟩ STEPPING STONES

2 ADJACENT PLANTINGS, SEE PLANTING PLAN

BIOSWALE SOIL, SEE PLANTING DETAILS.

BELOW STEPPING STONES

PLAN OF A STEPPING STONE


WIDTH OF STONE - A


4 COMPACTED SUBGRADE

STABILIZE THE LOG LATERALLY ONCE THE HARDWARE IS INSTALLED. 4. INSTALL TWO PIECES OF 3" REBAR INTO EACH SUPPORT POST AT ROUGHLY A THIRD OF THE HEIGHT OF THE FOOTING BEFORE SETTING IN CONCRETE. PRE-DRILL A COUNTERSINK HOLE INTO THE LOG DEEP ENOUGH SO THAT WASHER AND SCREW HEAD DO NOT PROTRUDE

6. PLEASE NOTE: BLACK LOCUST (ROBINIA) IS EXTREMELY DENSE. NOT DRILLING A PILOT HOLE WILL POTENTIALLY RESULT IN A 7. ATTACH LOG TO A SECOND SUPPORT POST WITH 8",10",12" OR LONGER, $\frac{3}{8}$ " STRUCTURAL, COATED LAG SCREW. 8. ROUND ALL EXPOSED EDGES AND REMOVE SAW MARKS WITH A SANDER.

NOT TO SCALE

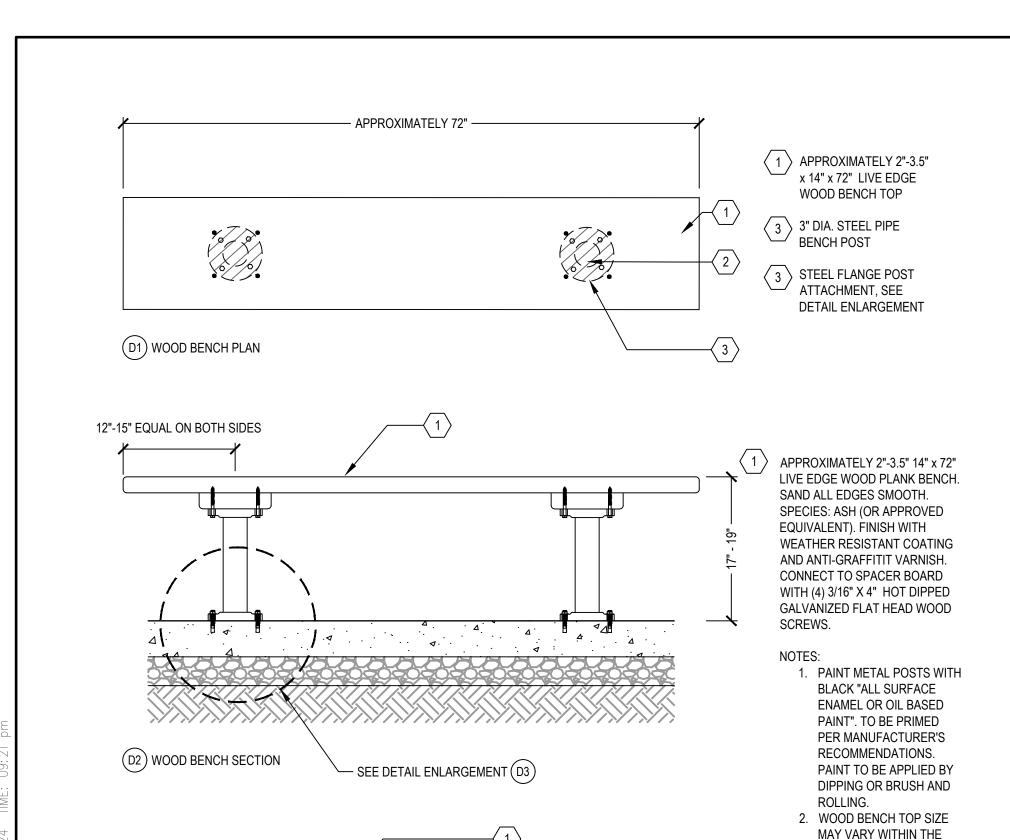

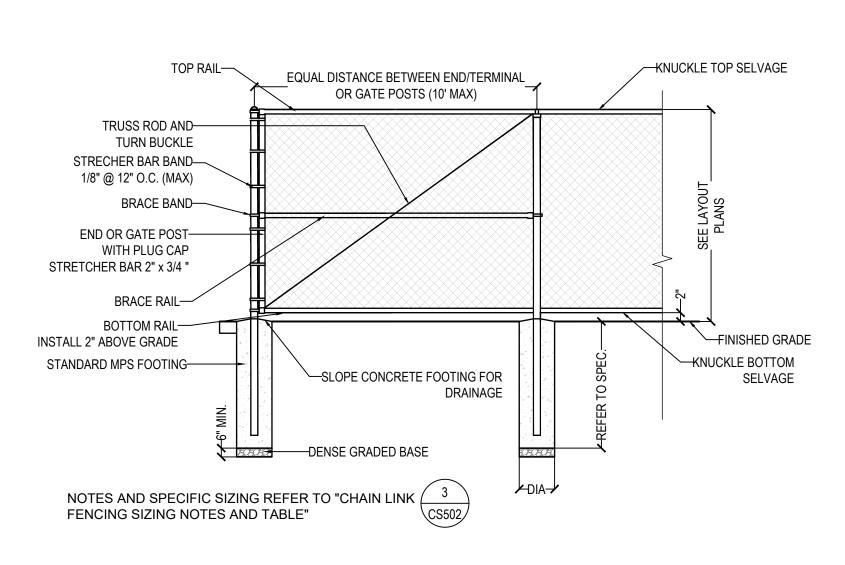

DOOT TYDE	LIFICLIT (!!)	DOCT DIA (II)	FOOT DEPTH MIN. (")	FOOT DIA MINI (II)
POST TYPE	HEIGHT (")	POST DIA.(")	*	FOOT DIA. MIN. (")
LINE	< 4'	0'-2"	4'-0"	0'-10"
LINE	4' - 14'	0'-2 1/2"	4'-0"	0'-10"
LINE	> 14'	3'-0"	6'-0"	1'-0"
END	< 4'	0'-2 1/2"	4'-0"	0'-10"
END	4' - 12'	0'-3"	4'-0"	1'-0"
END	> 12'	0'-4"	6'-0"	1'-0"
GATE	4' - 6'	0'-3"	6'-0"	1'-0"
GATE	7' - 12'	0'-4"	6'-0"	1'-0"
GATE	> 12'	0'-6"	8'-0"	1'-2"

AT BOTTOM OF HOLE. POST

EMBEDMENT TO BE 6" LESS

W/ OWNER DURING SHOP DRAWING REVIEW

INCLUSIVE OF 6" OF STONE

1. COORDINATE LAYOUT AND INSTALLATION WITH CONCRETE WORK. LOCATE FENCE POSTS AT CONCRETE SCORE JOINTS AS SHOWN ON PLANS WHERE APPLICABLE.

THAN DIMENSION SHOWN. 2. SUBMIT SHOP DRAWINGS FOR FENCE AS SPECIFIED


3. SEE SPECIFICATIONS FOR FENCE FOOTING REQUIREMENTS

*REVIEW AGAINST FIELD 4. FINAL DEPTH OF FOOTING NOT TO BE LESS THAN 4' OF CONCRETE

CONDITIONS AND CONFIRM 5. SLOPE TOP OF FOOTINGS 1-2% PITCHING AWAY FROM POSTS

CHAIN LINK FENCE SIZING TABLE AND NOTES

NOT TO SCALE

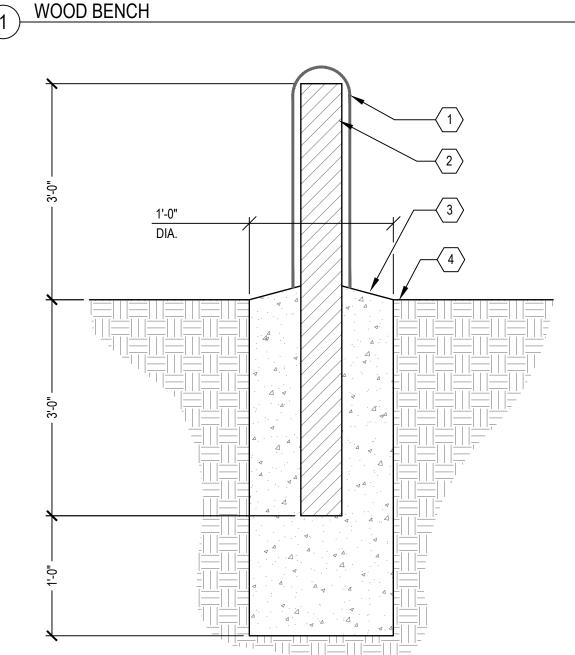

D3) WOOD BENCH DETAIL ENLARGEMENT

BOLLARD BOLLARD

BOLLARD COVER. COVER TO BE HDPE THERMOPLASTIC SLEEVE, MANUFACTURED BY IDEAL SHIELD OR APPROVED

NOT TO SCALE

RANGE OF 72" TO 75"

BASED ON THE NATURAL

WOOD MATERIAL'S LIVE

EDGE. THE WOOD BENCH

THE LAYOUT AS SHOWN.

TOP SHOULD BE

APPROPRIATELY SOURCED TO FIT WITHIN

6"Ø SCH. 40 GALVANIZED STEEL PIPE FILLED WITH CONCRETE

ANCHOR COVER PER MANUFACTURER'S INSTRUCTIONS.

(3) CONCRETE FOOTER SLOPE SURFACE TO DRAIN

EQUAL. COLOR BY OWNER. INSTALL AND

4 FINISH GRADE

(1) 3" DIA. THREADED STEEL PIPE


DIPPED GALVANIZED.

2 THREADED STEEL FLANGE, SIZE TO ACCEPT 3" DIA.

PIPE, ATTACH TO CONCRETE WITH (4) 3-3/4" WEDGE

ANCHORS, 1/2" ANCHOR DIA. GALVANIZE WITH NUTS

AND LOCK WASHERS. ALL HARDWARE TO BE HOT

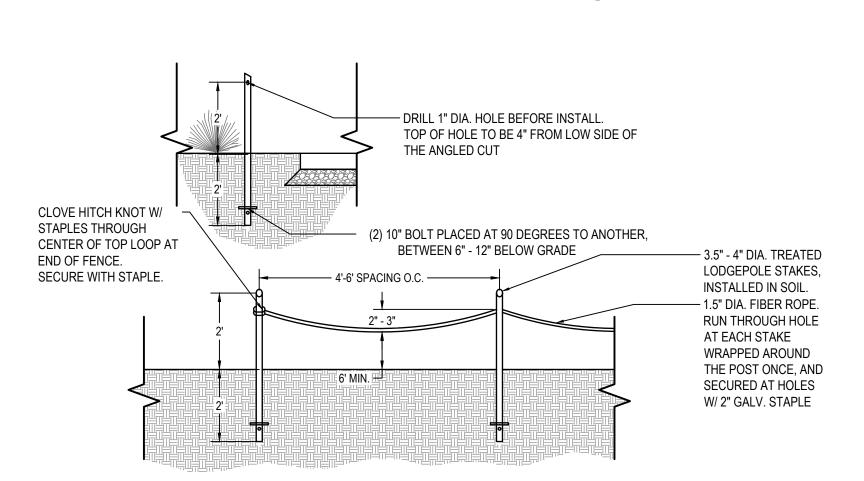

NOT TO SCALE

- CUT TOP OF POLE AT A 30 DEGREE ANGLE. THE ANGLED SIDE IS TO FACE THE ACTIVE AREA. SAND TOP OF EACH POLE AFTER INSTALL TO REMOVE ANY SPLINTERS.
- 3. ROPE TO COME WITHIN 3" OF GROUND IF STEPPED ON.

5 LOW ROPE FENCE (MPS STANDARD DETAIL)

NOT TO SCALE

2024 GREEN INFRASTRUCTURE UPGRADES STORY ELEMENTARY SCHOOL



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100% CD		01/25/2024

SITE ADDRESS

SITE # 343 3815 W KILBOURN AVENUE MILWAUKEE, WI 53208

DRAWING TITLE


DRAWING NUMBER

SITE DETAILS

SCALE PROJECT NUMBER 8321, DIVISION 5 MPS PROJECT NUMBER

8'-12' HEIGHT CHAIN LINK FENCE (MPS STANDARD DETAIL)

SCALE: 1" = 1'

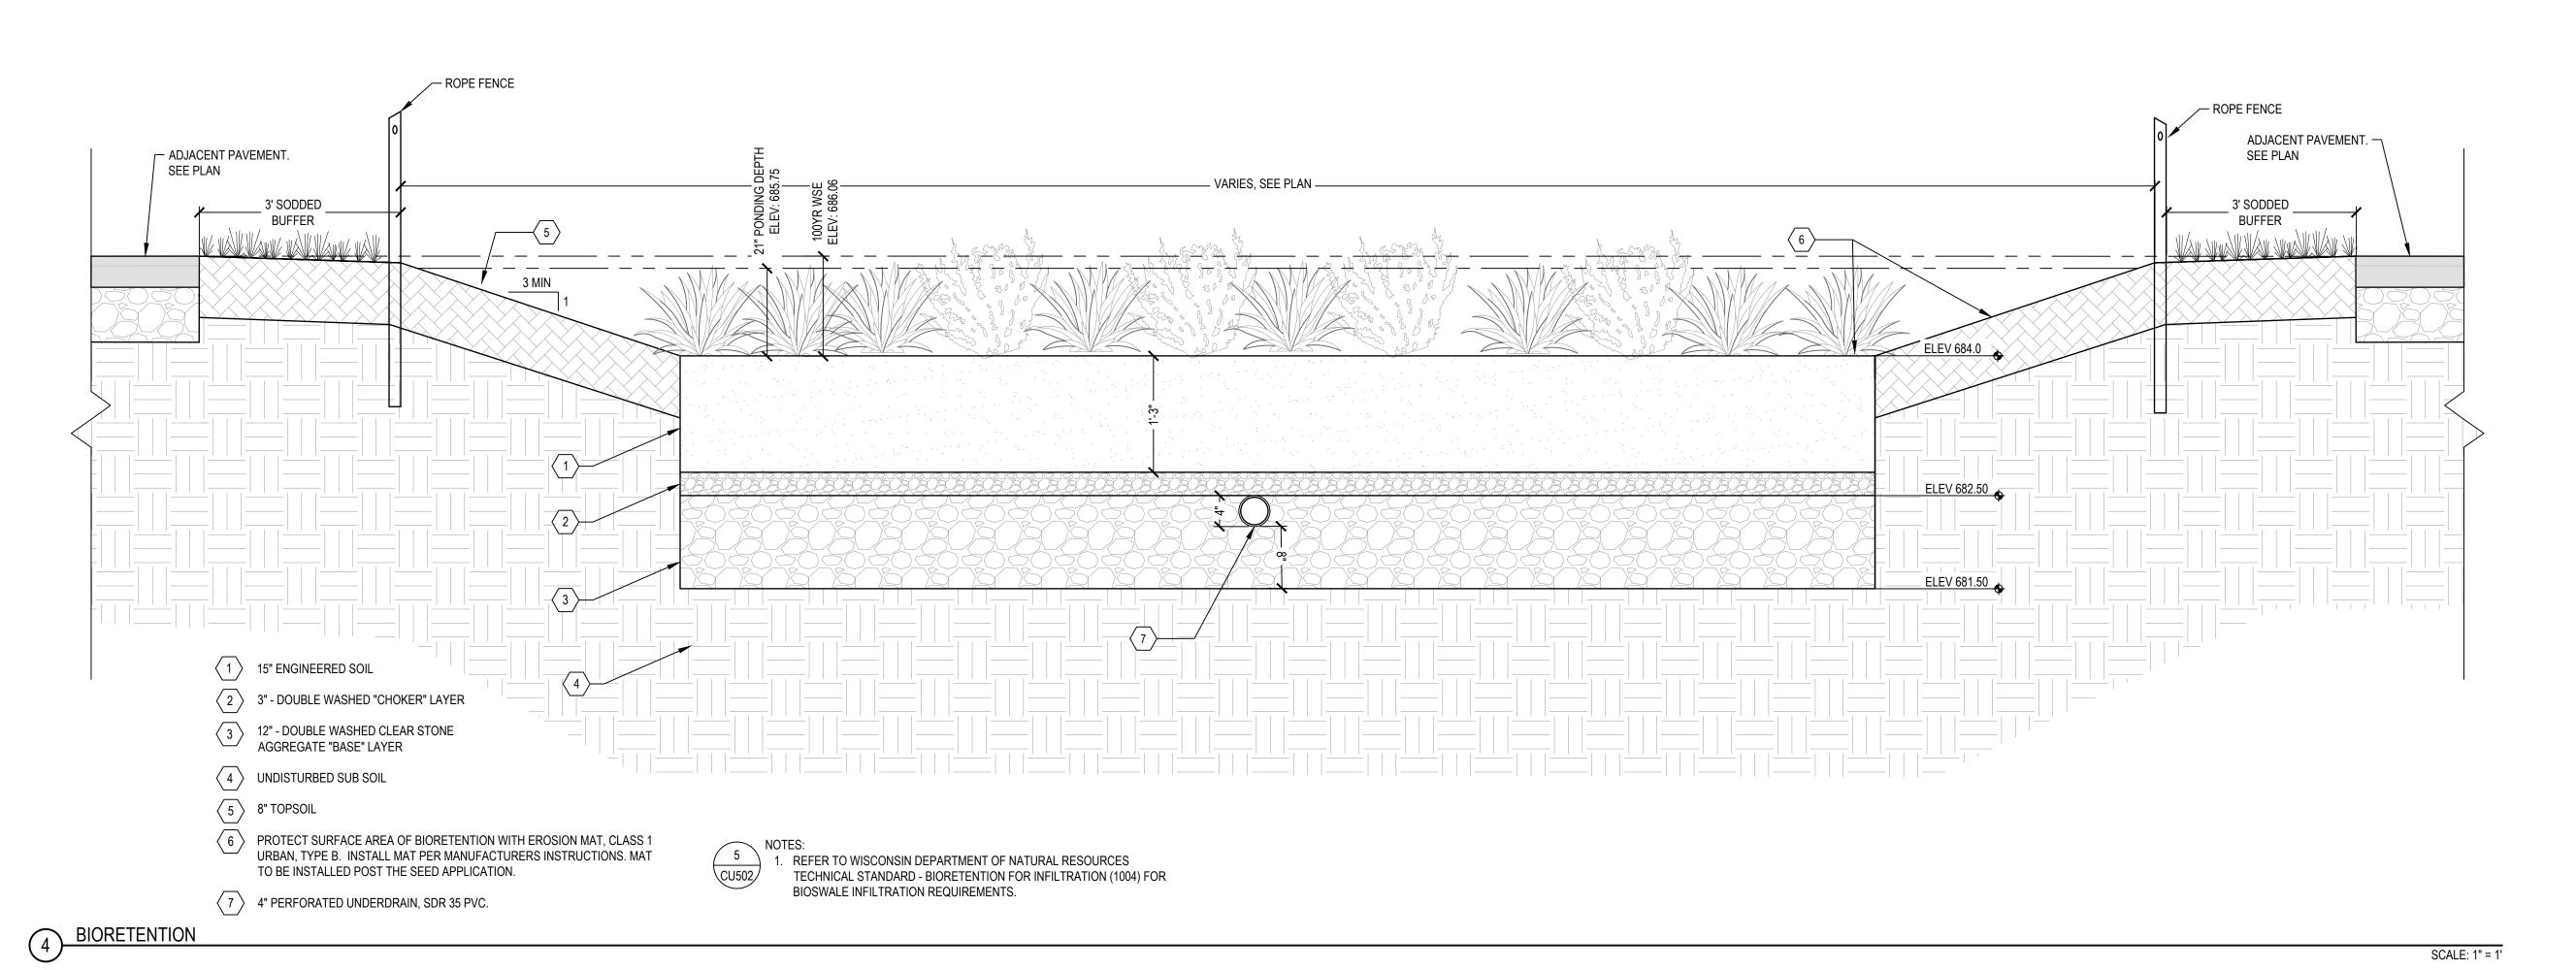

2024 GREEN INFRASTRUCTURE UPGRADES

STORY ELEMENTARY SCHOOL

Owner:

MILWAUKEE
PUBLIC SCHOOLS

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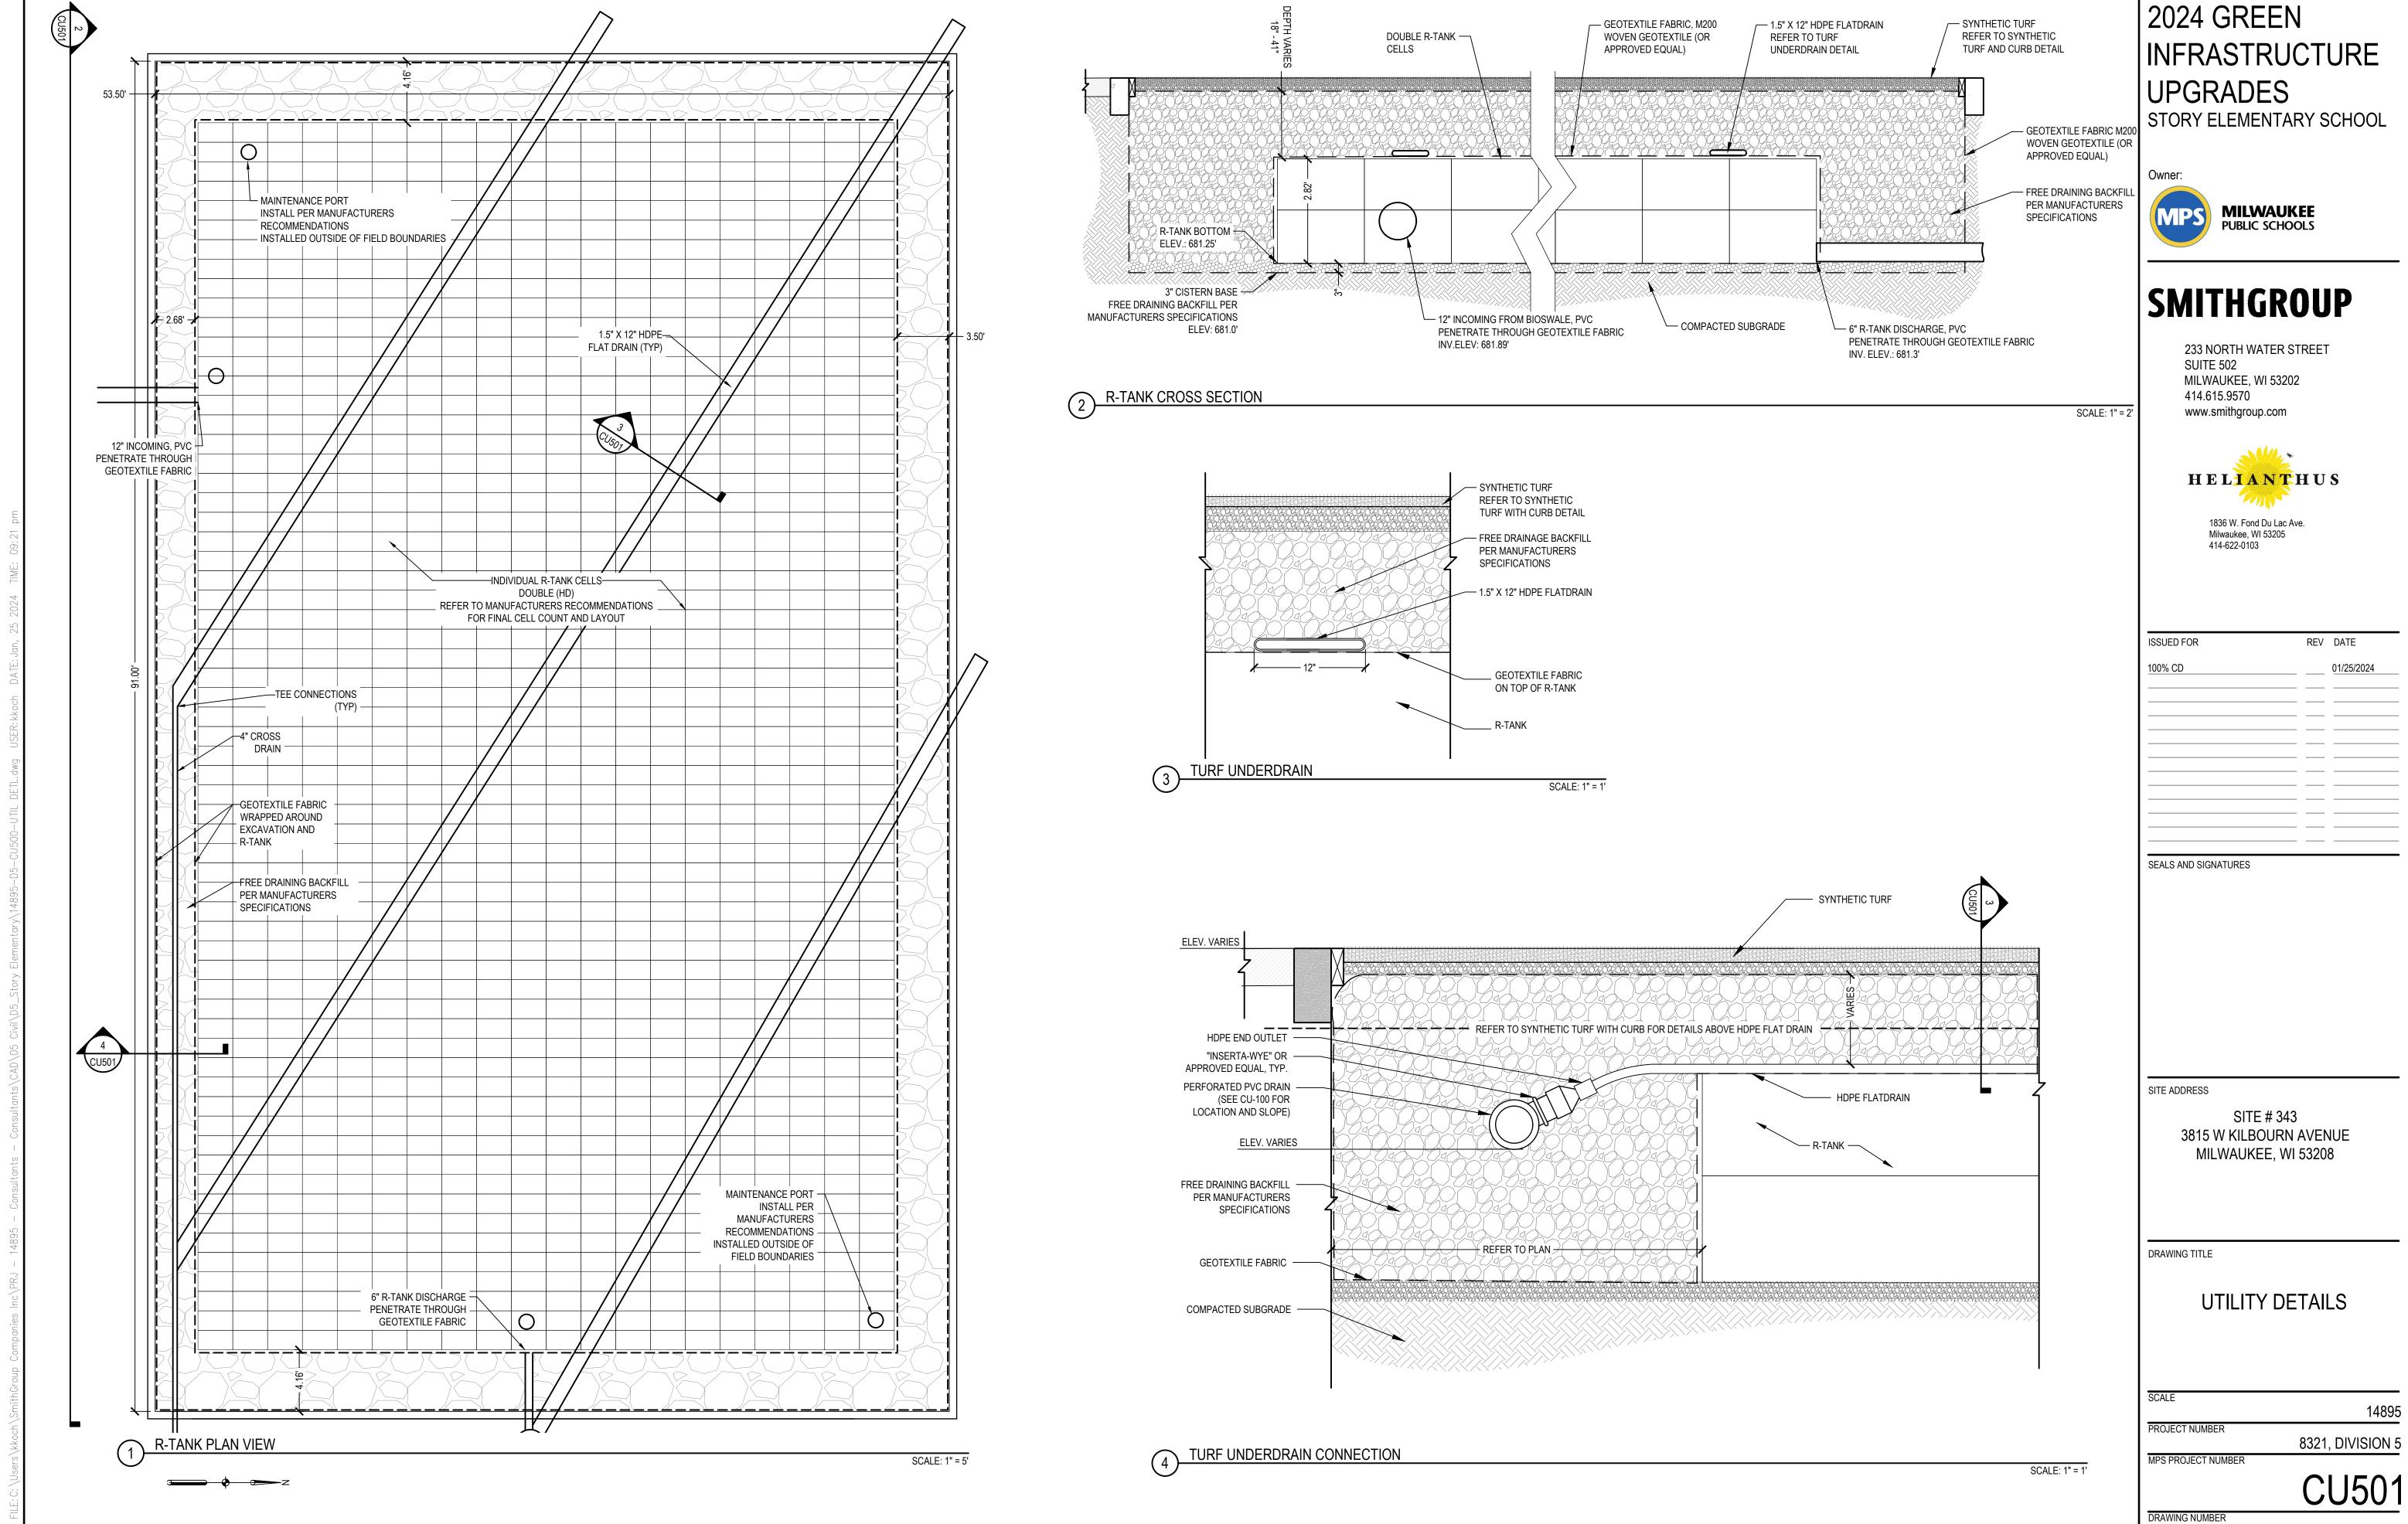
SITE # 343 3815 W KILBOURN AVENUE MILWAUKEE, WI 53208

DRAWING TITLE

UTILITY DETAILS

	CLIEOC
MPS PROJECT NUMBER	
	8321, DIVISION
PROJECT NUMBER	
SCALE	1489
00ALE	


CU500



INFRASTRUCTURE

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SCALE	
00/.=	14895
PROJECT NUMBER	
	8321, DIVISION 5
MPS PROJECT NUMBER	
	C11501

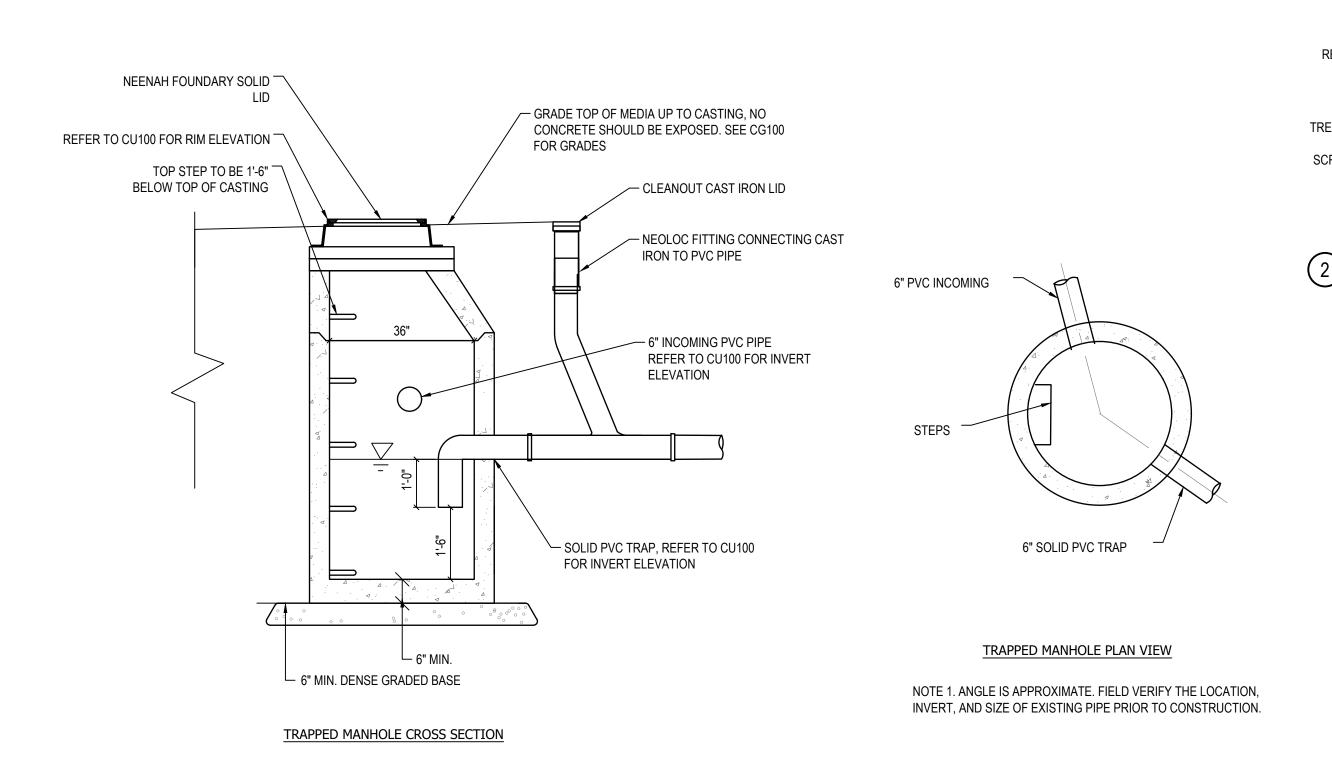

1/2" ----- #4 HORIZONTAL REBAR EPOXY COATED, CONTINUOUS ADHERE TURF TO CENTERED IN CURB CONCRETE BOX AND WOOD COVER PER WIDTH. TURF AND INFILL MIX -MANUFACTURERS - TREATED 2X8 RECOMMENDATION TREATED 2X8 FORM TO REMAIN FLUSH WITH TOP - TREATED 2X4 - #4 HORIZONTAL REBAR LID SUPPORT OF CONCRETE. EPOXY COATED, **∀** 3" MIN 3" MIN / . **USE STAINLESS STEEL** CONTINUOUS. UTILITY MANHOLE FASTENERS @ 6" O.C. STONE BASE 2, ½" MINIMUM, TREATED TREATED 2X4 LID SUPPORT PLYWOOD COVER USE STAINLESS STEEL $2, \frac{1}{2}$ " MINIMUM, TREATED SCREWS TO ATTACHED TO PLYWOOD COVER — CONCRETE BOX, 4000 2X8 @ 9" O.C. PSI @ 28 DAYS - PLACE MAGNETS IN 2 CONCRETE BOX, 4000 -Δ . Δ . Δ . OPPOSING CORNERS MAGNET EMBEDDED IN PSI @28 DAYS OF EACH LID WOOD (TYP) MAINTENANCE PORT -TUR MAINTENANCE COVER PROFILE VIEW TURF MAINTENANCE COVER PLAN VIEW

----- VARIES ---

- VARIES -

TOPSOIL PLACEMENT LENGTH VARIES 18 INCH WIDTH EXTEND 1 FT FILL VOIDS WITH INTO BIOSWALI SET COBBLES **GATOR DUST BELOW TOP OF PIPE** DRAIN PIPE ----AND ACTIVATE - BIOSWALE SURFACE GEOTEXTILE FABRIC ➤ TYPE R GEOTEXTILE **EXISTING GROUND** FABRIC TRIM END OF PIPE TO CONFORM TO SLOPE → BIOSWALE ATTACH STAINLESS STEEL RAT GUARD - 6" TO 10" COBBLE FILL VOIDS WITH EXISTING GROUND **GATOR DUST** AND ACTIVATE **SECTION VIEW PROFILE VIEW**

DRAIN PIPE INTO BIOSWALE COBBLE INLET (MPS STANDARD)

SCALE: 1/2"= 1'-0"

2024 GREEN

UPGRADES

Owner:

SCALE: 1" = 1'

INFRASTRUCTURE

STORY ELEMENTARY SCHOOL

MILWAUKEE

PUBLIC SCHOOLS

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DRAWING TITLE

DRAWING NUMBER

UTILITY DETAILS

SCALE PROJECT NUMBER 8321, DIVISION 5 MPS PROJECT NUMBER

FRAME & GRATE/SOLID COVER 18" MIN THICKNESS ─ 8" MIN THICKNESS GUIDELINE **BOTTOM FLANGE OF** FRAME MUST BE MINIMUM PIPE BURIAL SUPPORTED BY DEPTH PER PIPE CONCRETE COLLAR MANUFACTURER RECOMMENDATION 4" MIN ON 12" - 24" 6" MIN ON 30" & 36" CRUSHED STONE BEDDING 1. REFER TO CU100 FOR SIZE OF DRAIN BASIN AND COVER/GRATE TYPE 2. DESIGN SHOULD ACCOUNT FOR ROOT DEPTH TO ALLOW TURF TO GROW AND PREVENT EROSION AROUND GRATE SO THAT HAZARDS DO NOT FORM. TYPICAL DRAIN BASIN

GENERAL NOTES: 1. SEE SPECIFICATIONS FOR EROSION CONTROL MATTING MATERIAL- MUST BE **BIODEGRADABLE**

2. SEE SPECIFICATIONS FOR FASTENERS- MUST BE BIODEGRADABLE 3. SPACE FASTENERS AS SHOWN (12" HORIZONTALLY/ 36" VERTICALLY)

3.1. FASTENERS TO BE DRIVEN IN AFTER SEAMS ARE OVERLAPPED

3.2. LEAVE 2" BETWEEN ANY EDGE OF MATTING AND FABRIC

MANHOLE (MH1 TRAPPED)

4. CONFIRM PLANT LOCATIONS PRIOR TO CUTTING MAT MATERIAL 5. TREES MUST BE PLANTED PRIOR TO MAT INSTALLATION, HOLD MATTING 4" FROM

SEE PLANTING PLAN FOR LOCATIONS REFER TO TOP ANCHOR 12" SPACING TYP. DETAIL FOR TOP OF SLOPE ATTACHMENT 36" SPACING TYP. INSTALL FASTENERS ON SEAMS AFTER OVERLAPPING - CUT HOLES AFTER PLANT LOCATIONS ARE CONFIRMED OVERLAP SEAMS BY 6"

TOP ANCHOR

ANCHOR TRENCH ·

ANCHOR TRENCH <

EROSION CONTROL MATTING ON SLOPE (MPS STANDARD)

SCALE: 1" = 2'

── EROSION CONTROL MATTING


STEP 2

BIODEGRADABLE STAPLES

— EROSION CONTROL MATTING

COMPACTED BACKFILL

SCALE: 1/2" = 1'-0"

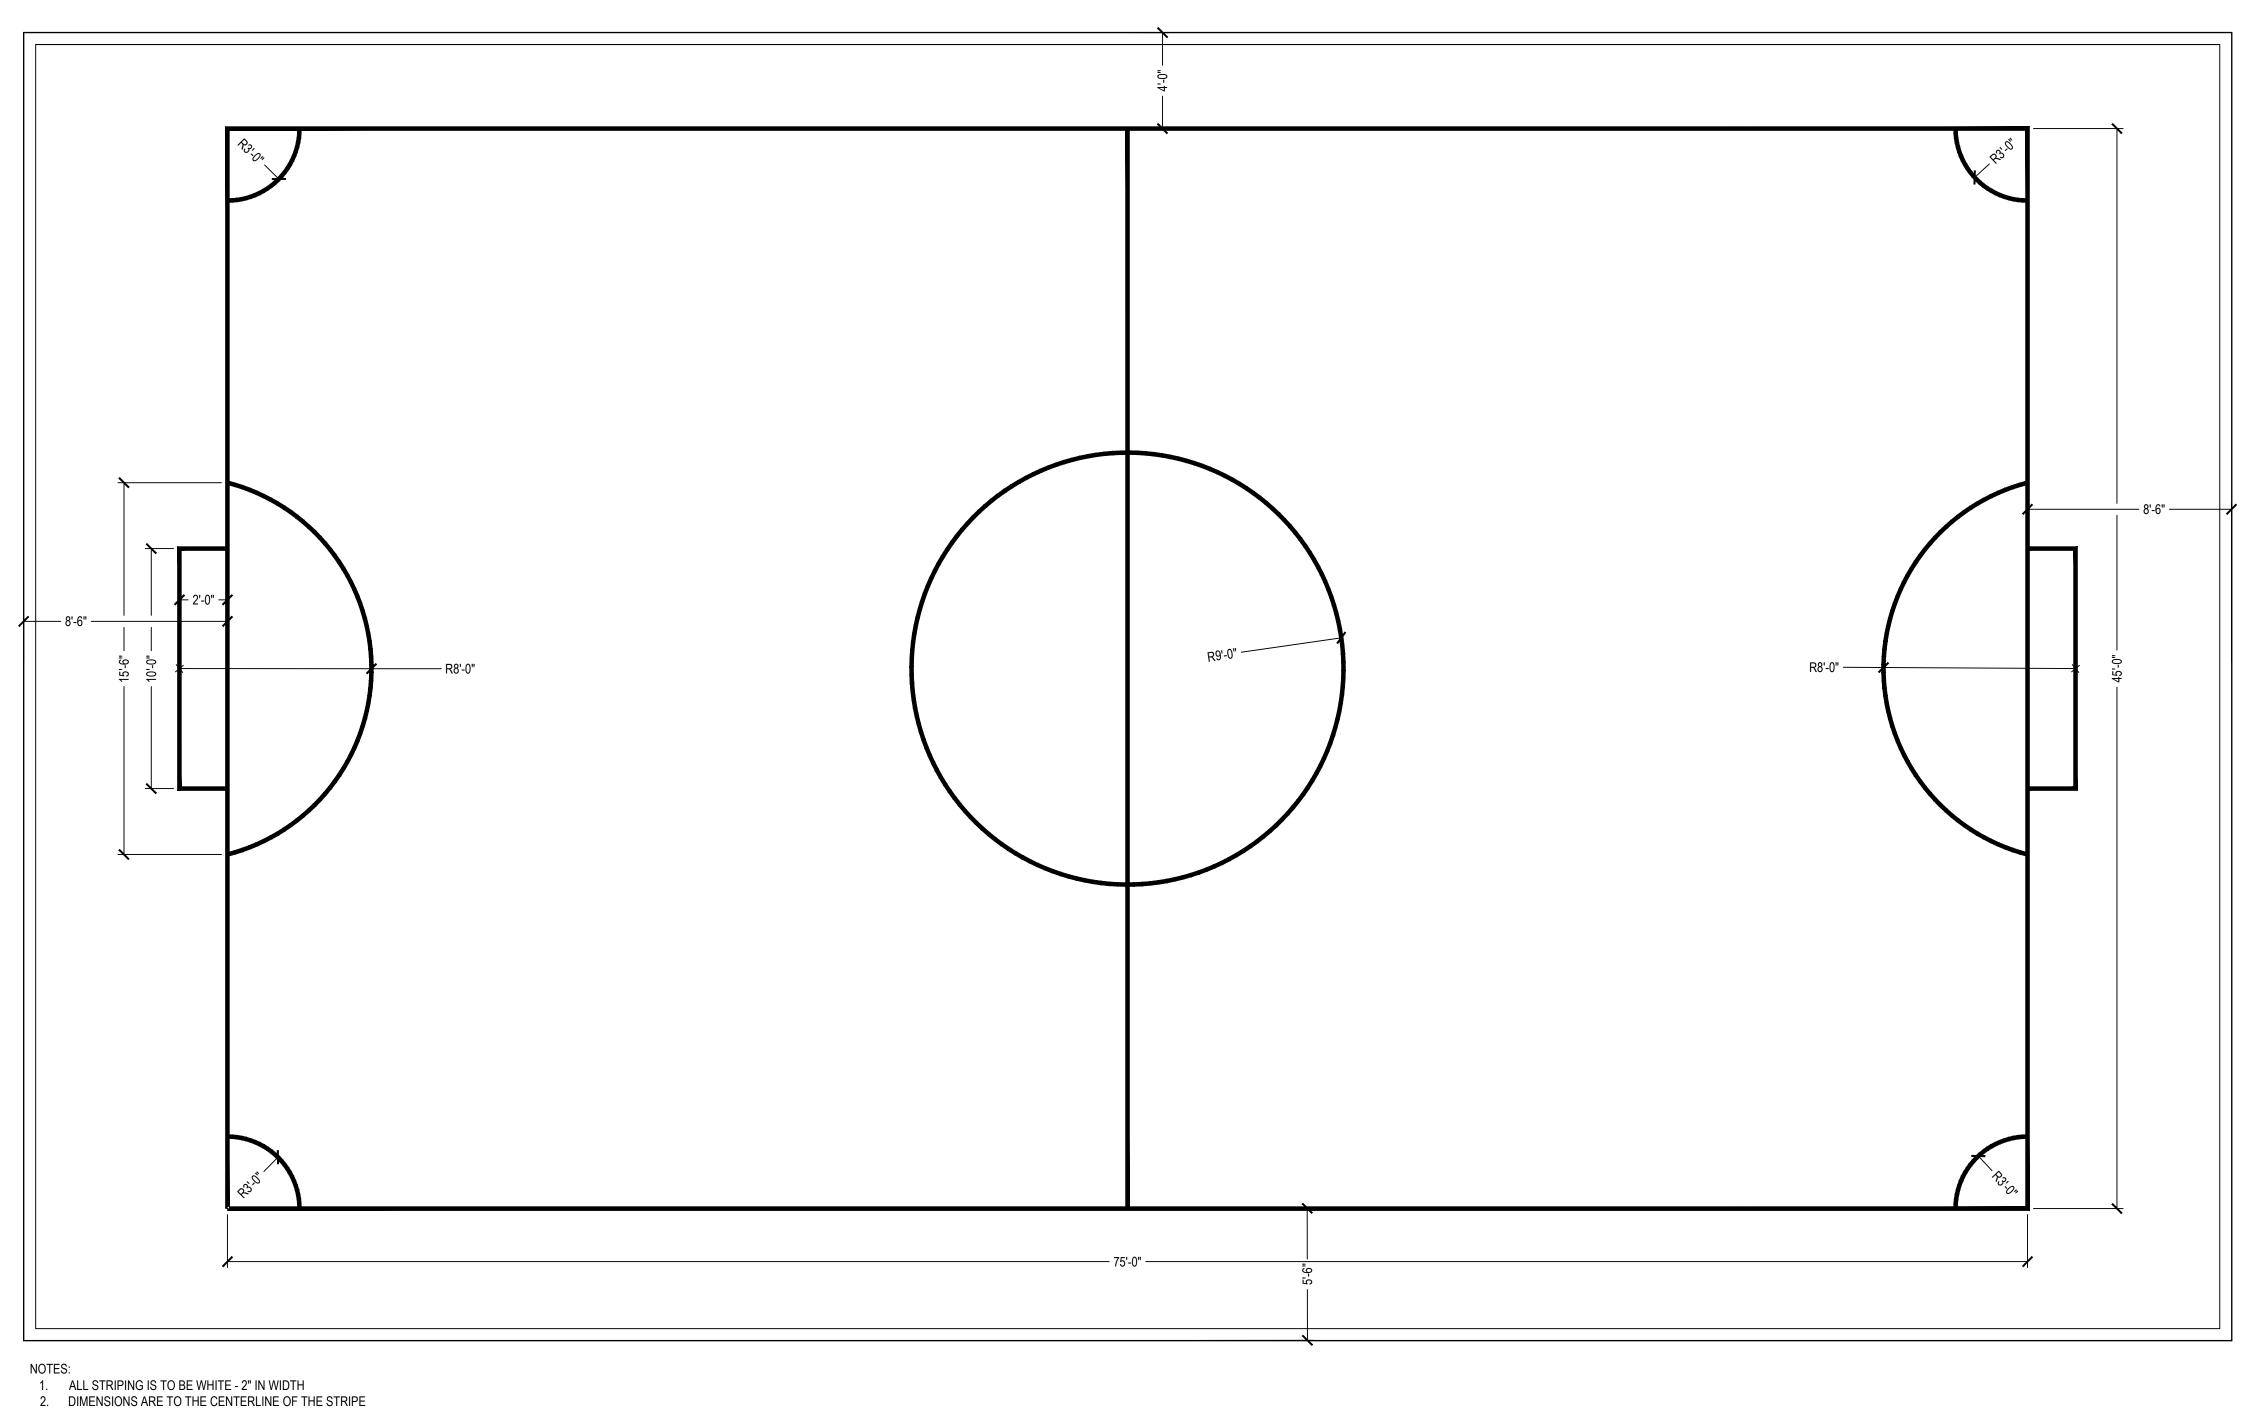

NORTH

SOCCER FIELD

SCALE: 1/4" = 1'

2024 GREEN INFRASTRUCTURE UPGRADES

FOREST HOME AVENUE SCHOOL



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SEALS AND SIGNATURES		

SITE ADDRESS

SITE # 173 1516 W FOREST HOME AVENUE MILWAUKEE, WI 53204

DRAWING TITLE

DRAWING NUMBER

PAVEMENT MARKING **DETAILS**

PROJECT NUMBER	8317, DIVISION
MPS PROJECT NUMBER	CP500

NOTES:

- 1. ALL STRIPING IS TO BE 2" IN WIDTH EXCEPT FOR "HORSE" SOLID CIRCLES. REFER TO CP100 FOR HORSE CIRCLE COLOR AND STRIPING COLOR.
- 2. SAFETY ZONES SHALL BE CLEAR OF ALL VERTICAL OBSTRUCTIONS AND GRADE CHANGES. MATERIAL CHANGES ARE ALLOWABLE, SO LONG AS IT MEETS OTHER CRITERIA.
- 3. SAFETY ZONE DIMENSIONS SHOULD REFER TO LAYOUT SHEET, CS100
- 4. DIMENSIONS INSIDE OF STRIPING UNLESS INDICATED OTHERWISE BY "OUT" IN THE ANNOTATION.
- 5. BASKETBALL HOOP IS MOVEABLE AND ADJUSTABLE. FOUNDATION SHALL BE PER MANUFACTURER'S REQUIREMENTS. VERIFY FOUNDATION LOCATION TO MAINTAIN DIMENSION OF RIM POSITION IN RELATION TO COURT STRIPING.
- 1 HALF BASKETBALL COURT (MPS STANDARD DETAIL)

SCALE: 1/4" = 1'

2024 GREEN INFRASTRUCTURE UPGRADES FOREST HOME AVENUE

Owner:

SCHOOL



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SEALS AND SIGNATURES

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DRAWING TITLE


DRAWING NUMBER


PAVEMENT MARKING DETAILS

PROJECT NUMBER

8317, DIVISION 1

MPS PROJECT NUMBER

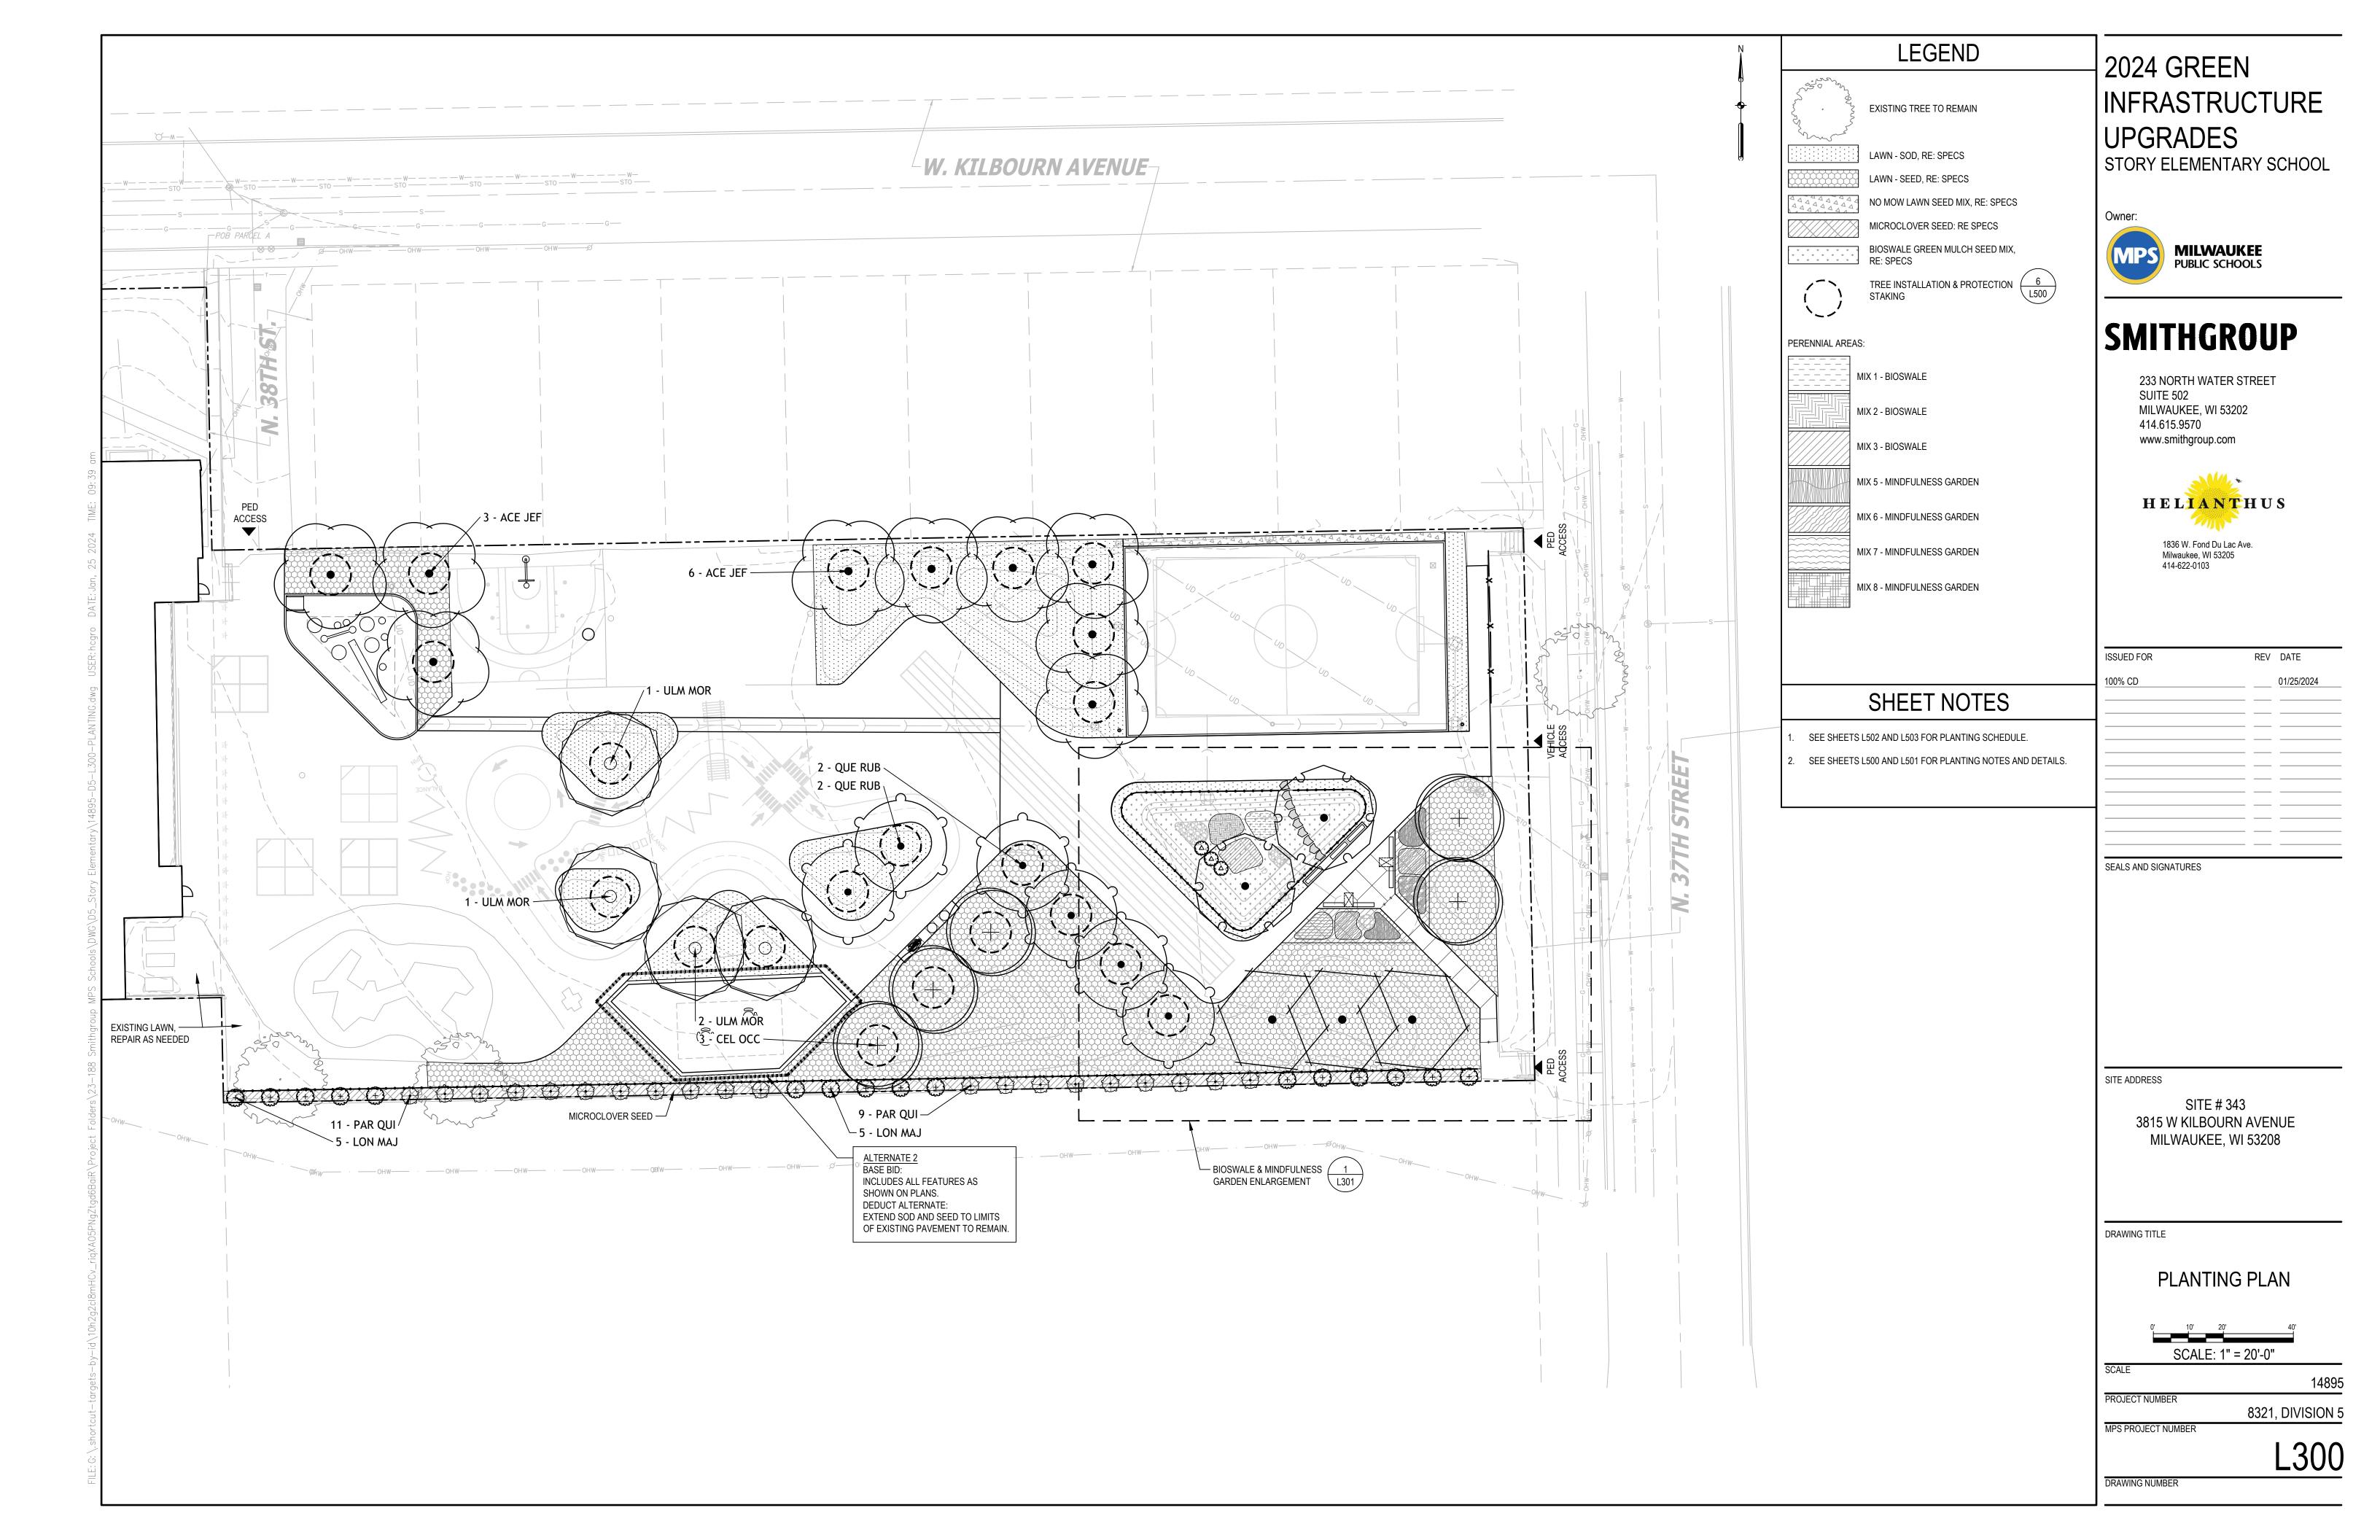

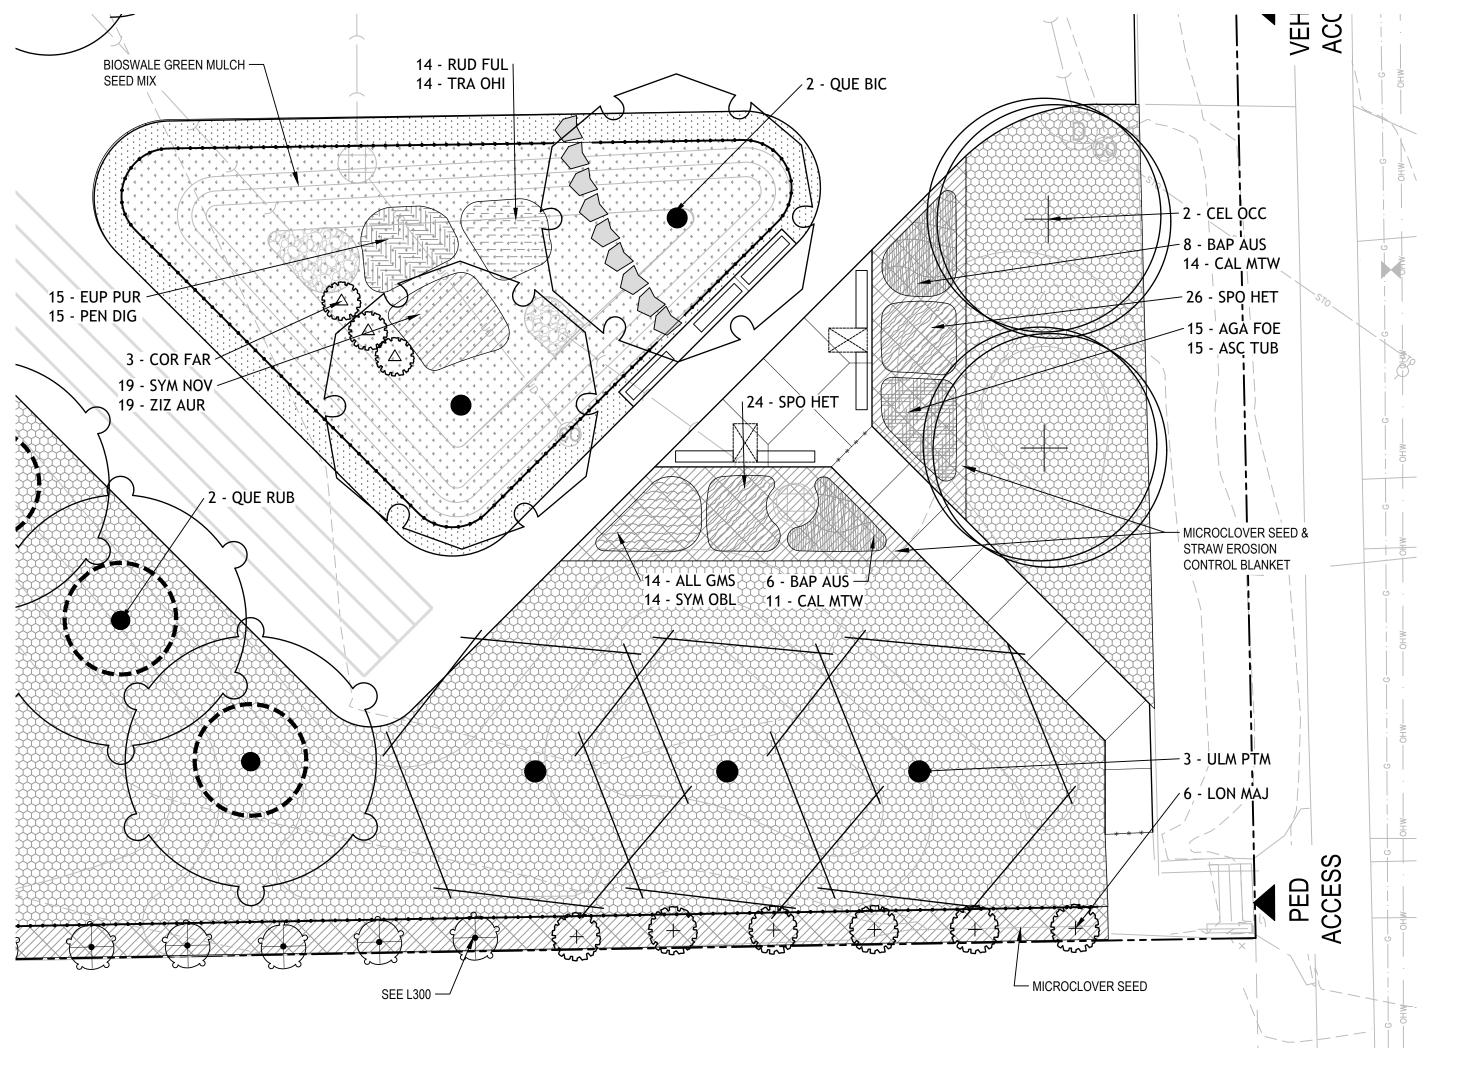

LEGEND

EXISTING TREE TO REMAIN

LAWN - SOD, RE: SPECS

LAWN - SEED, RE: SPECS

NO MOW LAWN SEED MIX, RE: SPECS

MICROCLOVER SEED: RE SPECS

BIOSWALE GREEN MULCH SEED MIX, RE: SPECS

TREE INSTALLATION & PROTECTION

STAKING

6
L500

MIX 2 - BIOSWALE

MIX 3 - BIOSWALE

MIX 5 - MINDFULNESS GARDEN

MIX 6 - MINDFULNESS GARDEN

MIX 7 - MINDFULNESS GARDEN

MIX 8 - MINDFULNESS GARDEN

SHEET NOTES

SEE SHEETS L500 AND L501 FOR PLANTING NOTES AND DETAILS.

SEE SHEETS L502 AND L503 FOR PLANTING SCHEDULE.

- 2024 GREEN INFRASTRUCTURE UPGRADES STORY ELEMENTARY SCHOOL

STORY ELEMENTARY SCI

Owner:

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SEALS AND SIGNATURES

SITE ADDRESS

SITE # 343 3815 W KILBOURN AVENUE MILWAUKEE, WI 53208

DRAWING TITLE

PLANTING PLAN
ENLARGEMENTS

0' 5' 10' 20'

CALE
1
ROJECT NUMBER

8321, DIVISION 5
MPS PROJECT NUMBER

L


DRAWING NUMBER

BIOSWALE & MINDFULNESS GARDEN ENLARGEMENT

SCALE: 1" = 10'-0"

PLANTING NOTES


- CONTRACTOR SHALL INSPECT THE SITE AND BECOME FAMILIAR WITH EXISTING CONDITIONS RELATED TO THE NATURE AND SCOPE OF WORK.
- 2. CONTRACTOR SHALL VERIFY LOCATION OF UNDERGROUND AND ABOVE GROUND UTILITIES AND PROVIDE THE NECESSARY PROTECTION BEFORE CONSTRUCTION BEGINS.
- CONTRACTOR SHALL VERIFY PLAN LAYOUT AND DIMENSIONS SHOWN AND BRING TO THE ATTENTION OF THE PRIME CONSULTANT DISCREPANCIES WHICH MAY COMPROMISE THE DESIGN AND/OR INTENT OF THE PROJECT'S LAYOUT.
- 4. CONTRACTOR SHALL ASSURE COMPLIANCE WITH APPLICABLE CODES AND REGULATIONS GOVERNING THE WORK AND/OR MATERIALS SUPPLIED.
- CONTRACTOR SHALL PROTECT EXISTING ROADS, CURBS/GUTTERS, TRAILS, SIDEWALKS, TREES, LAWNS AND OTHER SITE ELEMENTS DURING CONSTRUCTION OPERATIONS. DAMAGE TO SAME SHALL BE REPAIRED AT NO ADDITIONAL COST TO THE OWNER.
- CONTRACTOR TO MAINTAIN EXISTING GRADE WITHIN THE TREE CANOPY LINE (MINIMUM) OF TREES TO BE PRESERVED AND PROTECTED UNLESS OTHERWISE INDICATED ON THE PLANS. REFERENCE SPECIFICATIONS FOR ADDITIONAL TREE PROTECTION INFORMATION.
- NO PRUNING SHALL BE PERFORMED ON TREES TO BE PRESERVED EXCEPT BY APPROVED ARBORIST.
- 8. NO EQUIPMENT SHALL OPERATE INSIDE THE DRIP LINE (AT MINIMUM) OF TREES TO BE PRESERVED.
- 9. HAND WORK ONLY AND NO MACHINERY OR MATERIAL STORAGE WITHIN DRIP LINE OF TREES TO BE PRESERVED.
- 10. EXISTING TREES TO REMAIN SHALL BE FERTILIZED AND PRUNED TO REMOVE DEAD WOOD, DAMAGED, AND/OR RUBBING BRANCHES.
- 11. CONTRACTOR SHALL COORDINATE THE PHASES OF CONSTRUCTION AND PLANTING INSTALLATION WITH OTHER CONTRACTORS WORKING ON THE SITE.
- 12. CONTRACTOR TO COMPLETE SOIL PREPARATION PER SPECIFICATIONS.
- 13. CONTRACTOR TO SUPPLY AND INSTALL SOD, TREES, SHRUBS, PERENNIALS, GRASSES, PLUGS, AND GROUNDCOVERS.
- 14. PROPOSED PLANT MATERIAL SHALL COMPLY WITH THE LATEST EDITION OF THE AMERICAN STANDARD FOR NURSERY STOCK, ANSI Z60.1 UNLESS NOTED OTHERWISE. DECIDUOUS SHRUBS SHALL HAVE AT LEAST 5 CANES AT THE SPECIFIED HEIGHT. ORNAMENTAL TREES SHALL HAVE NO "V" CROTCHES AND SHALL BEGIN BRANCHING NO LOWER THAN 3 FEET ABOVE ROOT BALL. SHADE TREES SHALL BEGIN BRANCHING NO LOWER THAN 6' ABOVE FINISHED GRADE.
- 15. ALL PLANTS AND TREES SHALL BE PLANTED PER DETAILS AND SPECS.
- 16. ALL TREES, AS IDENTIFIED ON THE PLANS. SHALL BE STAKED AS SHOWN ON THE PLANTING DETAILS UNLESS NOTED OTHERWISE ON THE PLANS.
- 17. NO PLANTS SHALL BE INSTALLED UNTIL FINAL GRADES AND CONSTRUCTION HAS BEEN COMPLETED IN THE IMMEDIATE AREA.
- 18. WHEN QUANTITIES ARE LISTED THEY ARE FOR THE CONTRACTOR'S CONVENIENCE ONLY. ALL COUNTS MUST BE VERIFIED BY THE CONTRACTOR. IN THE CASE OF A DISCREPANCY BETWEEN THE LEGEND AND THE PLAN, PLANTS INDICATED ON THE PLAN SHALL SUPERCEDE QUANTITIES LISTED IN THE LEGEND. SPECIFICATIONS AND DETAILS TAKE PRECEDENCE OVER NOTES.
- 19. NO PLANT MATERIAL SUBSTITUTIONS WILL BE ACCEPTED UNLESS APPROVAL IS REQUESTED OF THE LANDSCAPE ARCHITECT BY THE LANDSCAPE CONTRACTOR PRIOR TO THE SUBMISSION OF BID AND/OR QUOTATION.
- 20. ADJUSTMENTS IN LOCATION OF PROPOSED PLANT MATERIAL MAY BE NEEDED IN FIELD. PRIME CONSULTANT MUST BE NOTIFIED PRIOR TO THE ADJUSTMENT OF PLANTS.
- 21. CONTRACTOR SHALL VERIFY PLANT QUANTITIES SHOWN ON THE PLAN AND PROVIDE A LIST TO THE CLIENT IDENTIFYING THE SPECIES AND SIZES TO BE USED THROUGHOUT THE PROJECT. THE LANDSCAPE ARCHITECT AND THE OWNER'S REPRESENTATIVE RESERVES THE RIGHT TO REJECT ANY SUBSTANDARD PLANT MATERIAL. REJECTED MATERIAL SHALL BE REMOVED FROM THE PROJECT SITE IMMEDIATELY.

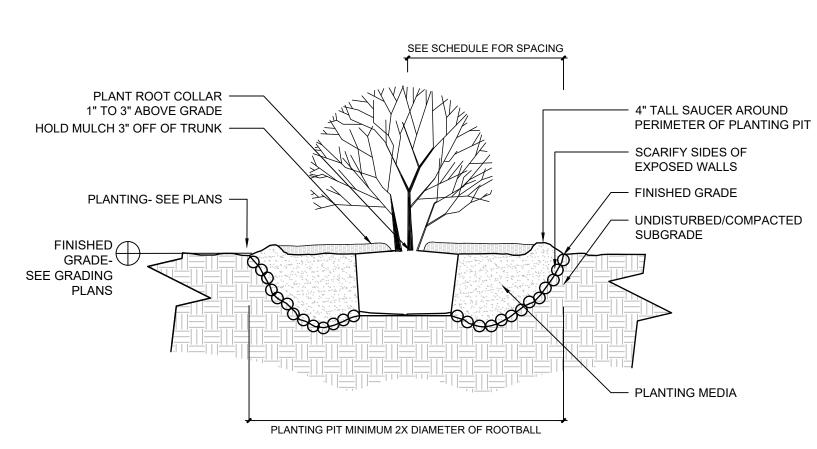

GENERAL NOTES:

- PLANTING SPECIFICATIONS SHALL REFER TO ANY SOIL
- AMENDMENTS REQUIRED PLANTS ARE TO THOROUGHLY WATERED AFTER TRANSPLANTING
- IS COMPLETED- SEE SPECIFICATION FOR FULL WATERING NOTES
- REMOVE BURLAP, WIRE CAGE, AND PLASTIC CONTAINERS (SEE ROOTBALL PREPARATION DETAIL)
- 4. THIS TREE PLANTING DETAIL MEETS THE REQUIREMENTS OUTLINED IN THE WISCONSIN DNR "Developing Planting Specifications'


SHRUB PLANTING NOT TO SCALE

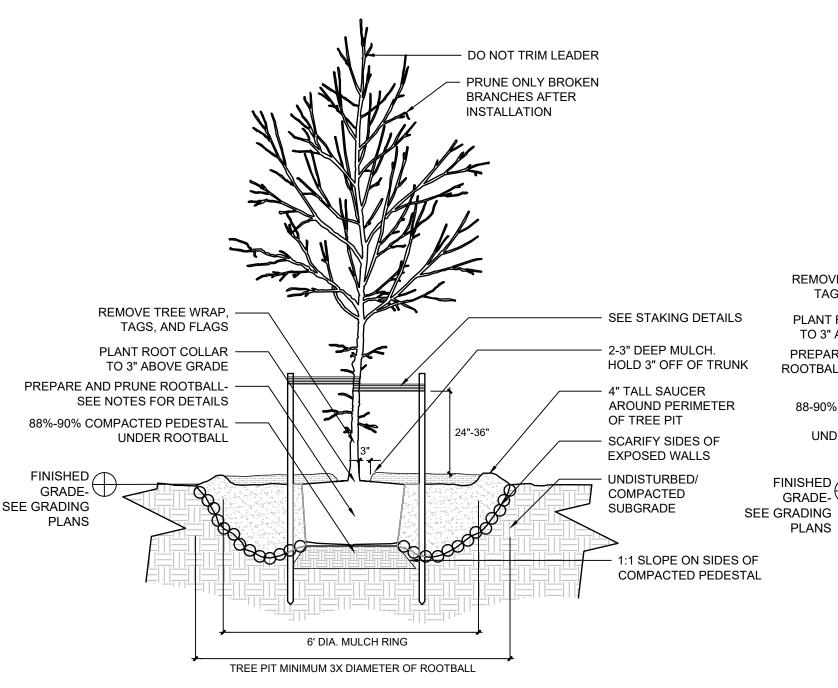

- PLANTING SPECIFICATIONS SHALL REFER TO ANY SOIL AMENDMENTS REQUIRED
- 2. USE TYPICAL TREE STAKING DETAIL UNLESS DESIGNATED AS "TREE INSTALLATION AND PROTECTION STAKING" ON PLANS 3. PLANTS ARE TO THOROUGHLY WATERED AFTER TRANSPLANTING IS COMPLETED-
- SEE SPECIFICATION FOR FULL WATERING NOTES 4. REMOVE BURLAP, WIRE CAGE, AND PLASTIC CONTAINERS (SEE ROOTBALL
- PREPARATION DETAIL) 5. THIS TREE PLANTING DETAIL MEETS THE REQUIREMENTS OUTLINED IN THE
- WISCONSIN DNR "Developing Planting Specifications' (2006)
- 6. USE EXISTING SOIL REMOVED FROM HOLE AS BACK FILL. USE 2/3 PARTS EXISTING SOIL AND 1/3 IMPORTED TOPSOIL. FERTILIZE WITH A 20-10-5 TREE PLANTING TABLET PER THE MANUFACTURER'S RECOMMENDED RATES. DO NOT PLACE TABLETS IN THE BOTTOM OF THE HOLE

DECIDUOUS TREE PLANTING NOT TO SCALE



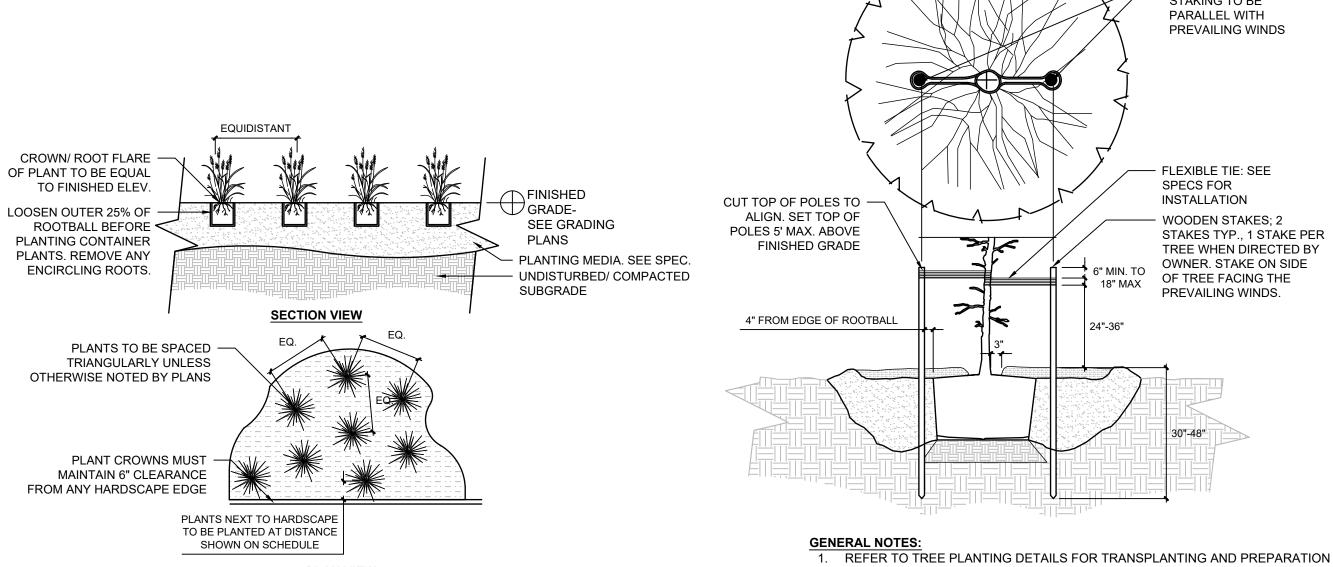


TREE STAKING PLAN VIEW


PLAN VIEW

- **GENERAL NOTES:** 1. IF PLUGS ARE TO BE INSTALLED IN EROSION MATTING- CUT MATTING PRIOR TO PLANTING. SEEDING TO OCCUR PRIOR TO INSTALLING
- **EROSION MATTING** 2. SEE PLANTING SCHEDULE FOR GROUNDCOVER SPECIES AND
- SPACING
- 3. SETTLE SOIL AROUND ROOT BALL AROUND EACH SPECIMEN BY THOROUGHLY WATERING



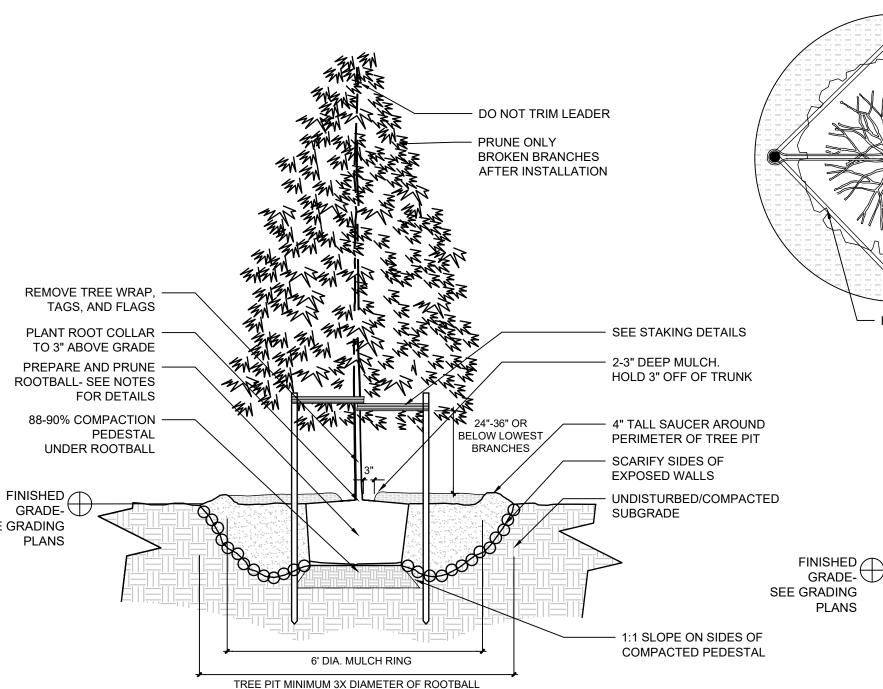

- PLANTING SPECIFICATIONS SHALL REFER TO ANY SOIL AMENDMENTS REQUIRED 2. USE TYPICAL TREE STAKING DETAIL UNLESS DESIGNATED AS "TREE INSTALLATION
- AND PROTECTION STAKING" ON PLANS 3. PLANTS ARE TO THOROUGHLY WATERED AFTER TRANSPLANTING IS COMPLETED-
- SEE SPECIFICATION FOR FULL WATERING NOTES
- 4. REMOVE BURLAP, WIRE CAGE, AND PLASTIC CONTAINERS (SEE ROOTBALL
- PREPARATION DETAIL)
- 5. THIS TREE PLANTING DETAIL MEETS THE REQUIREMENTS OUTLINED IN THE
- WISCONSIN DNR "Developing Planting Specifications' (2006) 6. USE EXISTING SOIL REMOVED FROM HOLE AS BACK FILL. USE 2/3 PARTS EXISTING SOIL AND 1/3 IMPORTED TOPSOIL. FERTILIZE WITH A 20-10-5 TREE PLANTING TABLET
- PER THE MANUFACTURER'S RECOMMENDED RATES. DO NOT PLACE TABLETS IN THE BOTTOM OF THE HOLE

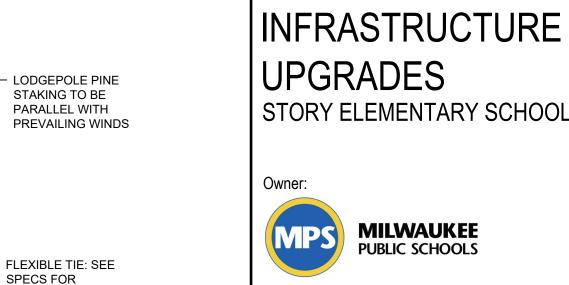

INSTALLATION

2. USE TYPICAL TREE STAKING DETAIL UNLESS DESIGNATED AS "TREE INSTALLATION

6. THIS TREE PLANTING DETAIL MEETS THE REQUIREMENTS OUTLINED IN THE

7. LODGEPOLES TO BE DRIVEN TO DEPTH SUFFICIENT TO WITHSTAND MODERATE

FORCE BY AN ADULT PUSHING ON ANY SIDE WITHOUT DEFLECTING MORE THAN 4"

TREE TIES

ROOTBALL.

MULCH RING BELOW

4 LODGEPOLE PINE TREE STAKES.

INSTALL APROX. 4" OUTSIDE OF

AND PROTECTION STAKING" ON PLANS

STAKES SHALL BE LEVEL WITH ANOTHER

DO NOT OVERLY TIGHTEN TIES

NOT TO SCALE

STAKING PLAN VIEW- NO SCALE

SEE SPECIFICATION FOR STAKING REMOVAL INFORMATION

WISCONSIN DNR "Developing Planting Specifications' (2006)

TYPICAL TREE STAKING

WOODEN STAKES; 2

STAKES TYP., 1 STAKE PER

TREE WHEN DIRECTED BY

OWNER. STAKE ON SIDE

OF TREE FACING THE

PREVAILING WINDS.

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2024 GREEN

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SITE ADDRESS

- 1" NYLON ROPE-

WHITE. STAPLE

WRAP TIGHTLY

TO STAKE OR

— STAKE

SITE # 343 3815 W KILBOURN AVENUE MILWAUKEE, WI 53208

DRAWING TITLE

PLANTING NOTES & DETAILS

SCALE PROJECT NUMBER 8321, DIVISION 5 MPS PROJECT NUMBER

DRAWING NUMBER

TREE INSTALLATION & PROTECTION STAKING

1. REFER TO TREE PLANTING DETAILS FOR TRANSPLANTING AND PREPARATION

2. USE TYPICAL TREE STAKING DETAIL UNLESS DESIGNATED AS "TREE

5. DO NOT OVERLY TIGHTEN NYLON ROPE, 1-4" OF SLACK IS PREFERRED

MODERATE FORCE BY AN ADULT PUSHING ON ANY SIDE WITHOUT

7. LODGEPOLES TO BE DRIVEN TO DEPTH SUFFICIENT TO WITHSTAND

6. THIS TREE PLANTING DETAIL MEETS THE REQUIREMENTS OUTLINED IN THE

INSTALLATION AND PROTECTION STAKING" ON PLANS

4. SEE SPECIFICATION FOR STAKING REMOVAL INFORMATION

WISCONSIN DNR "Developing Planting Specifications' (2006)


3. STAKES SHALL BE LEVEL WITH ANOTHER

DEFLECTING MORE THAN 4"


PROCEDURES

NOT TO SCALE


 SHAVE ROOT BALL HERE TO REMOVE ALL ROOTS GROWING ON PERIPHERY

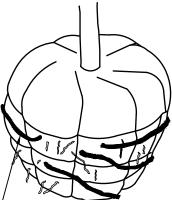

- REMOVE STRUCTURAL ROOTS OUTSIDE OF BURLAP. ROOTS LESS THAN $\frac{1}{4}$ " IN DIAMETER MAY REMAIN

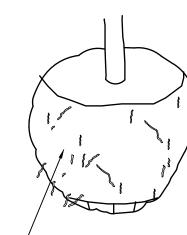

- PEEL BACK BURLAP AND FULLY REMOVE OFF SIDES. CUT WIRE CAGE AND REMOVE OFF SIDES.

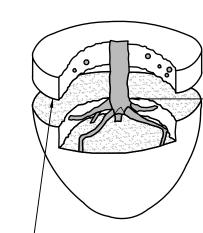

ROOT FLARE


 GENTLY REMOVE SOIL OFF OF ROOTBALL SO THAT THE TOP OF THE ROOT FLARE IS EXPOSED.

1. ALL PLANTS MUST HAVE BURLAP AND WIRE CAGE REMOVED FROM THE SIDES OF THE ROOTBALL. 2. FOR CONTAINER PLANTS, PLASTIC CONTAINERS MUST BE FULLY REMOVED.


<u>DNR NOTES:</u> THIS PLANTING DETAIL CONFORMS TO TREE PLANTING GUIDELINES AS SPECIFIED IN DNR DOCUMENT 'DEVELOPING PLANTING SPECIFICATIONS' REVISED 10.25.

ROOT BALL PREPARATION

NOT TO SCALE

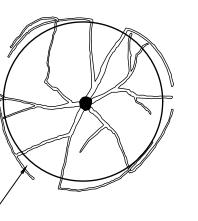

ROOTBALL $\frac{1}{2}$ " - 1".

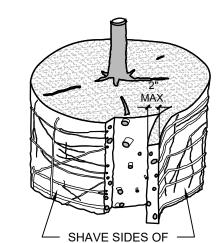


ROOT TIPS EXPOSED ON SIDES OF ROOT BALL. ALL ROOTS


GROWING AROUND SIDES TO BE REMOVED

- 1- SHAVING TO BE CONDUCTED USING A CLEAN, SHARP BLADE OR HANDSAW.
- 2- BLADE MUST BE CLEANED AND STERILIZED BETWEEN ROOT SHAVINGS/ 3- ROOT PRUNING ONLY TO OCCUR AT NURSERY OR IMMEDIATELY PRIOR TO TRANSPLANTING TO FINAL
- LOCATION. 4- ONLY SHAVE 15 GAL. CONTAINER PLANTS AND LARGER, INCLUDING BALLED AND BURLAPPED PLANTS.
- 5- FOR PLANT POTS UNDER 15 GAL., AGITATE ROOTS PRIOR TO PLANTING
- <u>DNR NOTES:</u> THIS PLANTING DETAIL CONFORMS TO TREE PLANTING GUIDELINES AS SPECIFIED IN DNR DOCUMENT 'DEVELOPING PLANTING SPECIFICATIONS' REVISED 10.25.

ROOT BALL PRUNING

NOT TO SCALE

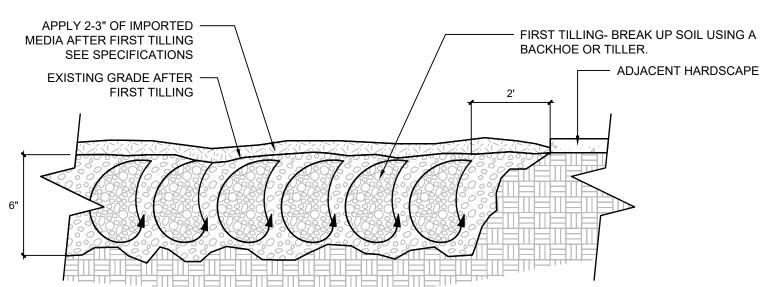

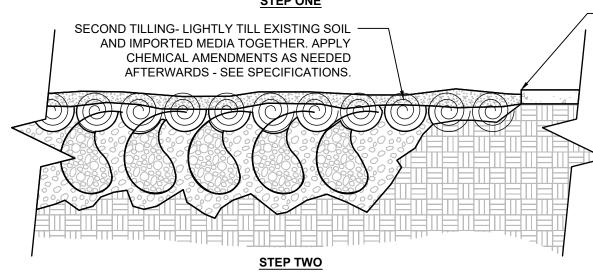

- FINISHED GRADE TO BE AT GRADE WITH ADJACENT PAVEMENT IF NO FURTHER TREATMENT REQUIRED. IF MULCHING, THEN FINISHED GRADE IS TO BE 3" BELOW ADJACENT PAVEMENT.

GENERAL NOTES:

1. IF SOILS ARE AMENDED MORE THAN 1 WEEK PRIOR TO TRANSPLANTING OR MULCHING THEN COVER SURFACE WITH FABRIC OR MATTING
2. SEE SPECIFICATIONS FOR INFORMATION ON CHEMICAL AMENDMENT AND IMPORTED

- 3. AREAS OF CHEMICAL AMENDMENT AND IMPORTED MEDIA SHOULD BE INDICATED ON
- 4. ALL PLANTS ARE TO BE INSTALLED AFTER SOIL AMENDMENTS



SOIL AMENDMENT

NOT TO SCALE

2024 GREEN INFRASTRUCTURE UPGRADES STORY ELEMENTARY SCHOOL

Owner:

SMITHGROUP

MILWAUKEE

PUBLIC SCHOOLS

233 NORTH WATER STREET SUITE 502 MILWAUKEE, WI 53202 414.615.9570 www.smithgroup.com



1836 W. Fond Du Lac Ave. Milwaukee, WI 53205 414-622-0103

ISSUED FOR	REV	DATE
100% CD		01/25/2024
100 % OB	$\overline{}$	01/20/2024
l		

SITE ADDRESS

SEALS AND SIGNATURES

SITE # 343 3815 W KILBOURN AVENUE MILWAUKEE, WI 53208

DRAWING TITLE

PLANTING DETAILS

SCALE PROJECT NUMBER 8321, DIVISION 5 MPS PROJECT NUMBER

BIOSWALE GREEN MULCH SEED MIX

* * * * *

		PLS
Botanical Name	Common Name	Ounces/Acre
Cover Crop:		
Regreen	Regreen Winter Wheat	160
Grasses & Sedges:		
Carex brevior	Plains Oval Sedge	6
Carex bromoides	Brome Hummock Sedge	8
Carex vulpinoidea	Brown Fox Sedge	16
Penstemon digitalis	Foxglove Beardtongue	2
Rudbeckia hirta	Black-eyed Susan	3
Sporobolus heterolepis	Prairie Dropseed	36
	Total	231
	LBS	14.44

PLANT SCHEDULE

SYMBOL	CODE	BOTANICAL / COMMON NAME	CONT	PLANTING SIZE	MATURE HT	MATURE SP	<u>QTY</u>
TREES							
	ACE JEF	Acer x freemanii `Jeffsred` / Autumn Blaze Maple	B & B	2.5" Min. Cal.	50`	40`	9
+	CEL OCC	Celtis occidentalis / Common Hackberry	B & B	2.5" Min. Cal.	60,	60'	5
	QUE BIC	Quercus bicolor / Swamp White Oak	B & B	2.5" Min. Cal.	75`	65`	2
	QUE RUB	Quercus rubra / Red Oak	B & B	2.5" Min. Cal.	75`	75`	6
	ULM MOR	Ulmus x `Morton Accolade` / Accolade Elm	B & B	2.5" Min. Cal.	70`	70`	4
•	ULM PTM	Ulmus x 'Morton Glossy' / Triumph™ Elm	B & B	2.5" Min. Cal.	60`	45`	3
SHRUBS							
Exercise Services	COR FAR	Cornus sericea 'Farrow' / Arctic Fire® Red Twig Dogwood	3 gal	Container	4`	4`	3

2024 GREEN INFRASTRUCTURE UPGRADES

STORY ELEMENTARY SCHOOL

Owner



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	_	
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SITE ADDRESS

SEALS AND SIGNATURES

SITE # 343 3815 W KILBOURN AVENUE MILWAUKEE, WI 53208

DRAWING TITLE

PLANTING SCHEDULE

3 FROJECT NOWIDER	L502
OJECT NUMBER PS PROJECT NUMBER	8321, DIVISION 5
ALE	14895

PLANT SCHEDULE

\/	IN	FC
V	ΗN	

LON MAJ Lonicera sempervirens 'Major Wheeler' / Major Wheeler Trumpet Honeysuckle 1 gal

Pot

16

SMITHGROUP

2024 GREEN

UPGRADES

Owner:

INFRASTRUCTURE

STORY ELEMENTARY SCHOOL

MILWAUKEE PUBLIC SCHOOLS

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ISSUED FOR	REV	DATE
100% CD		01/25/2024
	_	

SITE ADDRESS

SEALS AND SIGNATURES

SITE # 343 3815 W KILBOURN AVENUE MILWAUKEE, WI 53208

DRAWING TITLE

DRAWING NUMBER

PLANTING SCHEDULE

	L503
IPS PROJECT NUMBER	
	8321, DIVISION
ROJECT NUMBER	
OALE	1489
CALE	

PAR QUI Parthenocissus quinquefolia / Virgina Creeper 1 gal Pot 20 SYMBOL BOTANICAL / COMMON NAME CONT PLANTING SIZE **MATURE HT** MATURE SP QTY CODE SPACING PERENNIAL AREAS 60 sf MIX 1 - BIOSWALE Rudbeckia fulgida / Coneflower 50% @ 18" o.c. RUD FUL PLUG 32-CELL FLAT OR EQUIVALENT 3 14 TRA OHI Tradescantia ohiensis / Spiderwort PLUG 32-CELL FLAT OR EQUIVALENT 2 1.5` 50% @ 18" o.c. 14 67 sf MIX 2 - BIOSWALE EUP PUR Eupatorium purpureum / Savannah Joe-Pye Weed PLUG 50% @ 18" o.c. 15 32-CELL FLAT OR EQUIVALENT 6° Penstemon digitalis / Beard-tongue PEN DIG 1.5` 15 PLUG 32-CELL FLAT OR EQUIVALENT 3 50% @ 18" o.c. MIX 3 - BIOSWALE 84 sf Symphyotrichum novae-angliae / New England Aster 50% @ 18" o.c. SYM NOV PLUG 32-CELL FLAT OR EQUIVALENT 19 50% @ 18" o.c. 19 2` ZIZ AUR Zizia aurea / Golden Alexander PLUG 32-CELL FLAT OR EQUIVALENT 2 104 sf MIX 5 - MINDFULNESS GARDEN Baptisia australis / Blue Wild Indigo 50% @ 24" o.c. 14 **BAP AUS** 2.5` Container 50% @ 18" o.c. CAL MTW Calamintha nepeta 'Montrose White' / Montrose White Lesser Calamint 1.5` 25 Container 109 sf MIX 6 - MINDFULNESS GARDEN Sporobolus heterolepis / Prairie Dropseed 32-CELL FLAT OR EQUIVALENT SPO HET PLUG 18" o.c. 50 59 sf MIX 7 - MINDFULNESS GARDEN Allium giganteum 'Globemaster' / Globemaster Giant Allium 50% @ 18" o.c. ALL GMS 1.5` 1.5` 14 Bulb 32-CELL FLAT OR EQUIVALENT Symphyotrichum oblongifolium / Aromatic Aster 50% @ 18" o.c. PLUG 1.5` 14 SYM OBL MIX 8 - MINDFULNESS GARDEN 63 sf Agastache foeniculum / Blue Giant Hyssop 50% @ 18" o.c. PLUG AGA FOE 32-CELL FLAT OR EQUIVALENT 3 Asclepias tuberosa / Butterfly Milkweed 50% @ 18" o.c. PLUG 32-CELL FLAT OR EQUIVALENT 2